

- A. TECHNOLOGY DRAWINGS ARE DIAGRAMMATICAL AND MAY NOT ACCURATELY REFLECT ACTUAL CONSTRUCTION CONDITIONS. THE TECHNOLOGY CONTRACTOR SHALL BE RESPONSIBLE FOR COORDINATING THE INSTALLATION OF ALL TECHNOLOGY EQUIPMENT, WITH ALL TRADES PRIOR TO AND DURING CONSTRUCTION.
- B. TECHNOLOGY ENTRANCE LOCATION DESIGN IS BASED ON INFORMATION PROVIDED BY THE UTILITY THRU THE DESIGN PROCESS. HOWEVER IT IS UP TO THE CONTRACTOR TO VERIFY CONDITIONS AND REQUIREMENTS HAVE NOT CHANGED PRIOR TO THE INSTALLATION DATE.
- C. COORDINATE WITH LOCAL UTILITY PROVIDER FOR EXACT SERVICE CONDUIT SIZES AND LOCATION TO ROUTE TO CONDUIT TO.
- D. CUSTOMER TO PROVIDE ALL TRENCHING AND BACKFILLING. TRENCH TO BE 36 INCHES DEEP AND 30 INCHES WIDE, MEASURED FROM FINAL GRADE.
- E. THE TECHNOLOGY CONTRACTOR SHALL REFER TO THE ARCHITECTURAL DRAWINGS FOR ALL MOUNTING HEIGHTS AND FINISHES OF DEVICES AND FIXTURES.
- F. COORDINATE WITH MECHANICAL PLANS FOR LOCATIONS OF SMOKE, FIRE/SMOKE DAMPERS, AND ROOF TOP UNITS REQUIRING CONNECTION TO FIRE ALARM SYSTEM.
- G. FOR VOICE/DATA OUTLETS PROVIDE A SINGLE GANG MUD-RING WITH A 1" CONDUIT FROM THE TOP OF THE MUD-RING TO ACCESSIBLE CEILING SPACE. TERMINATE CONDUIT WITH END CONNECTORS AND THREAD ON PLASTIC BUSHING FOR CABLE PROTECTION. OUTLET SHALL BE AT THE SAME HEIGHT AS ADJACENT POWER OUTLET AND LESS THAN 18" SEPARATION. COORDINATE WITH ELECTRICAL.
- H. COORDINATE ALL DEVICE LOCATIONS WITH LATEST ARCHITECTURAL INTERIOR ELEVATIONS TO VERIFY DEVICES WILL NOT BE OBSTRUCTED.
- I. REFER TO ENLARGED TYPICAL UNIT PLANS (IF PROVIDED) FOR TYPICAL LAYOUTS FOR ALL APARTMENT UNIT TYPES.

	$> N \qquad $	1 E		
	FIRE ALARM SYMBOLS		SECURITY SYMBOLS	
F	FIRE ALARM MANUAL PULL STATION, +48" A.F.F.	$\Box \forall$	CCTV CAMERA	A.F.F.
Μ	MAGNETIC DOOR HOLDER		DOME CAMERA (W/ PTZ OR FIX)	APP.
⊡–	SMOKE DETECTOR, DUCT, IONIZATION TYPE W/SAMPLING TUBE	- 112		С
ℙ─	SMOKE DETECTOR, DUCT, PHOTO TYPE W/SAMPLING TUBE	⊡<`X'	INTRUSION SENSOR ('X' INDICATES DEG. OF COVERAGE)	C.O.
0	SMOKE DETECTOR, IONIZATION TYPE	G.B.	GLASS BREAK SENSOR	CATV
P	SMOKE DETECTOR, PHOTO TYPE	D	DOOR POSITION SENSOR	CCTV
θ	HEAT DETECTOR, RATE-OF-RISE OR FIXED TEMP.	K	KEYPAD +48" A.F.F.	CLG
\oslash	FIRE MAIN FLOW DETECTION SWITCH	C.R.	PROXIMITY CARD READER +48" A.F.F.	(E)
	FIRE MAIN TAMPER DETECTION SWITCH	E.L.	ELECTRIC LATCH/LOCK	FACP
C F	FIRE ALARM BELL, +80" A.F.F., U.O.N.	REX	REQUEST TO EXIT DEVICE	FP
EZ →EZ	FIRE ALARM SPEAKER, +80" A.F.F.			FS
	FIRE ALARM SPEAKER/STROBE, +80" TO 96" A.F.F.		APPROX. CAMERA VIEW	FSD
OR E	FIRE ALARM STROBE, +80" TO 96" A.F.F.			GND
IM	FIRE ALARM INPUT MODULE	ENTRY	APARTMENT ENTRY SYSTEM	I R
	FIRE ALARM OUTPUT MODULE			JB
FACP	FIRE ALARM CONTROL PANEL			N.I.C.
FARA	FIRE ALARM REMOTE ANNUNCIATOR		PAGING AND	OFCI
S	STAND ALONE - RESIDENTIAL SMOKE DETECTOR 120V W/ BATTERY		INTERCOM SYMBOLS	OFOI
\odot	CARBON MONOXIDE DETECTOR RESIDENTIAL 120V W/ BATTERY	S	CEILING MOUNTED SPEAKER	P.A.
		\$×1	WALL MOUNTED SPEAKER	P.E.T.
		•	INTERCOM CALL SWITCH	SD
			SIGNAL BUZZER	TS
$\langle 1 \rangle$	NOTATIONS	占	SIGNAL HORN	TTB
	DRAWING NOTE	VC	VOLUME CONTROL +48" A.F.F.	TYP.
2		کر ا		U.G.
$\frac{2}{E3}$	DETAIL REFERENCE: TOP=DETAIL NO., BOTTOM=SHEET NO.	Z01.		U.O.N.
EF			HOMERUN TO EQUIPMENT	W.G.
EF 2	MECHANICAL EQUIPMENT MARK NO. (SEE EQUIPMENT SCHEDULE)		ZONE INDICATION	W.P.
AAA		\mathbf{i}		X.P.
	EQUIPMENT NO. (SEE EQUIPMENT SCHEDULE)		-SPEAKER CONNECTION, NOT INDICATING CABLE PATH	

FIRE ALARM GENERAL NOTES:

A. HIGH-RISE BUILDING SHALL BE PROVIDED WITH AN AUTOMATIC SMOKE DETECTION SYSTEM IN ACCORDANCE WITH SECTION 907.2.12.1, A FIRE DEPARTMENT COMMUNICATION SYSTEM IN ACCORDANCE WITH SECTION 907.2.12.2 AND AN EMERGENCY VOICE ALARM COMMUNICATION SYSTEM IN ACCORDANCE WITH SECTION 907.5.2.2.

B. AREA SMOKE DETECTION IN ACCORDANCE WITH 907.2.12.1.1 SHALL BE CONNECTED TO AN AUTOMATIC FIRE ALARM SYSTEM. THE ACTIVATION OF ANY DETECTOR REQUIRED BY THIS SECTION SHALL ACTIVATE THE EMERGENCY VOICE ALARM SYSTEM IN ACCORDANCE WITH SECTION 907.5.2.2. IN ADDITION TO SMOKE DETECTORS REQUIRED BY SECTIONS 907.2.1 THROUGH 907.2.9 SMOKE DETECTORS SHALL ALSO BE LOCATED IN ROOMS HOUSING MECHANICAL EQUIPMENT, ELECTRICAL EQUIPMENT AND/OR TRANSFORMERS, TELEPHONE EQUIPMENT OR SIMILAR ROOM NOT EQUIPPED WITH A SPRINKLER PROTECTION. ALSO, EACH ELEVATOR MACHINE ROOM, MACHINERY SPACE, CONTROL ROOM, AND ELEVATOR LOBBIES.



ABBREVIATIONS

ABOVE FINISHED FLOOR APPROXIMATE CONDUIT CONDUIT ONLY CABLE TELEVISION CLOSED CIRCUIT TELEVISION CEILING MOUNTED EXISTING FIRE ALARM CONTROL PANEL FACEPLATE FLOW SWITCH (SEE FIRE ALARM SYMBOLS) FIRE/SMOKE DAMPER GROUND INFRARED JUNCTION BOX NOT IN CONTRACT OWNER FURNISHED, CONTRACTOR INSTALLED OWNER FURNISHED, OWNER INSTALLED PUBLIC ADDRESS PROTECTIVE ENTRANCE TERMINAL SMOKE DAMPER TAMPER SWITCH (SEE FIRE ALARM SYMBOLS) TELEPHONE TERMINAL BOARD TYPICAL UNDERGROUND UNLESS OTHERWISE NOTED WIRE GUARD WEATHERPROOF

EXPLOSION PROOF

FIRE ALARM AND DETECTION SYSTEM SHOWN ON PLAN(S) ARE FOR DESIGN INTENT ONLY. THIS IS A DEFERRED SUBMITTAL SYSTEM REQUIRING THE CONTRACTOR TO COMPLETE THE PERMIT READY DESIGN AND CALCULATIONS AS REQUIRED PER THE AUTHORITY HAVING JURISDICTION. VERIFY BUILDING OCCUPANCY TYPE AND OCCUPANT

LOAD WITH ARCHITECTURAL PLANS.

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SMART PDX PROPERTIES, LLC

Project Name:

MINNESOTA PLACES


1208 N. JESSUP & 5627 N. MINNESOTA (R226159, R226160)

PERMIT SUBMITTAL

Issued:	
PERMIT SUBMITTAL	8.16.2021

Job #: 2020 ORIGINAL SHEET SIZE: 24" x 36" HALF SIZE: 12" x 18"

TECHNOLOGY SYMBOL LIST

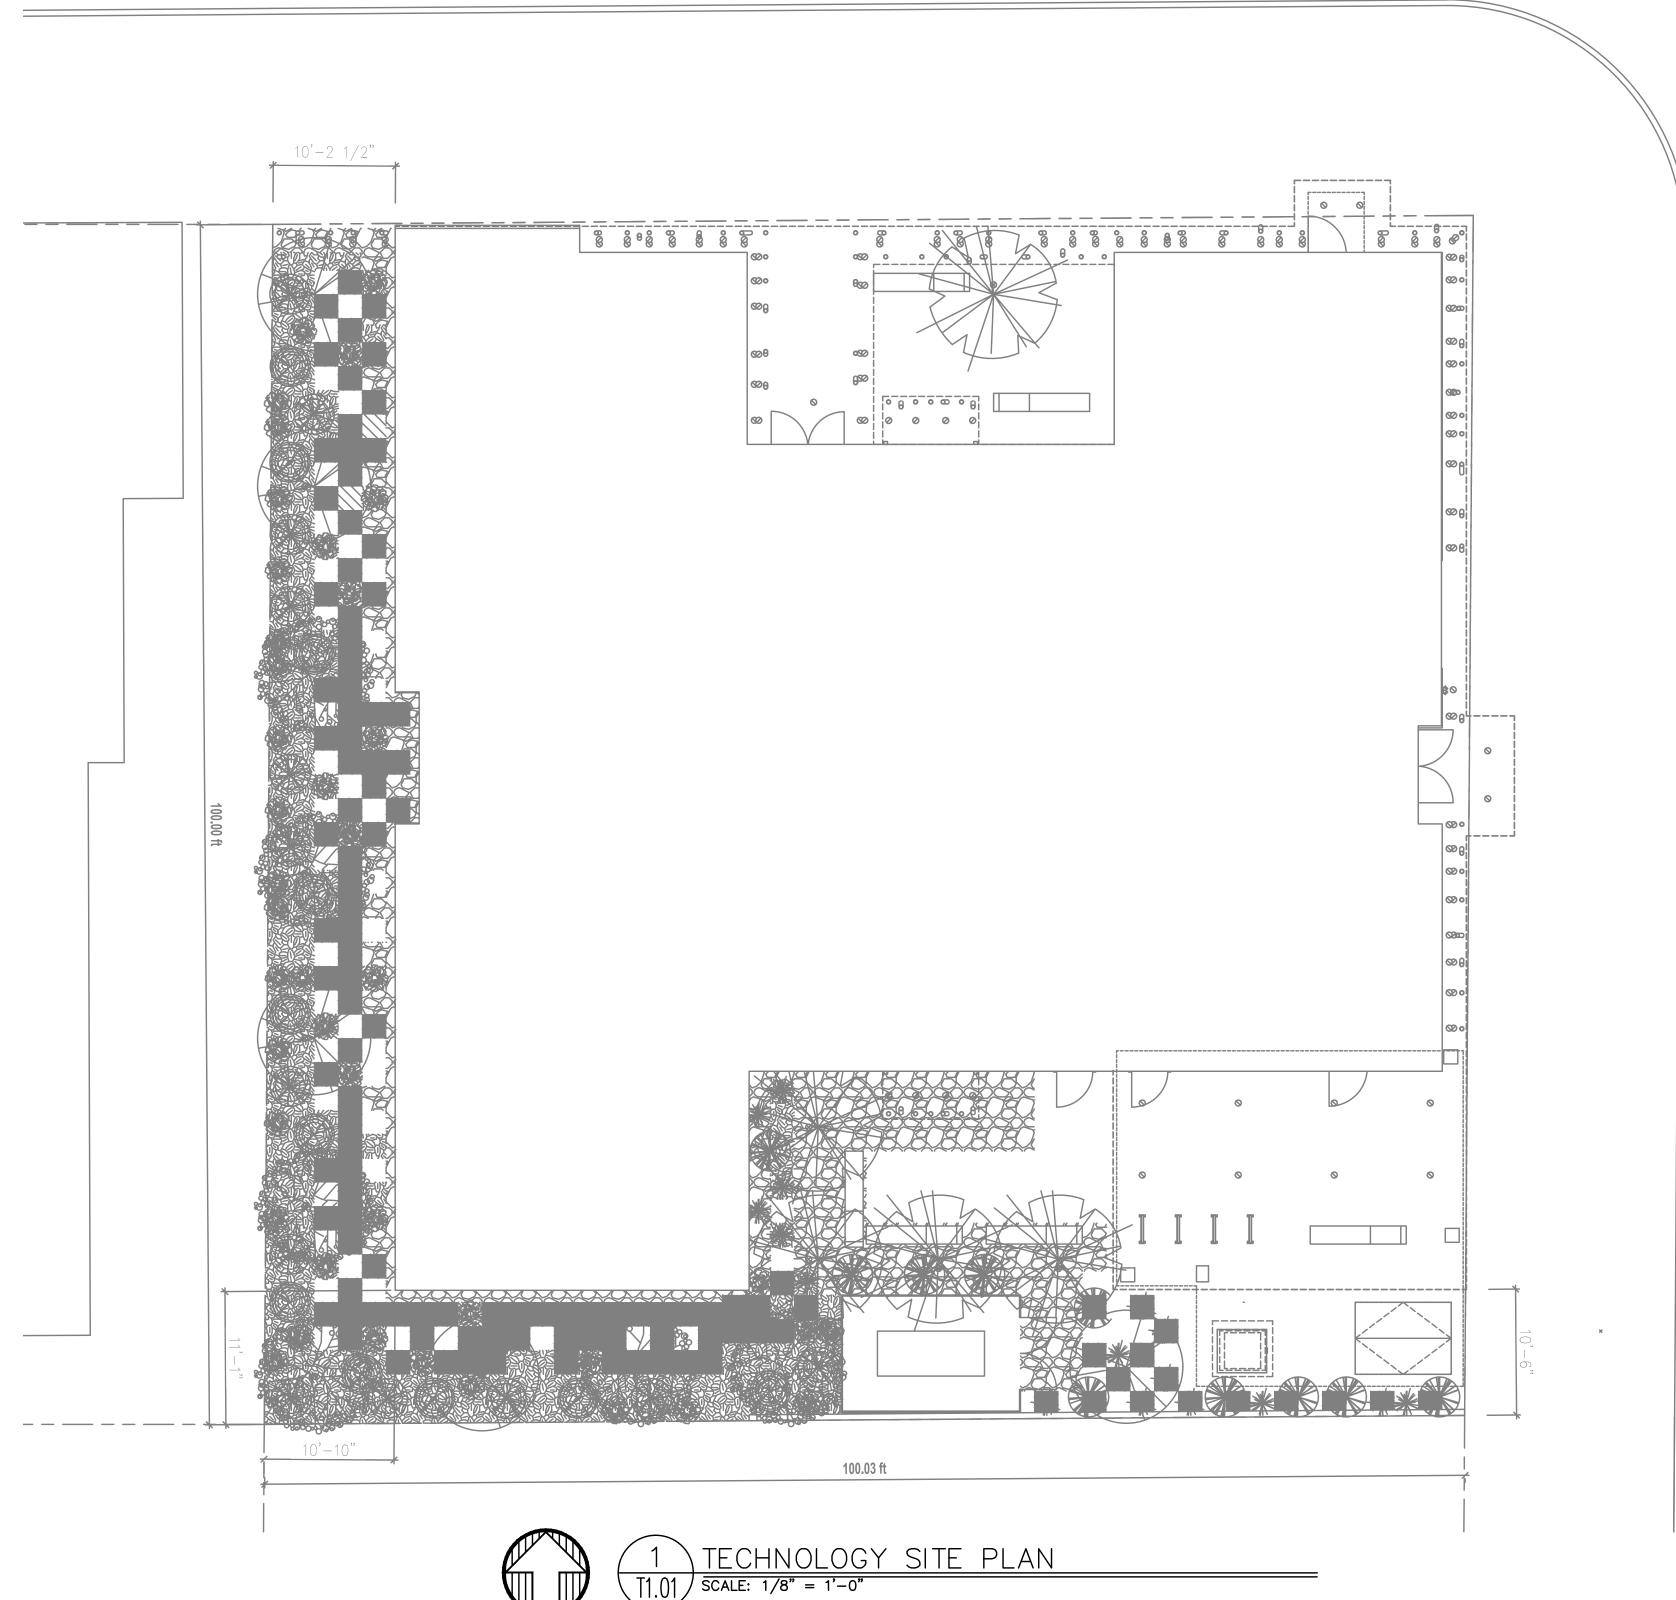

- A. ALL WORK SHALL BE PERFORMED IN ACCORDANCE WITH ALL APPLICABLE LOCAL, STATE AND NATIONAL CODES.
- B. PLANS ARE DIAGRAMMATIC AND MAY OR MAY NOT REFLECT ACTUAL FIELD CONDITIONS.
- C. COORDINATE WITH UTILITY PROVIDER FOR EXACT CONDUIT COUNT AND SIZE REQUIREMENTS.
- D. CONTRACTOR SHALL REVIEW THE UTILITY PROVIDER'S SERVICE REQUIREMENTS PRIOR TO THE START OF ANY WORK.
- E. CONTRACTOR SHALL REVIEW ALL PROJECT DOCUMENTS AND SPECIFICATIONS IN DETAIL AND REFER TO THE DOCUMENTS THROUGHOUT THE CONSTRUCTION.
- F. POWER INFORMATION SHOWN FOR REFERENCE ONLY. REFER TO ELECTRICAL SHEETS FOR MOST ACCURATE INFORMATION.

UTILITY REQUIREMENTS

- 1. CUSTOMER TO PROVIDE ALL TRENCHING AND BACKFILLING. TRENCH TO BE 36 INCHES DEEP AND 30 INCHES WIDE, MEASURED FROM FINAL GRADE.
- 2. ALL UTILITY CONDUCTORS TO BE INSTALLED IN PVC CONDUIT WITH NYLON PULL STRINGS (MIN 500 LBS. TEST). UTILITIES TO DETERMINE THE SIZE AND NUMBER OF CONDUITS REQUIRED. ALL ELBOWS TO BE 36 INCH (MIN) RADIUS. ALL BENDS MAY BE FACTORY MADE.
- 3. CONTRACTOR TO LOCATE ALL UNDERGROUND UTILITIES BEFORE TRENCHING.



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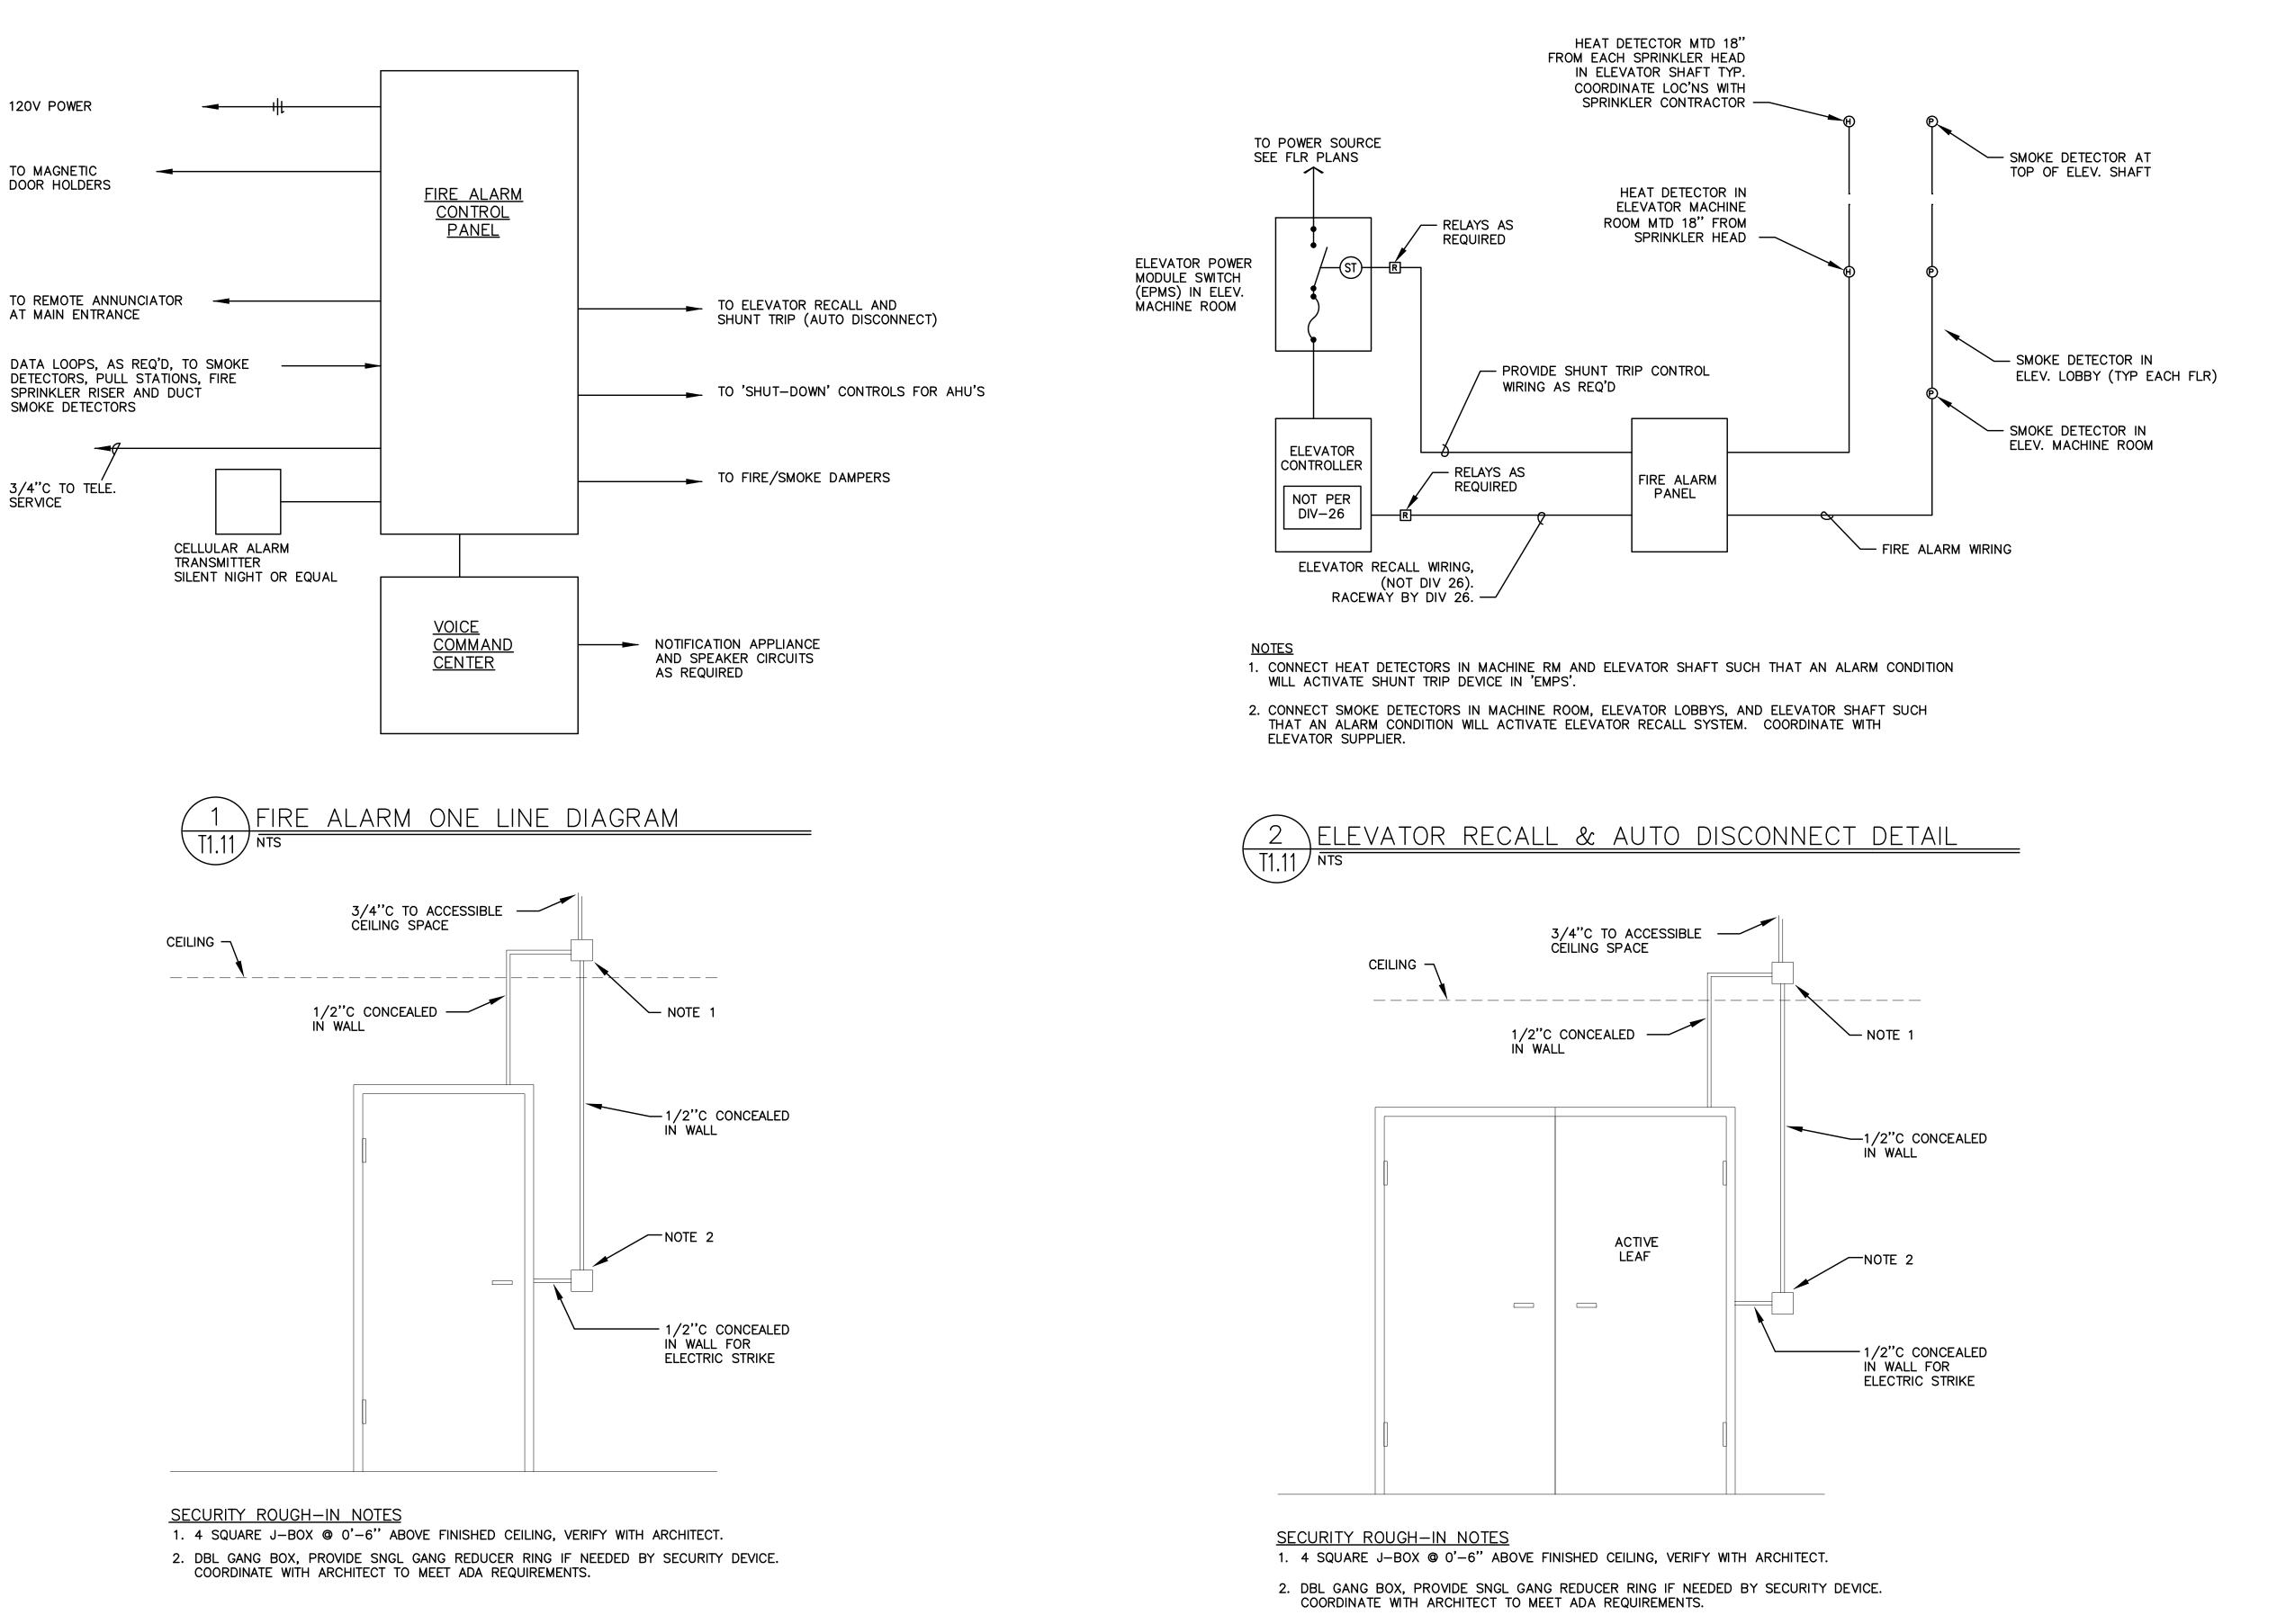
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PERMIT SUBMITTAL	8.16.202
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TECHNOLOGY SITE PLAN

Drawing Number

T1.01





ACCESS CONTROL ROUGH-IN 4 T1.11/ NTS



Project Name: MINNESOTA PLACES

1208 N. JESSUP & 5627 N. MINNESOTA (R226159, R226160)


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TECHNOLOGY ONE-LINE DIAGRAM Drawing Number

T1.11



- Α.
- ALARM SYSTEM.
- ELECTRICAL.
- APARTMENT UNIT TYPES.

_AN NOTES: ΡI

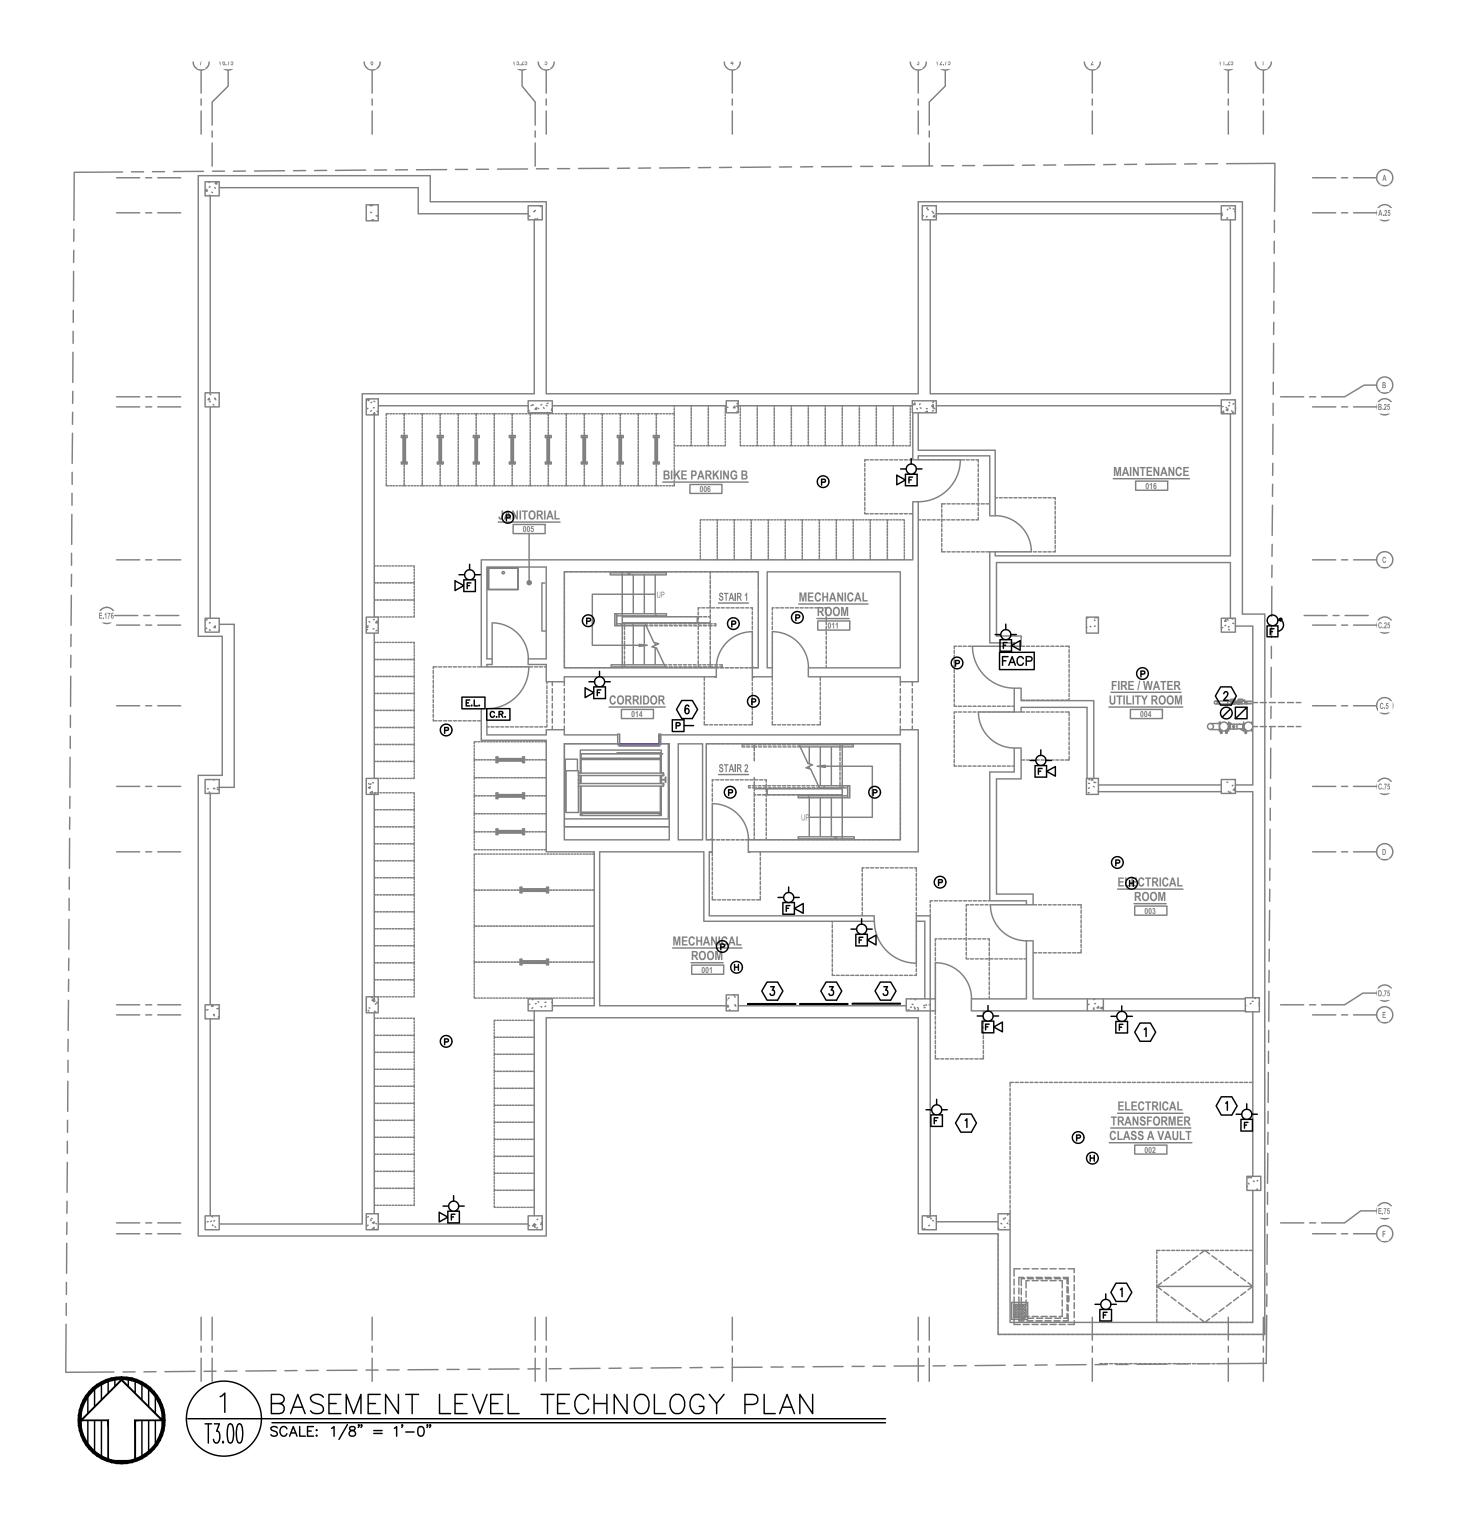- UTILITY REQUEST.
- UTILITY.
- DEMARCATION WITHIN UNIT.
- COMBINED UNIT.

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B. THE TECHNOLOGY CONTRACTOR SHALL REFER TO THE ARCHITECTURAL DRAWINGS FOR ALL MOUNTING HEIGHTS AND FINISHES OF DEVICES AND FIXTURES.

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F. REFER TO ENLARGED TYPICAL UNIT PLANS (IF PROVIDED) FOR TYPICAL LAYOUTS FOR ALL

1. STROBES TO BE PLACED AT 24" AT ELECTRICAL

2. VERY COUNT AND LOCATION FOR FLOW AND TAMPER SWITCHES WITH FIRE SPRINKLER PLANS.

3. 4x8 FIRE RATED BACKBOARDS FOR CATV AND PHONE

4. 42" 'RF' TRANSPARENT SMART PANEL FOR UTILITY

5. SMOKE AND CO DETECTORS CAN BE A SINGLE

6. VERIFY EXACT LOCATION AND COUNT OF DUCT DETECTORS WITH MECHANICAL PLANS.



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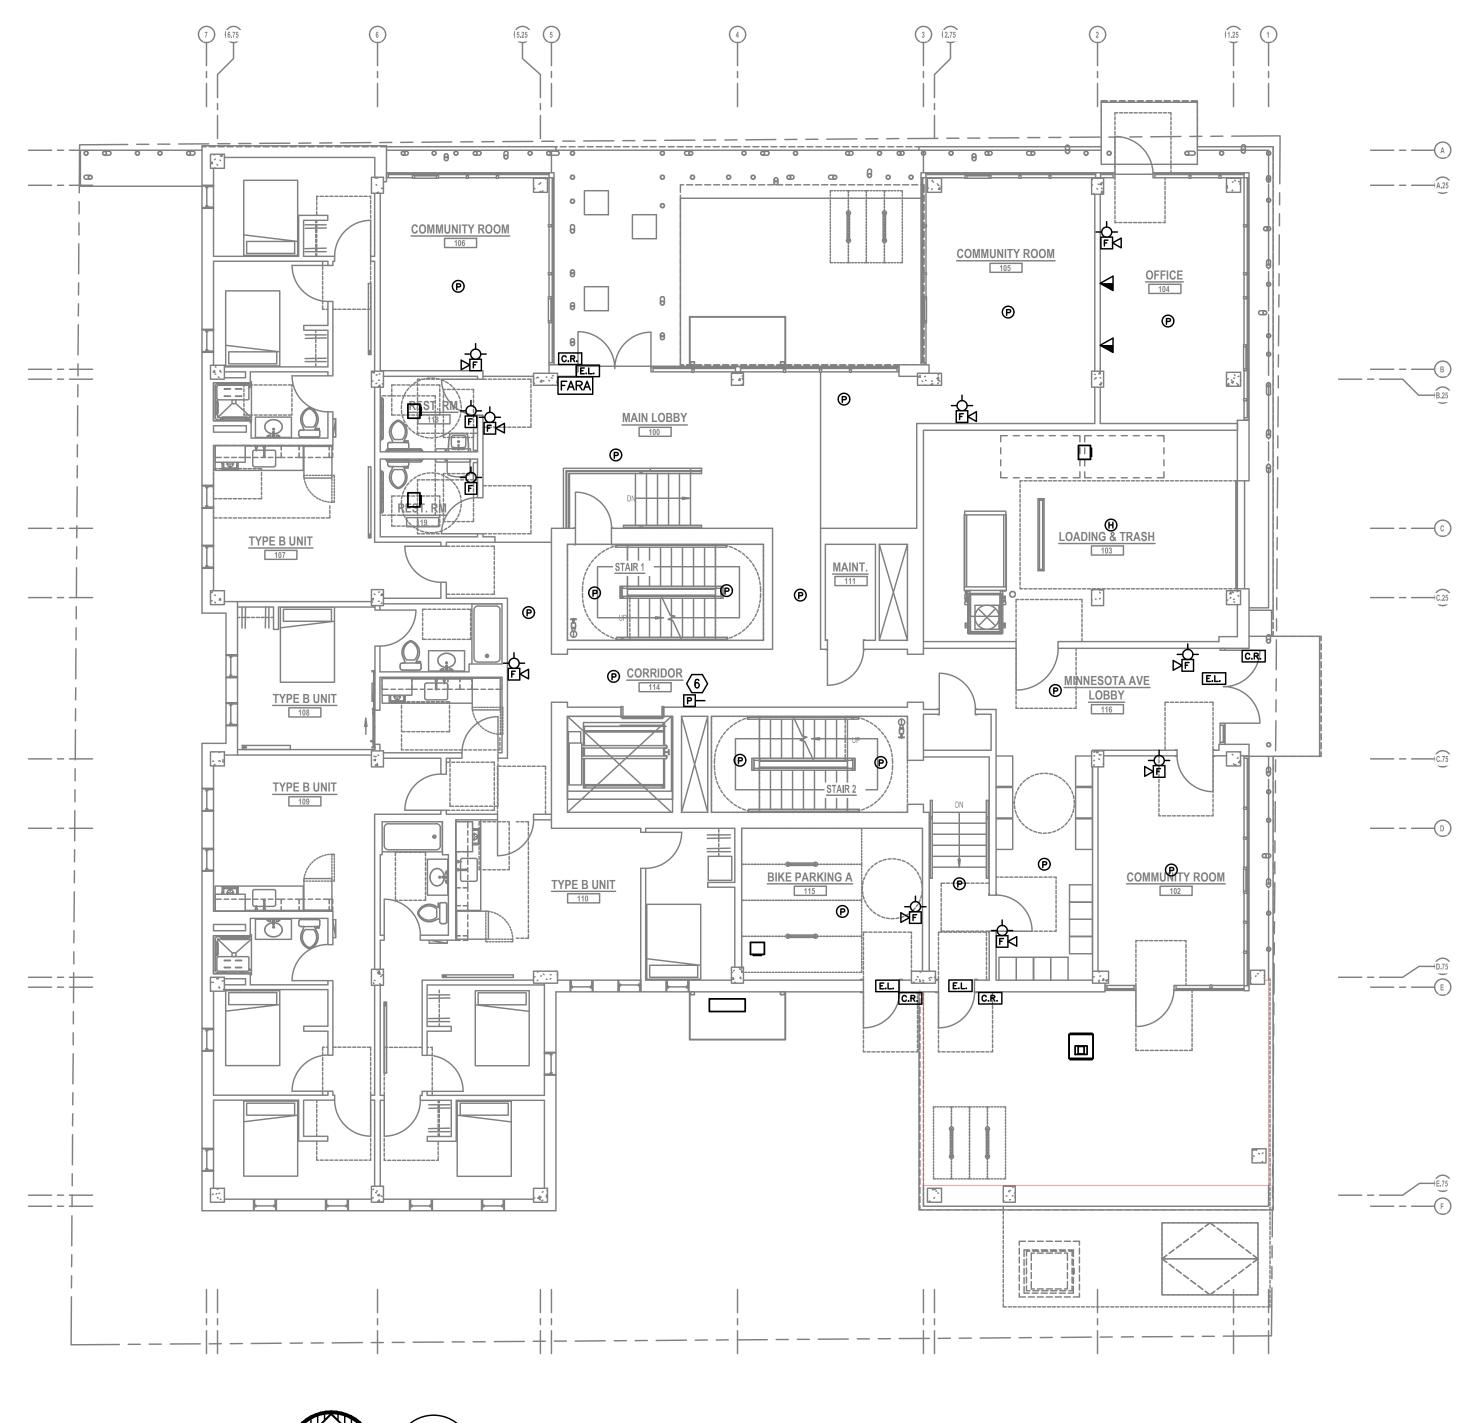
MINNESOTA PLACES

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BASEMEN	Г
LEVEL	
TECHNOL(JGY
PLAN	

Drawing Number



FIRST FLOOR TECHNOLOGY PLAN $\sqrt{\text{SCALE: } 1/8^{"} = 1' - 0"}$

<u>GENERAL</u> NOTES:

- MAY NOT ACCURATELY REFLECT ACTUAL CONTRACTOR SHALL BE RESPONSIBLE FOR COORDINATING THE INSTALLATION OF ALL TO AND DURING CONSTRUCTION.
- C. COORDINATE WITH MECHANICAL PLANS FOR ALARM SYSTEM.
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<u>PLAN NOTES:</u> 1. STROBES TO BE PLACED AT 24" AT ELECTRICAL UTILITY REQUEST.

- SWITCHES WITH FIRE SPRINKLER PLANS.
- UTILITY.
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4. 42" 'RF' TRANSPARENT SMART PANEL FOR UTILITY

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Project Owner: SMART PDX PROPERTIES, LLC

Project Name:

MINNESOTA PLACES

1208 N. JESSUP & 5627 N. MINNESOTA (R226159, R226160)


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PERMIT SUBMITTAL	8.16.202
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ORIGINAL SHEET SIZE: 2	24" x 36"

FIRST FLOOR TECHNOLOGY PLAN

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T3.01



$$\frac{1}{13.02} \frac{1}{\text{SCALE: } 1/8" = 1'-0"}$$

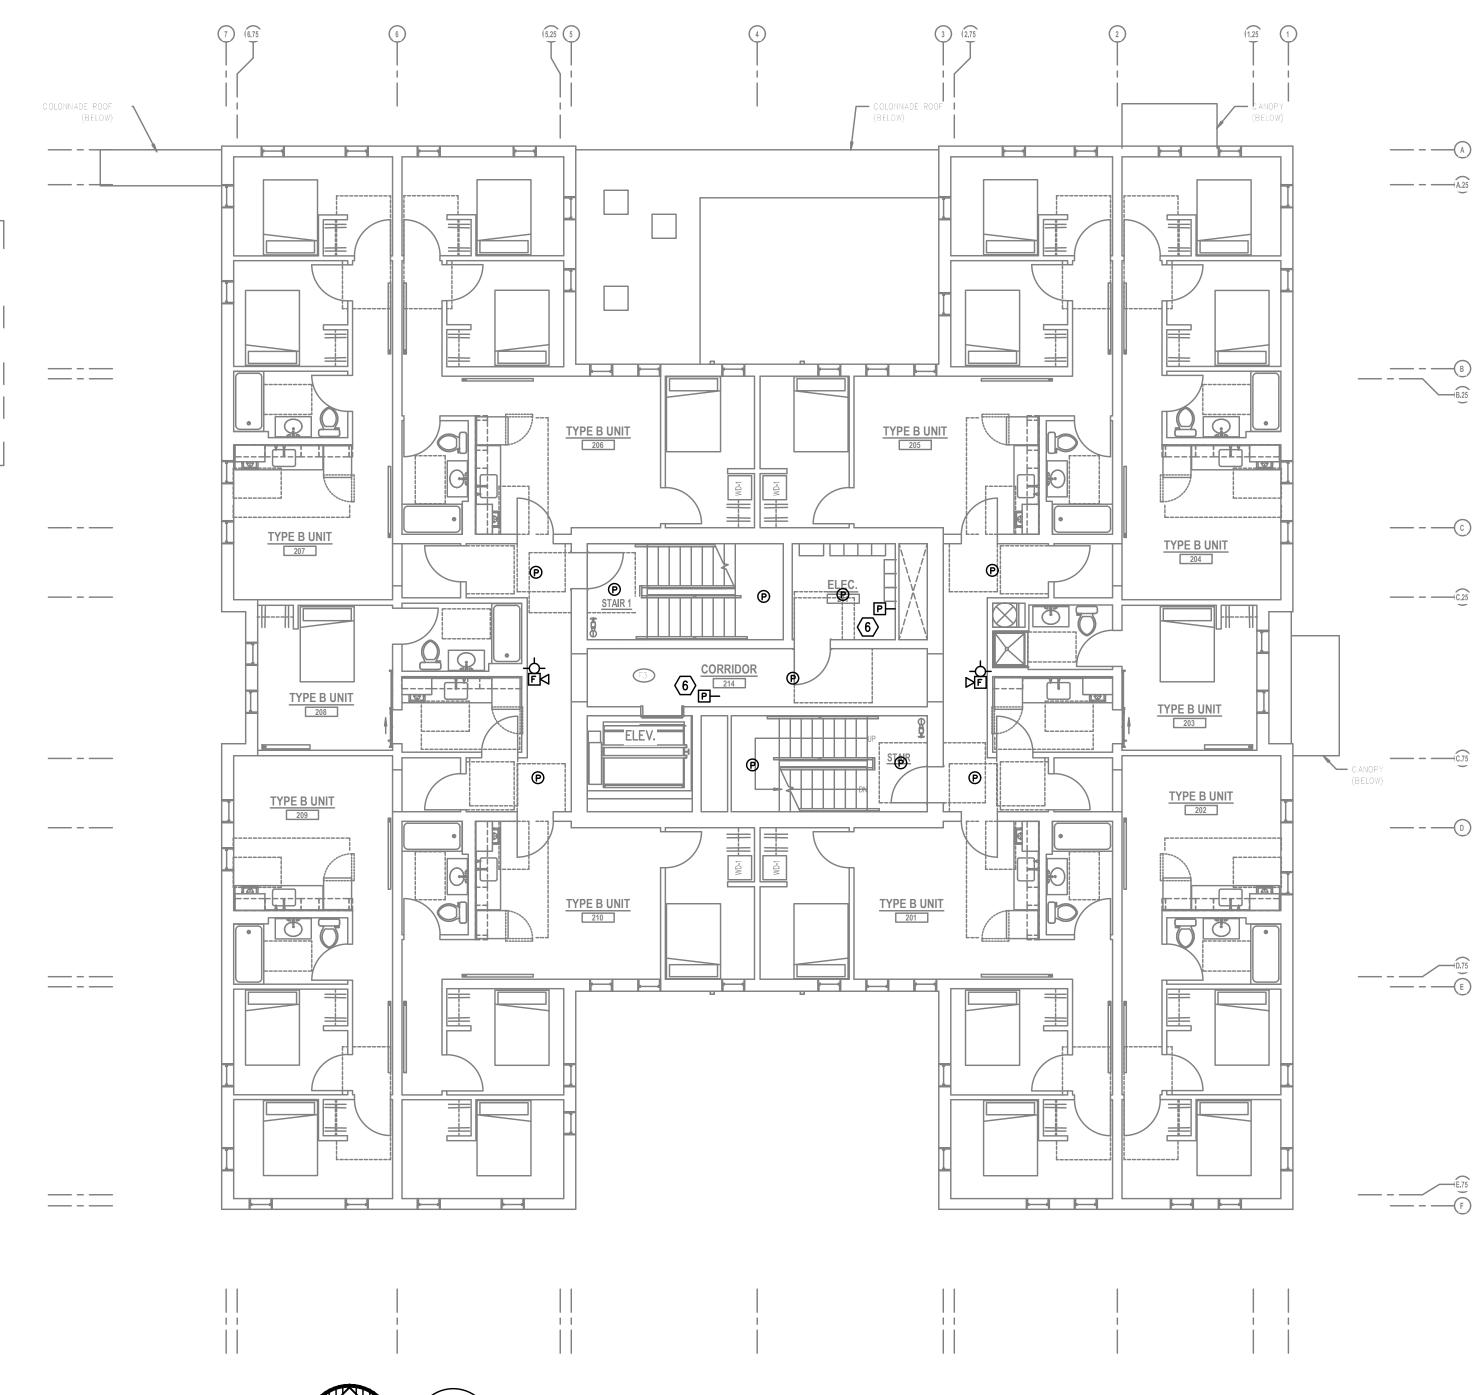- MAY NOT ACCURATELY REFLECT ACTUAL CONTRACTOR SHALL BE RESPONSIBLE FOR COORDINATING THE INSTALLATION OF ALL TO AND DURING CONSTRUCTION.
- C. COORDINATE WITH MECHANICAL PLANS FOR ALARM SYSTEM.
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Ρ	LAN	NC)	ES:
1.	STROBES	S TO	ΒE	PLACE

- UTILITY REQUEST.
- UTILITY.
- DEMARCATION WITHIN UNIT.
- 5. SMOKE AND CO DETECTORS CAN BE A SINGLE COMBINED UNIT.
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Project Owner:

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Project Name:

MINNESOTA PLACES

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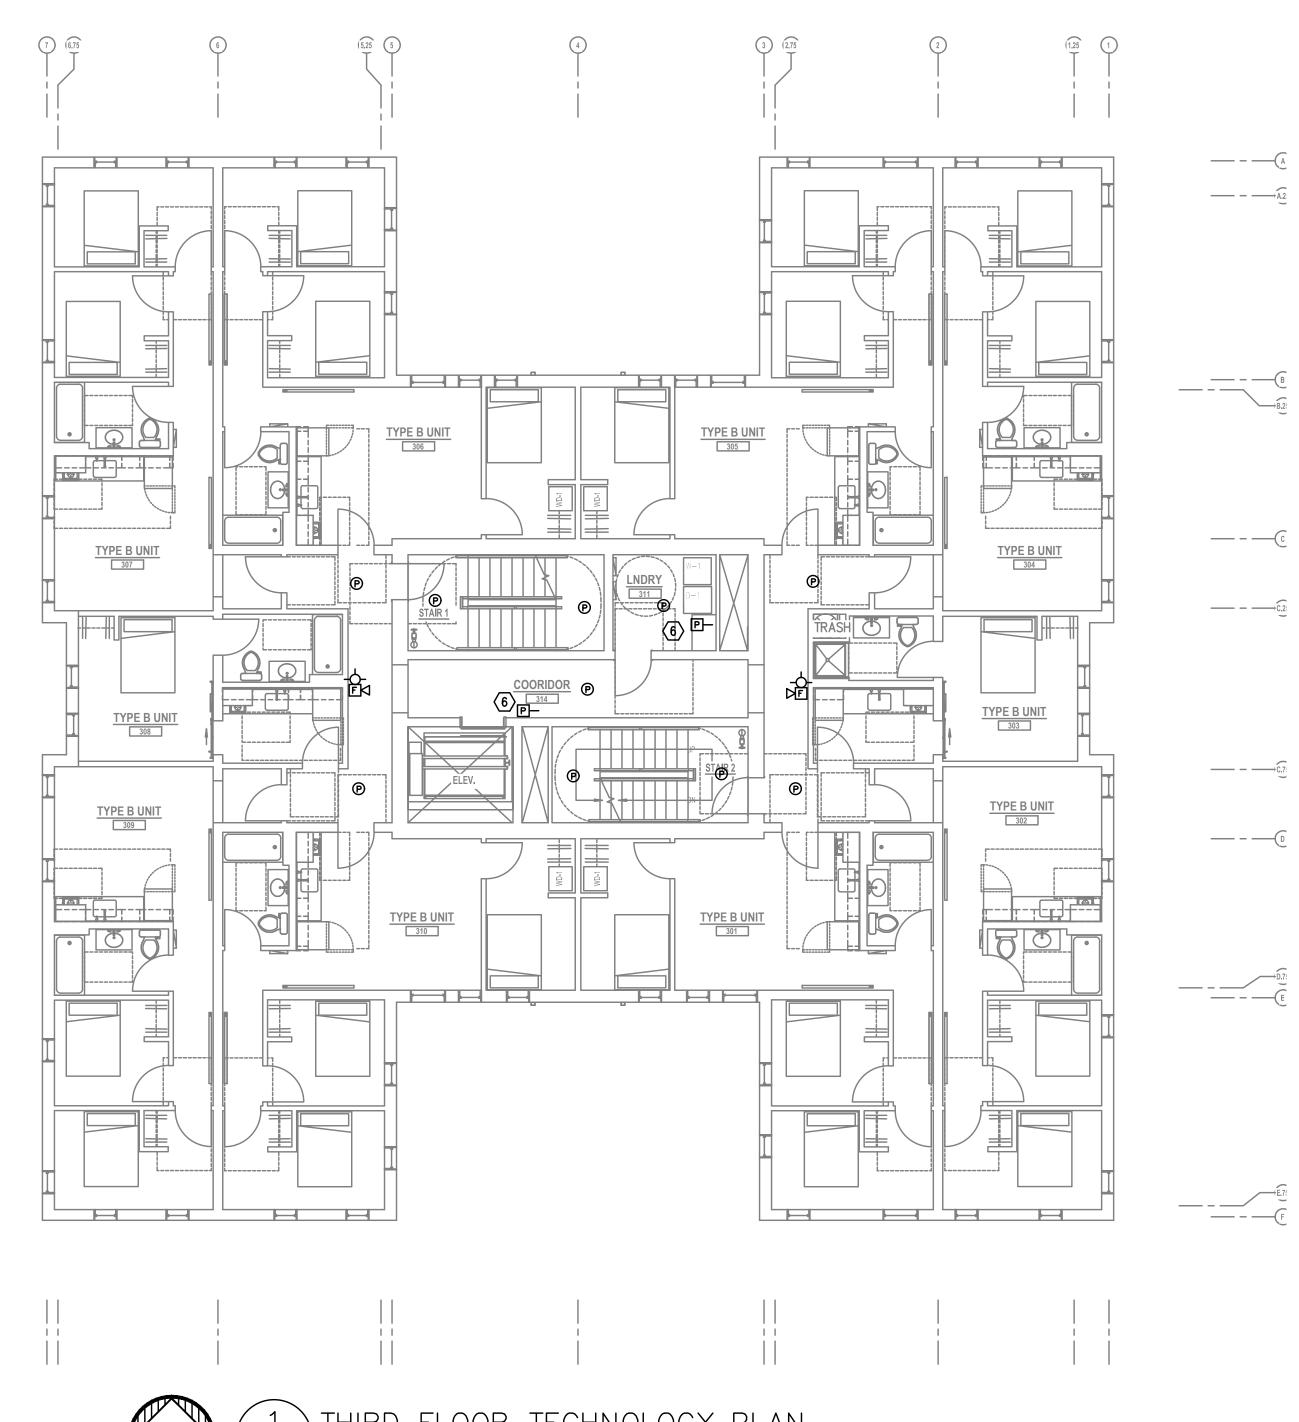
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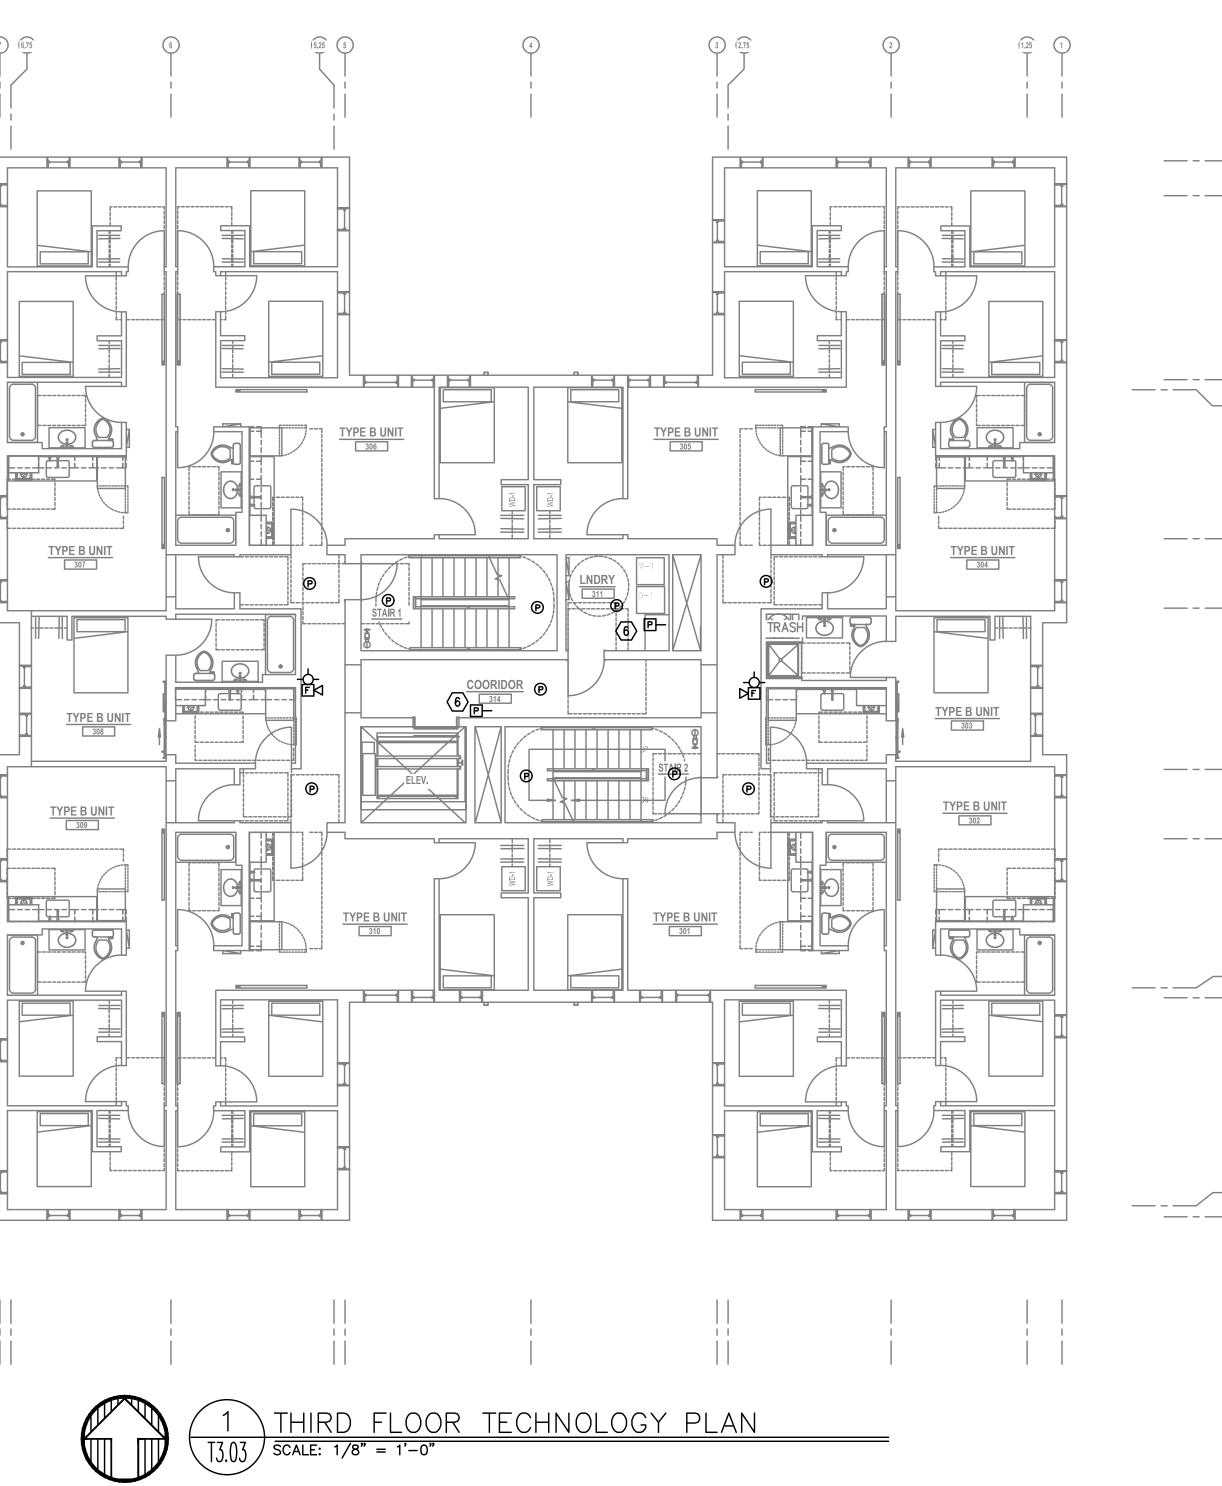
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SECOND FLOOR TECHNOLOGY PLAN

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T3.02





____ ____

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- UTILITY.
- DEMARCATION WITHIN UNIT.
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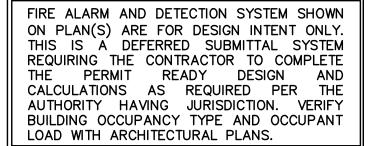
MINNESOTA PLACES

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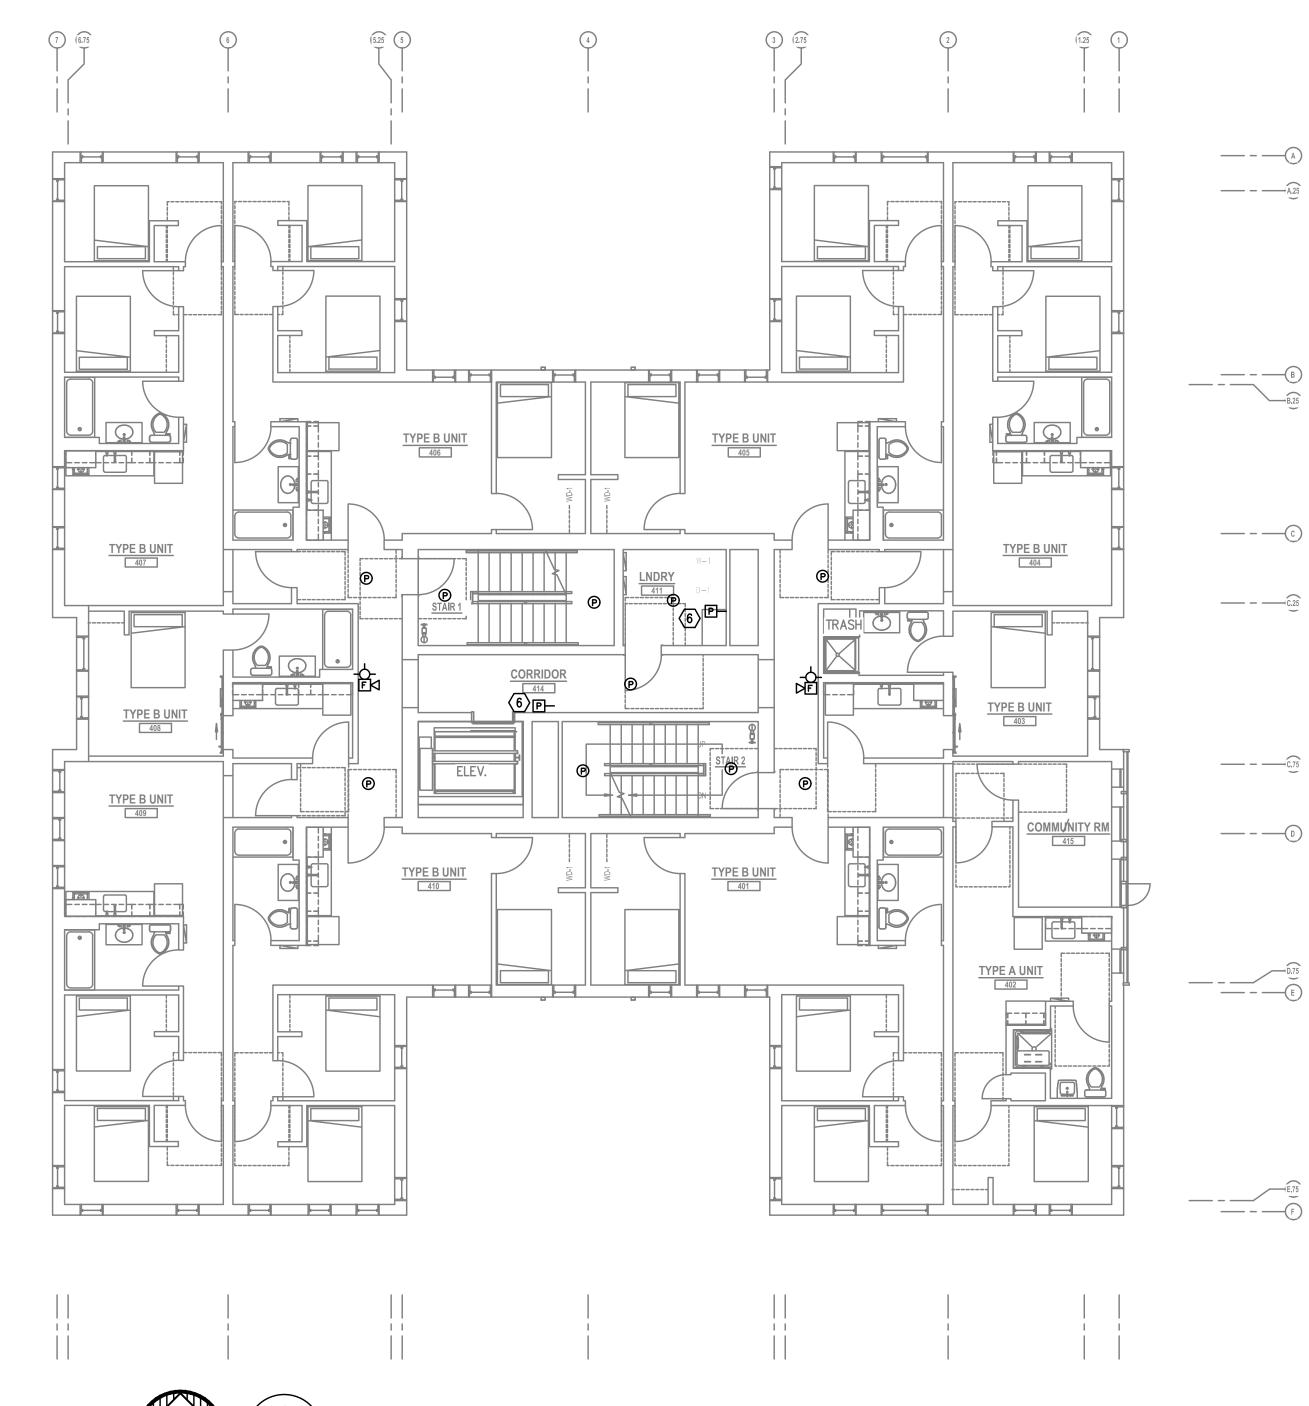
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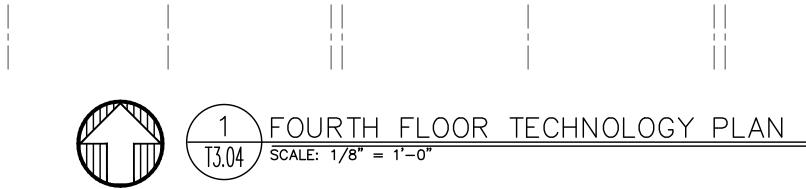
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THIRD FLOOR TECHNOLOGY PLAN



Drawing Number





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PLAN NOTES: 1. STROBES TO BE PLACED AT 24" AT ELECTRICAL UTILITY REQUEST.

- SWITCHES WITH FIRE SPRINKLER PLANS.
- UTILITY.
- DEMARCATION WITHIN UNIT.
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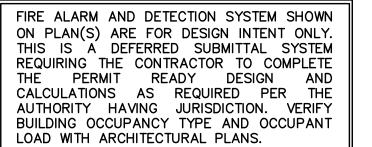
MINNESOTA PLACES

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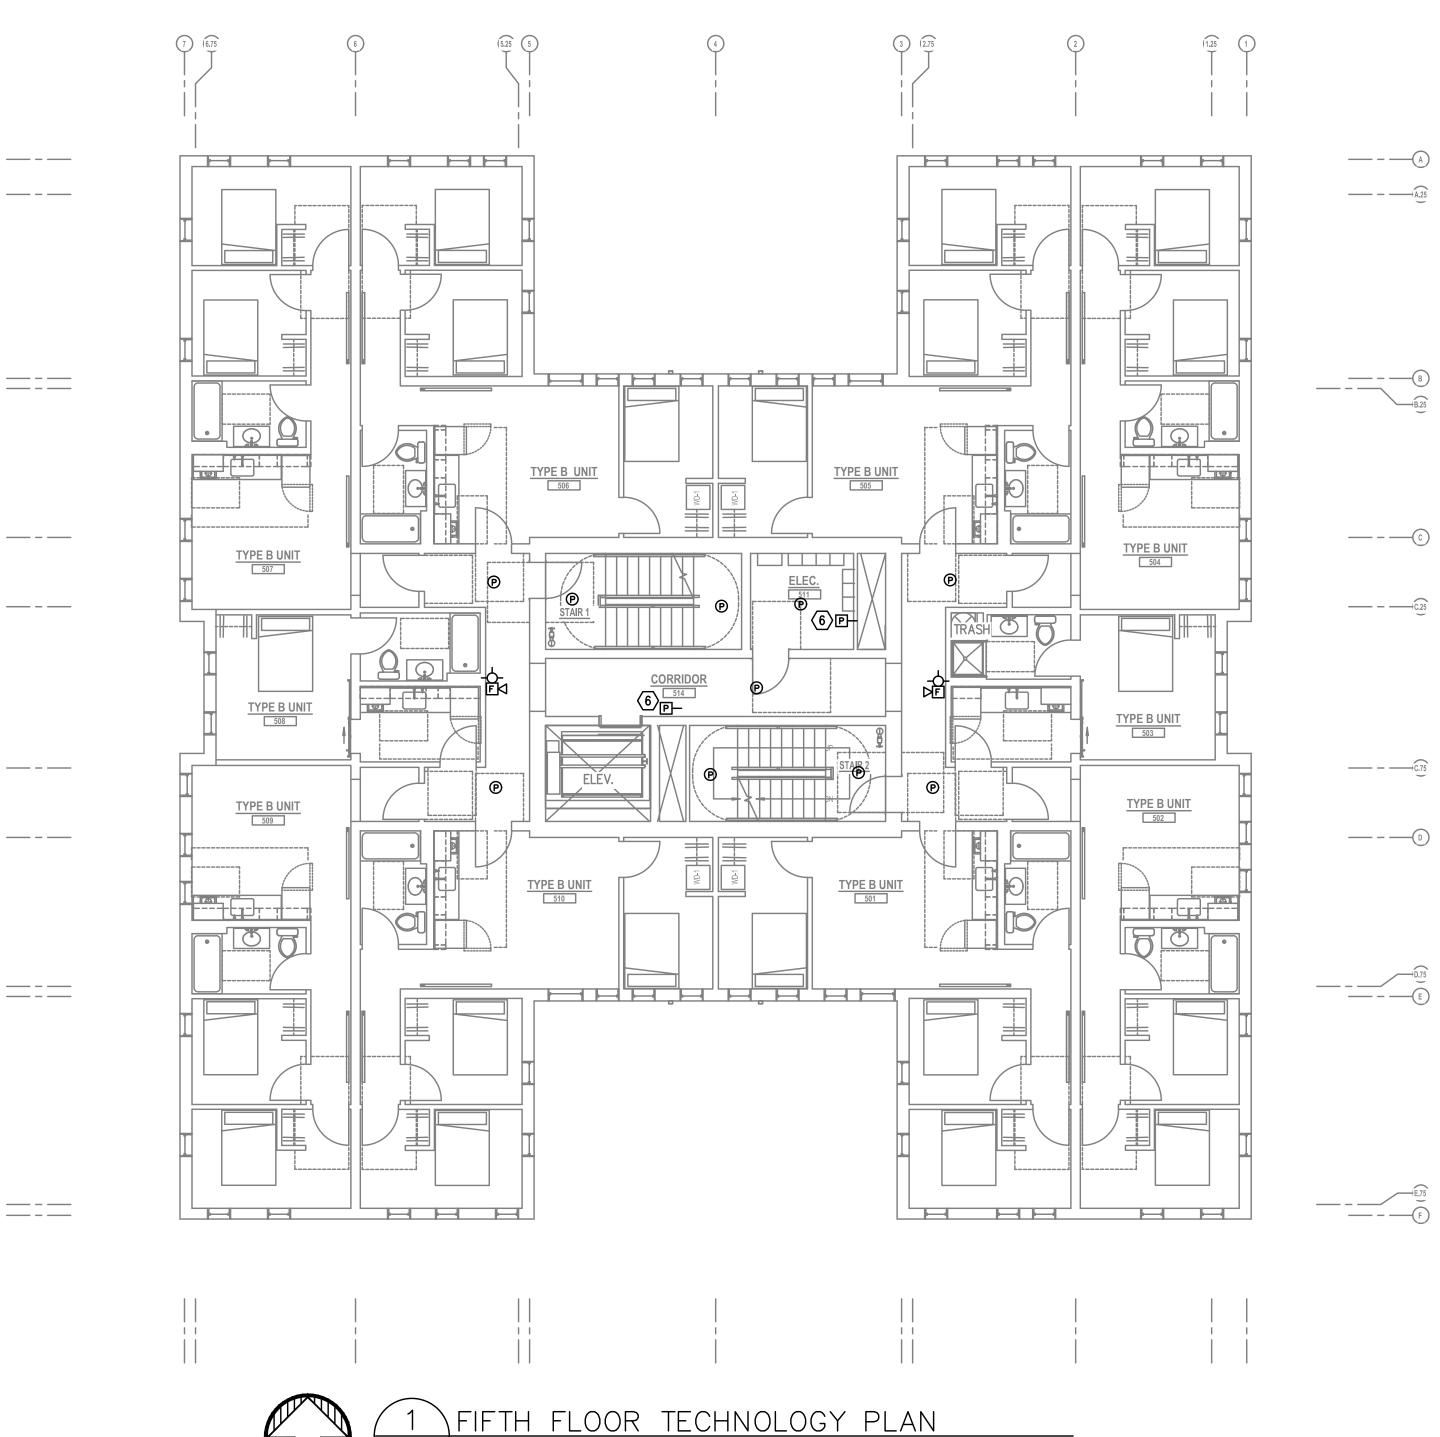
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FOURTH FLOOR TECHNOLOGY PLAN



T3.04



 $\sqrt{\frac{1}{\text{SCALE: 1/8"} = 1'-0"}}$

T3.05

- ____
- ____
- ____
- ____
- ____ ____

<u>GENERAL</u> NOTES:

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- F. REFER TO ENLARGED TYPICAL UNIT PLANS (IF PROVIDED) FOR TYPICAL LAYOUTS FOR ALL APARTMENT UNIT TYPES.

PLAN NOTES: 1. STROBES TO BE PLACED AT 24" AT ELECTRICAL UTILITY REQUEST.

- SWITCHES WITH FIRE SPRINKLER PLANS.
- UTILITY.
- DEMARCATION WITHIN UNIT.
- 5. SMOKE AND CO DETECTORS CAN BE A SINGLE COMBINED UNIT.
- 6. VERIFY EXACT LOCATION AND COUNT OF DUCT DETECTORS WITH MECHANICAL PLANS.

A. TECHNOLOGY DRAWINGS ARE DIAGRAMMATICAL AND CONSTRUCTION CONDITIONS. THE TECHNOLOGY TECHNOLOGY EQUIPMENT, WITH ALL TRADES PRIOR

B. THE TECHNOLOGY CONTRACTOR SHALL REFER TO THE ARCHITECTURAL DRAWINGS FOR ALL MOUNTING HEIGHTS AND FINISHES OF DEVICES AND FIXTURES.

LOCATIONS OF SMOKE, FIRE/SMOKE DAMPERS, AND ROOF TOP UNITS REQUIRING CONNECTION TO FIRE

D. FOR VOICE/DATA OUTLETS PROVIDE A SINGLE GANG MUD-RING WITH A 1" CONDUIT FROM THE TOP OF THE MUD-RING TO ACCESSIBLE CEILING SPACE. TERMINATE CONDUIT WITH END CONNECTORS AND PROTECTION. OUTLET SHALL BE AT THE SAME HEIGHT AS ADJACENT POWER OUTLET AND LESS

COORDINATE ALL DEVICE LOCATIONS WITH LATEST ARCHITECTURAL INTERIOR ELEVATIONS TO VERIFY

2. VERY COUNT AND LOCATION FOR FLOW AND TAMPER

3. 4x8 FIRE RATED BACKBOARDS FOR CATV AND PHONE

4. 42" 'RF' TRANSPARENT SMART PANEL FOR UTILITY

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Project Owner: SMART PDX PROPERTIES, LLC

Project Name:


MINNESOTA PLACES

1208 N. JESSUP & 5627 N. MINNESOTA (R226159, R226160)


PERMIT SUBMITTAL

Issued:	
PERMIT SUBMITTAL	8.16.202
Job #:	2020
ORIGINAL SHEET SIZE: 24 HALF SIZE: 12" x 18"	l" x 36"

FIFTH FLOOR TECHNOLOGY PLAN

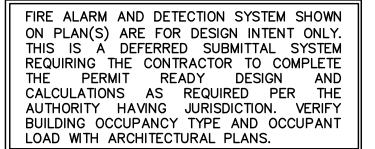



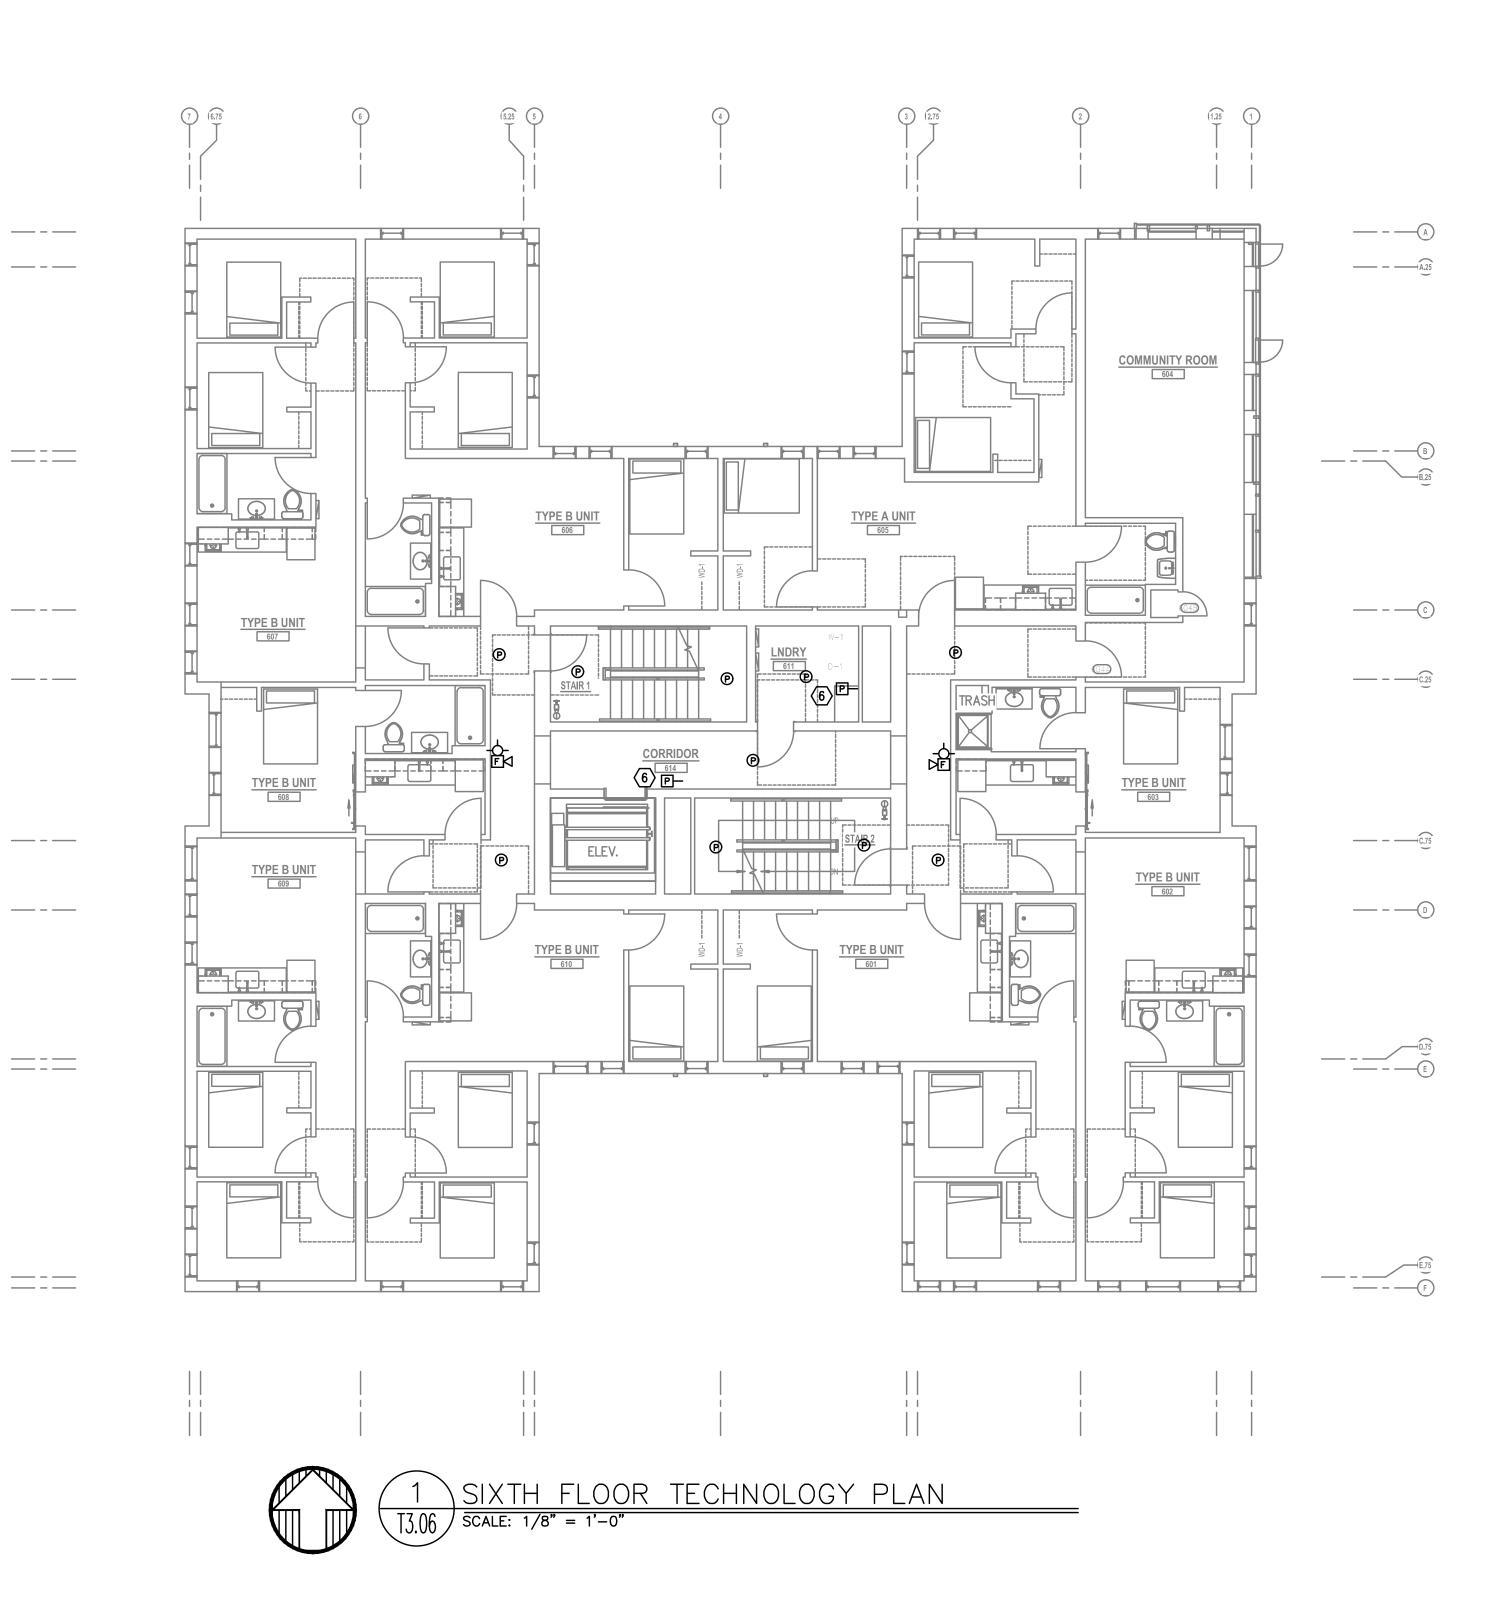

- MAY NOT ACCURATELY REFLECT ACTUAL CONTRACTOR SHALL BE RESPONSIBLE FOR COORDINATING THE INSTALLATION OF ALL TO AND DURING CONSTRUCTION.
- C. COORDINATE WITH MECHANICAL PLANS FOR ALARM SYSTEM.
- THREAD ON PLASTIC BUSHING FOR CABLE THAN 18" SEPARATION. COORDINATE WITH ELECTRICAL.
- Ε. DEVICES WILL NOT BE OBSTRUCTED.
- F. REFER TO ENLARGED TYPICAL UNIT PLANS (IF PROVIDED) FOR TYPICAL LAYOUTS FOR ALL APARTMENT UNIT TYPES.

PLAN NOTES: 1. STROBES TO BE PLACED AT 24" AT ELECTRICAL UTILITY REQUEST.

- SWITCHES WITH FIRE SPRINKLER PLANS.
- UTILITY.
- DEMARCATION WITHIN UNIT.
- 5. SMOKE AND CO DETECTORS CAN BE A SINGLE COMBINED UNIT.
- 6. VERIFY EXACT LOCATION AND COUNT OF DUCT DETECTORS WITH MECHANICAL PLANS.

A. TECHNOLOGY DRAWINGS ARE DIAGRAMMATICAL AND CONSTRUCTION CONDITIONS. THE TECHNOLOGY TECHNOLOGY EQUIPMENT, WITH ALL TRADES PRIOR

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LOCATIONS OF SMOKE, FIRE/SMOKE DAMPERS, AND ROOF TOP UNITS REQUIRING CONNECTION TO FIRE

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COORDINATE ALL DEVICE LOCATIONS WITH LATEST ARCHITECTURAL INTERIOR ELEVATIONS TO VERIFY

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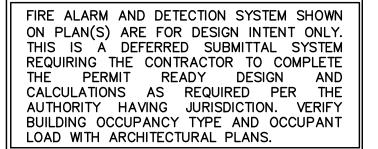
MINNESOTA PLACES

1208 N. JESSUP & 5627 N. MINNESOTA (R226159, R226160)


PERMIT SUBMITTAL

PERMIT SUBMITTAL	8.16.202
Job #:	2020
ORIGINAL SHEET SIZE: 24"	 ' x 36"

SIXTH FLOOR TECHNOLOGY PLAN



Drawing Number

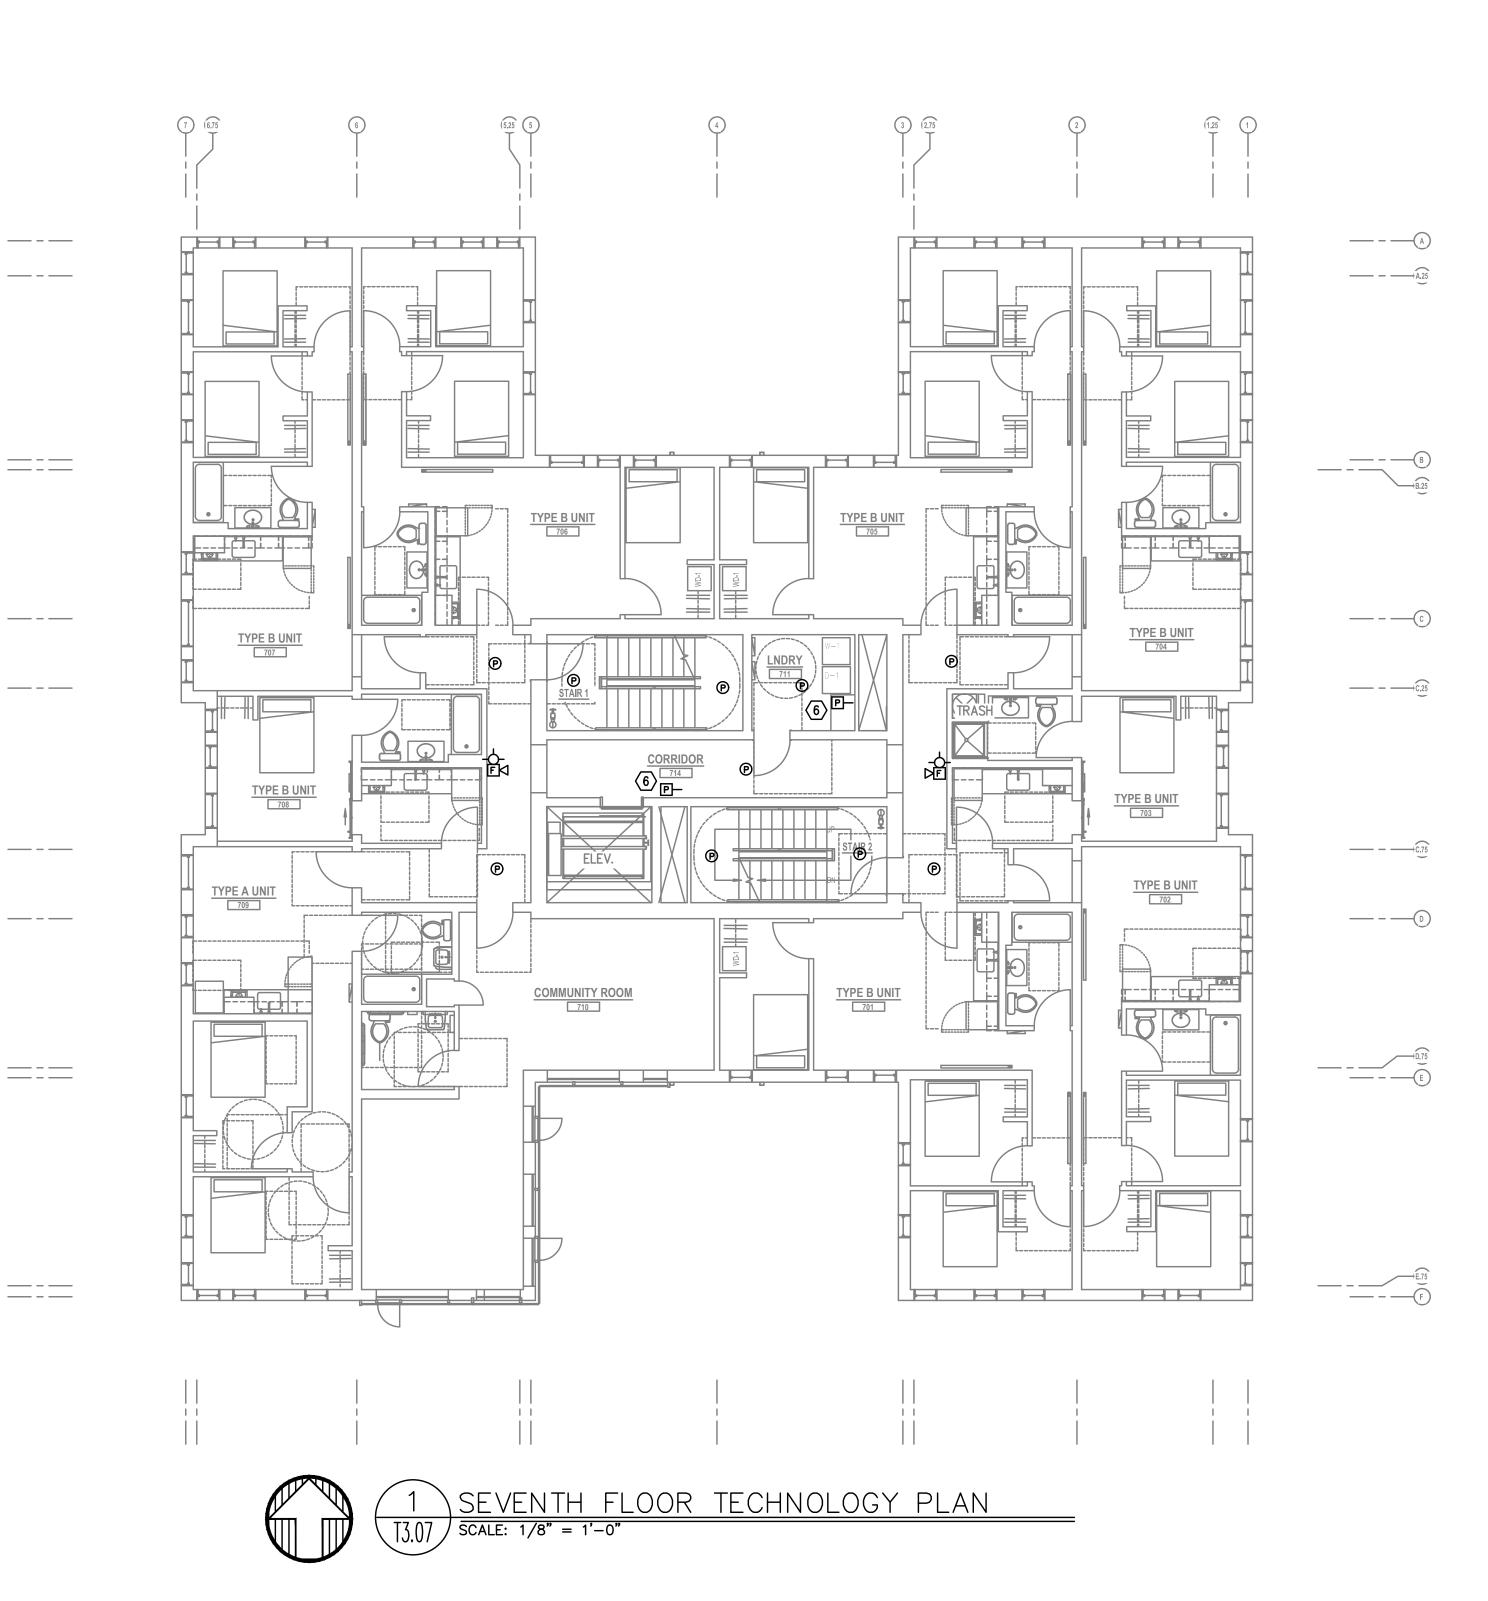

<u>GENERAL</u> NOTES:

- MAY NOT ACCURATELY REFLECT ACTUAL CONTRACTOR SHALL BE RESPONSIBLE FOR COORDINATING THE INSTALLATION OF ALL TO AND DURING CONSTRUCTION.
- C. COORDINATE WITH MECHANICAL PLANS FOR ALARM SYSTEM.
- THREAD ON PLASTIC BUSHING FOR CABLE THAN 18" SEPARATION. COORDINATE WITH ELECTRICAL.
- Ε. DEVICES WILL NOT BE OBSTRUCTED.
- F. REFER TO ENLARGED TYPICAL UNIT PLANS (IF PROVIDED) FOR TYPICAL LAYOUTS FOR ALL APARTMENT UNIT TYPES.

PLAN NOTES: 1. STROBES TO BE PLACED AT 24" AT ELECTRICAL UTILITY REQUEST.

- SWITCHES WITH FIRE SPRINKLER PLANS.
- UTILITY.
- DEMARCATION WITHIN UNIT.
- 5. SMOKE AND CO DETECTORS CAN BE A SINGLE COMBINED UNIT.
- 6. VERIFY EXACT LOCATION AND COUNT OF DUCT DETECTORS WITH MECHANICAL PLANS.

A. TECHNOLOGY DRAWINGS ARE DIAGRAMMATICAL AND CONSTRUCTION CONDITIONS. THE TECHNOLOGY TECHNOLOGY EQUIPMENT, WITH ALL TRADES PRIOR

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LOCATIONS OF SMOKE, FIRE/SMOKE DAMPERS, AND ROOF TOP UNITS REQUIRING CONNECTION TO FIRE

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COORDINATE ALL DEVICE LOCATIONS WITH LATEST ARCHITECTURAL INTERIOR ELEVATIONS TO VERIFY

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wright www.wright-architecture.com

2222 NE Oregon Street, Suite 213 Portland, Oregon 97232 john@wright-architecture.com



Project Owner: SMART PDX PROPERTIES, LLC

Project Name:


MINNESOTA PLACES

1208 N. JESSUP & 5627 N. MINNESOTA (R226159, R226160)


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Issued:	
PERMIT SUBMITTAL	8.16.2021
Job #:	2020
ORIGINAL SHEET SIZE: 24" HALF SIZE: 12" x 18"	_ x 36"

SEVENTH FLOOR TECHNOLOGY PLAN

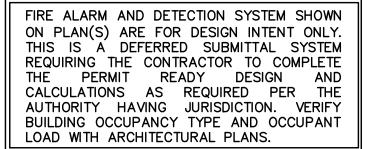

Drawing Number

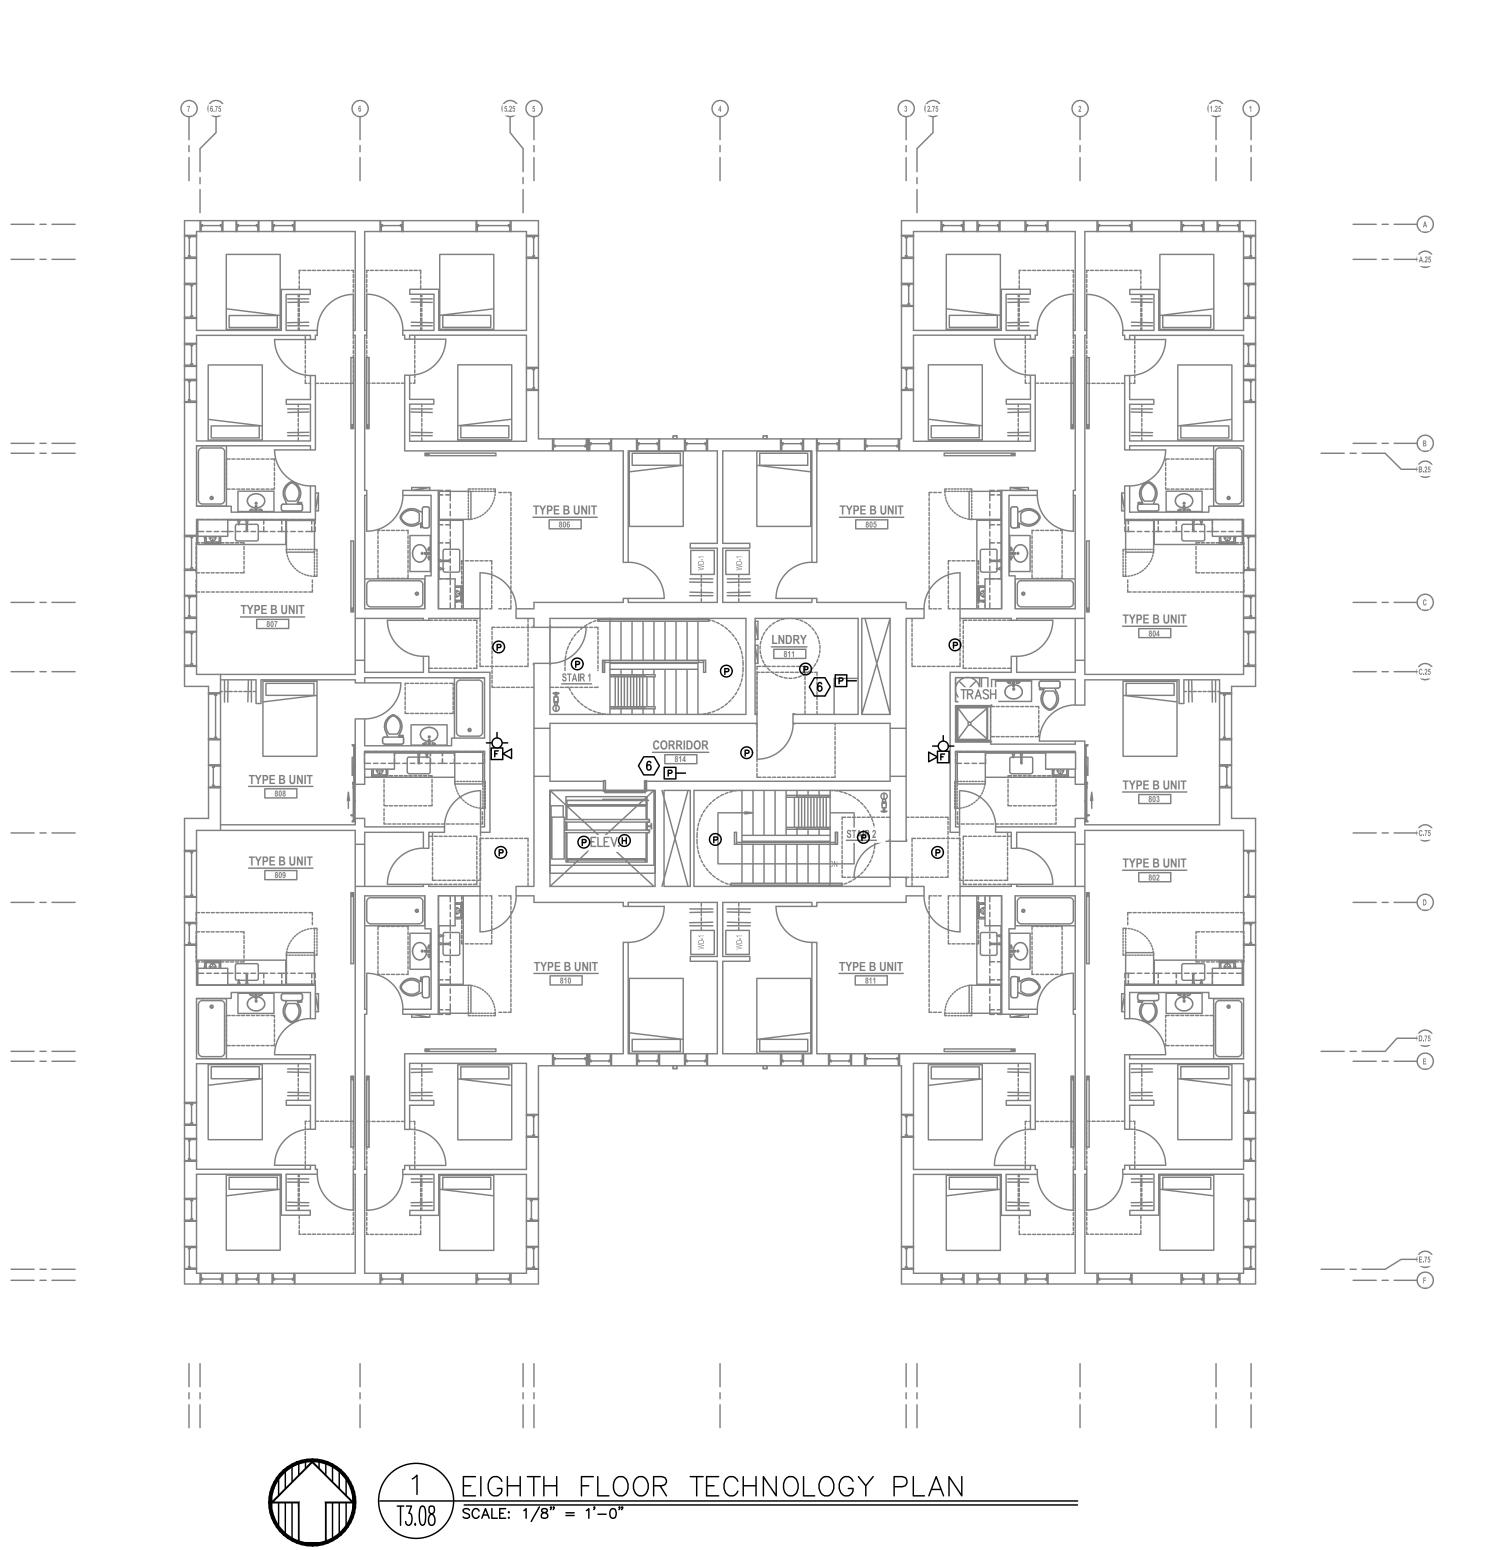

<u>GENERAL NOTES:</u>

- MAY NOT ACCURATELY REFLECT ACTUAL CONTRACTOR SHALL BE RESPONSIBLE FOR COORDINATING THE INSTALLATION OF ALL TO AND DURING CONSTRUCTION.
- C. COORDINATE WITH MECHANICAL PLANS FOR ALARM SYSTEM.
- THREAD ON PLASTIC BUSHING FOR CABLE THAN 18" SEPARATION. COORDINATE WITH ELECTRICAL.
- Ε. DEVICES WILL NOT BE OBSTRUCTED.
- F. REFER TO ENLARGED TYPICAL UNIT PLANS (IF PROVIDED) FOR TYPICAL LAYOUTS FOR ALL APARTMENT UNIT TYPES.

PLAN NOTES: 1. STROBES TO BE PLACED AT 24" AT ELECTRICAL UTILITY REQUEST.

- SWITCHES WITH FIRE SPRINKLER PLANS.
- UTILITY.
- DEMARCATION WITHIN UNIT.
- 5. SMOKE AND CO DETECTORS CAN BE A SINGLE COMBINED UNIT.
- 6. VERIFY EXACT LOCATION AND COUNT OF DUCT DETECTORS WITH MECHANICAL PLANS.

A. TECHNOLOGY DRAWINGS ARE DIAGRAMMATICAL AND CONSTRUCTION CONDITIONS. THE TECHNOLOGY TECHNOLOGY EQUIPMENT, WITH ALL TRADES PRIOR

B. THE TECHNOLOGY CONTRACTOR SHALL REFER TO THE ARCHITECTURAL DRAWINGS FOR ALL MOUNTING HEIGHTS AND FINISHES OF DEVICES AND FIXTURES.

LOCATIONS OF SMOKE, FIRE/SMOKE DAMPERS, AND ROOF TOP UNITS REQUIRING CONNECTION TO FIRE

D. FOR VOICE/DATA OUTLETS PROVIDE A SINGLE GANG MUD-RING WITH A 1" CONDUIT FROM THE TOP OF THE MUD-RING TO ACCESSIBLE CEILING SPACE. TERMINATE CONDUIT WITH END CONNECTORS AND PROTECTION. OUTLET SHALL BE AT THE SAME HEIGHT AS ADJACENT POWER OUTLET AND LESS

COORDINATE ALL DEVICE LOCATIONS WITH LATEST ARCHITECTURAL INTERIOR ELEVATIONS TO VERIFY

2. VERY COUNT AND LOCATION FOR FLOW AND TAMPER

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Project Owner: SMART PDX PROPERTIES, LLC

Project Name:


MINNESOTA PLACES


1208 N. JESSUP & 5627 N. MINNESOTA (R226159, R226160)

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Issued:	
PERMIT SUBMITTAL	8.16.2021
Job #:	2020
ORIGINAL SHEET SIZE: 24" > HALF SIZE: 12" x 18"	- < 36"

EIGHTH FLOOR TECHNOLOGY PLAN Drawing Number



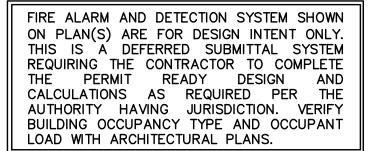

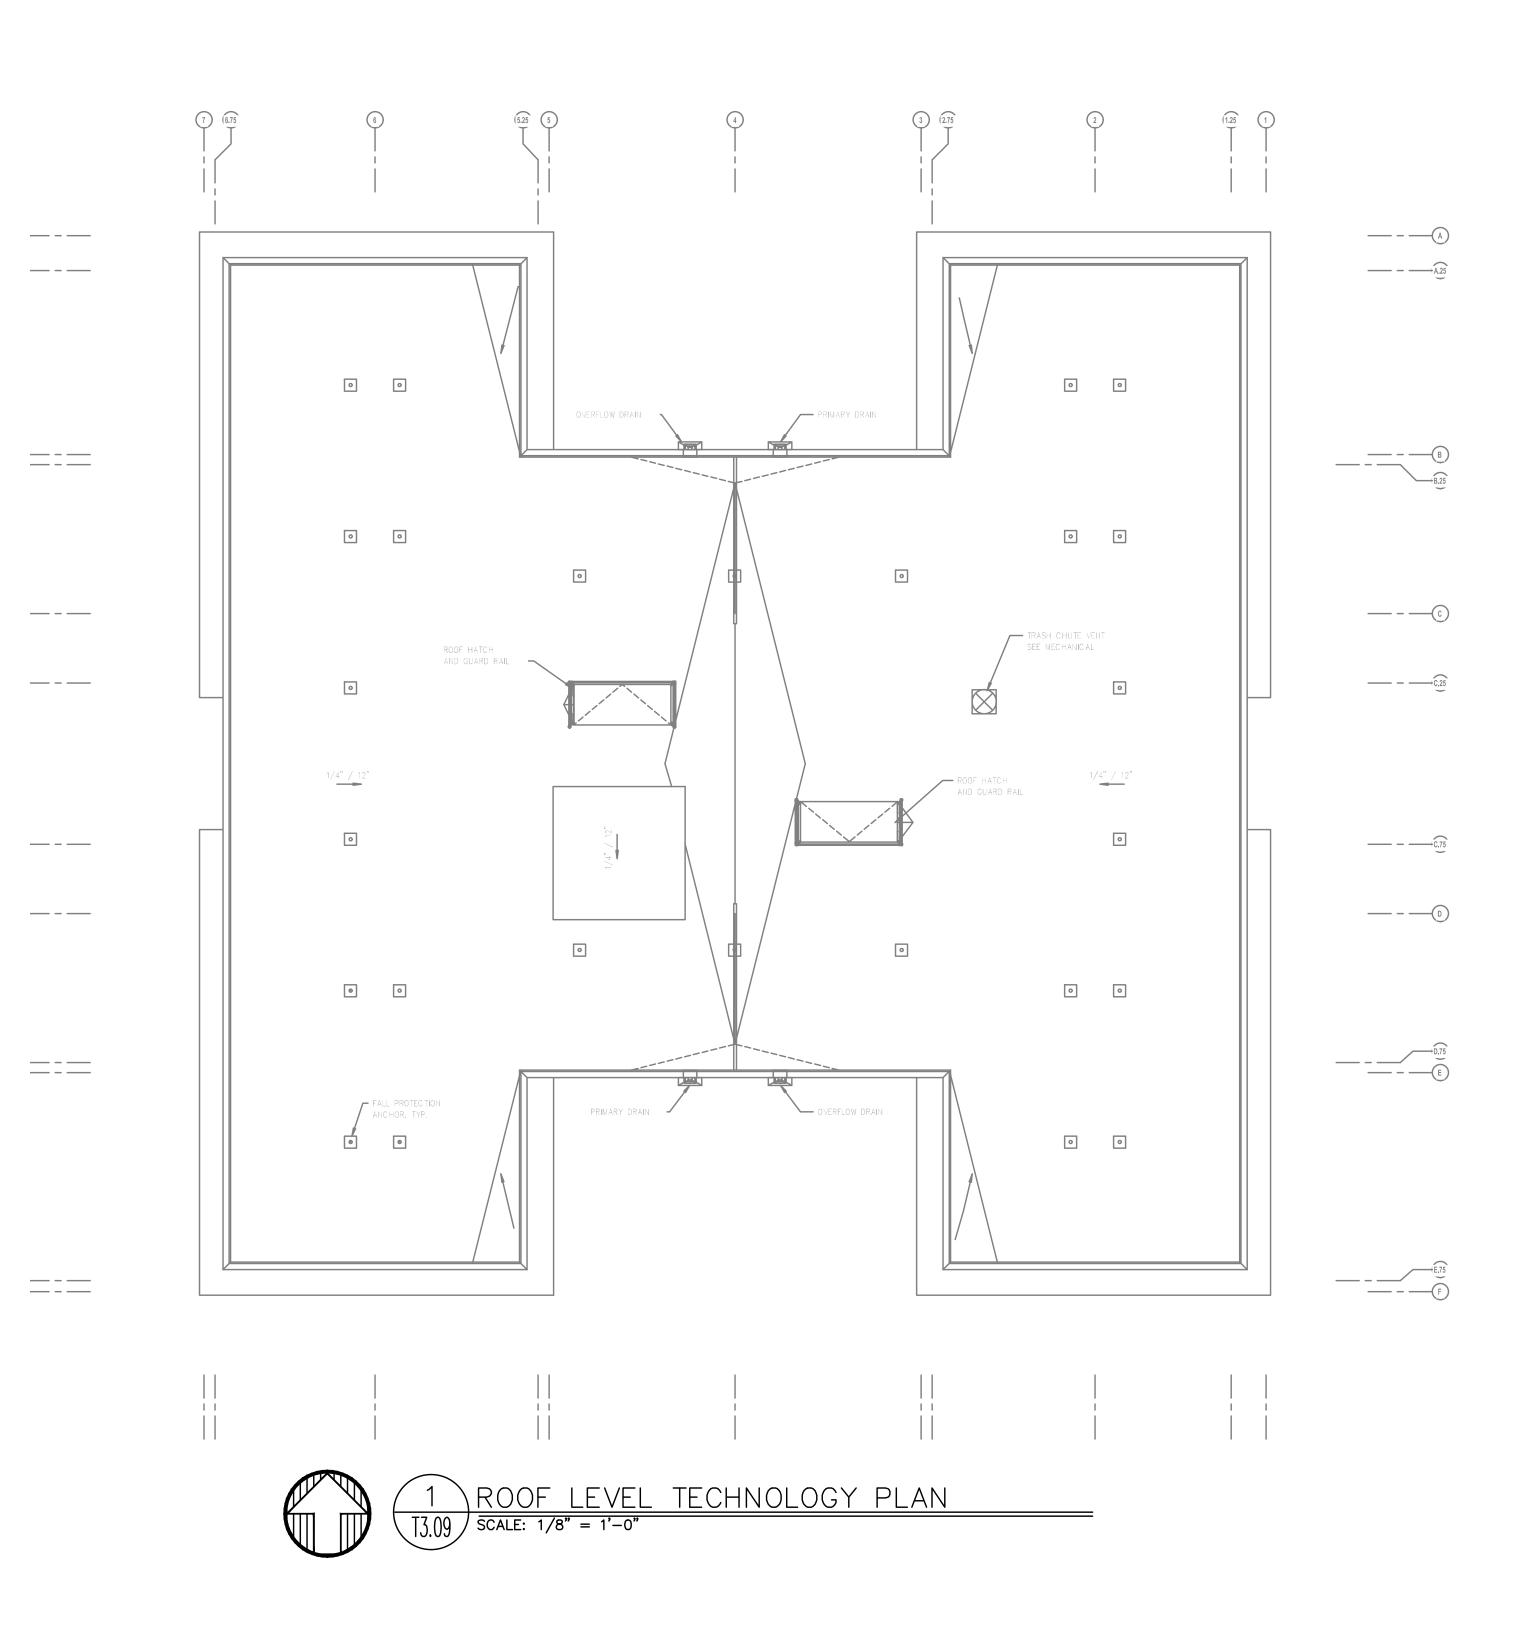- MAY NOT ACCURATELY REFLECT ACTUAL CONTRACTOR SHALL BE RESPONSIBLE FOR COORDINATING THE INSTALLATION OF ALL TO AND DURING CONSTRUCTION.
- C. COORDINATE WITH MECHANICAL PLANS FOR ALARM SYSTEM.
- THREAD ON PLASTIC BUSHING FOR CABLE THAN 18" SEPARATION. COORDINATE WITH ELECTRICAL.
- Ε. DEVICES WILL NOT BE OBSTRUCTED.
- F. REFER TO ENLARGED TYPICAL UNIT PLANS (IF PROVIDED) FOR TYPICAL LAYOUTS FOR ALL APARTMENT UNIT TYPES.

PLAN NOTES: 1. STROBES TO BE PLACED AT 24" AT ELECTRICAL UTILITY REQUEST.

- SWITCHES WITH FIRE SPRINKLER PLANS.
- UTILITY.
- DEMARCATION WITHIN UNIT.
- 5. SMOKE AND CO DETECTORS CAN BE A SINGLE COMBINED UNIT.
- 6. VERIFY EXACT LOCATION AND COUNT OF DUCT DETECTORS WITH MECHANICAL PLANS.

A. TECHNOLOGY DRAWINGS ARE DIAGRAMMATICAL AND CONSTRUCTION CONDITIONS. THE TECHNOLOGY TECHNOLOGY EQUIPMENT, WITH ALL TRADES PRIOR

B. THE TECHNOLOGY CONTRACTOR SHALL REFER TO THE ARCHITECTURAL DRAWINGS FOR ALL MOUNTING HEIGHTS AND FINISHES OF DEVICES AND FIXTURES.

LOCATIONS OF SMOKE, FIRE/SMOKE DAMPERS, AND ROOF TOP UNITS REQUIRING CONNECTION TO FIRE

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COORDINATE ALL DEVICE LOCATIONS WITH LATEST ARCHITECTURAL INTERIOR ELEVATIONS TO VERIFY


2. VERY COUNT AND LOCATION FOR FLOW AND TAMPER

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4. 42" 'RF' TRANSPARENT SMART PANEL FOR UTILITY

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Project Owner: SMART PDX PROPERTIES, LLC

Project Name:

MINNESOTA PLACES

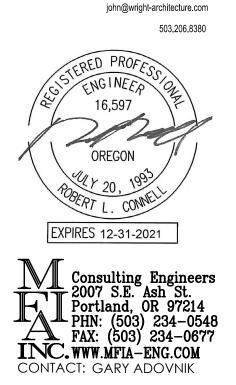
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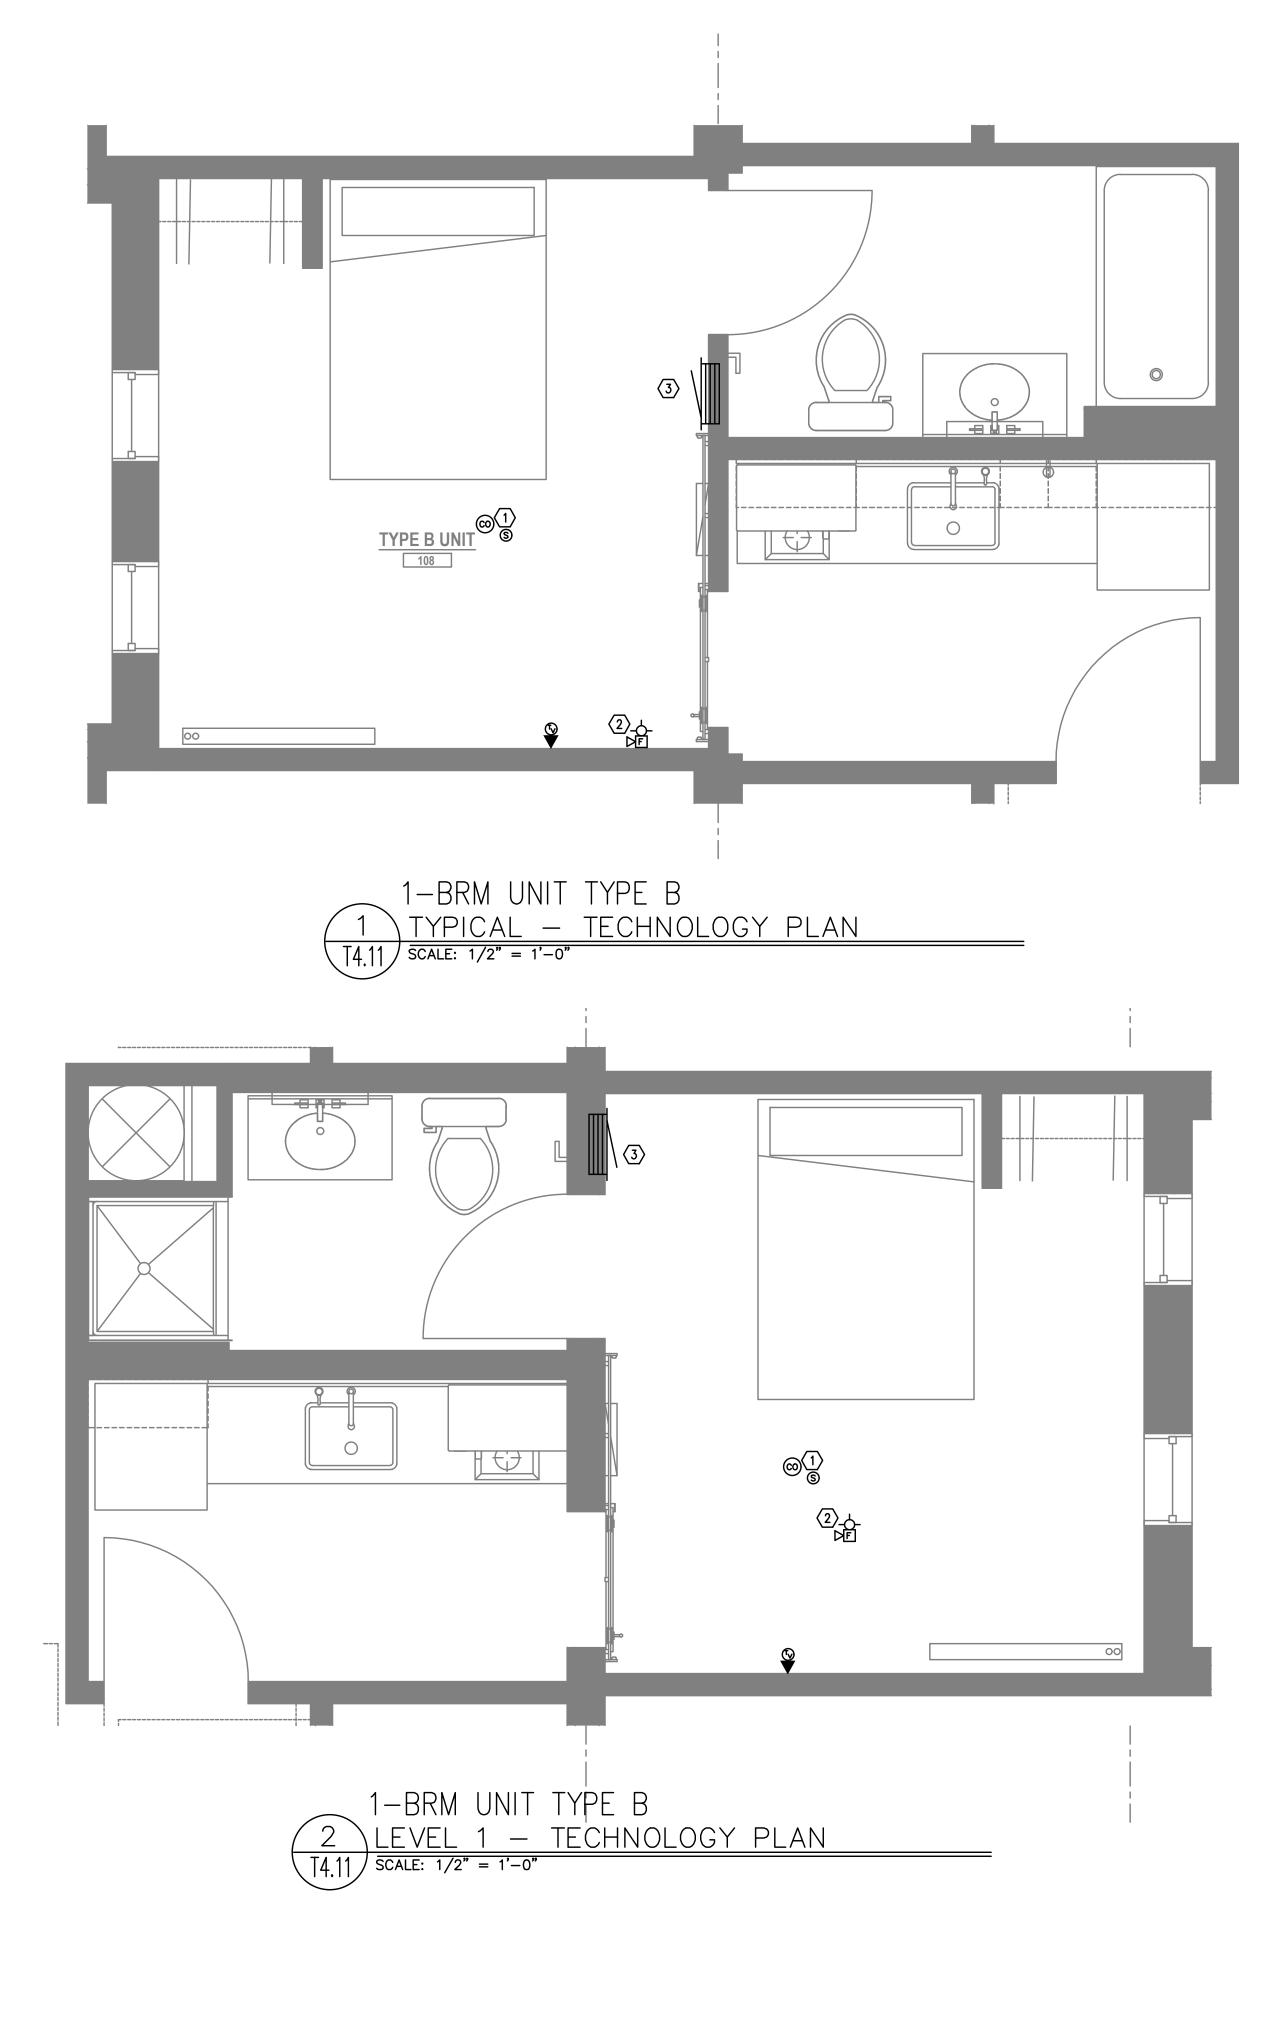
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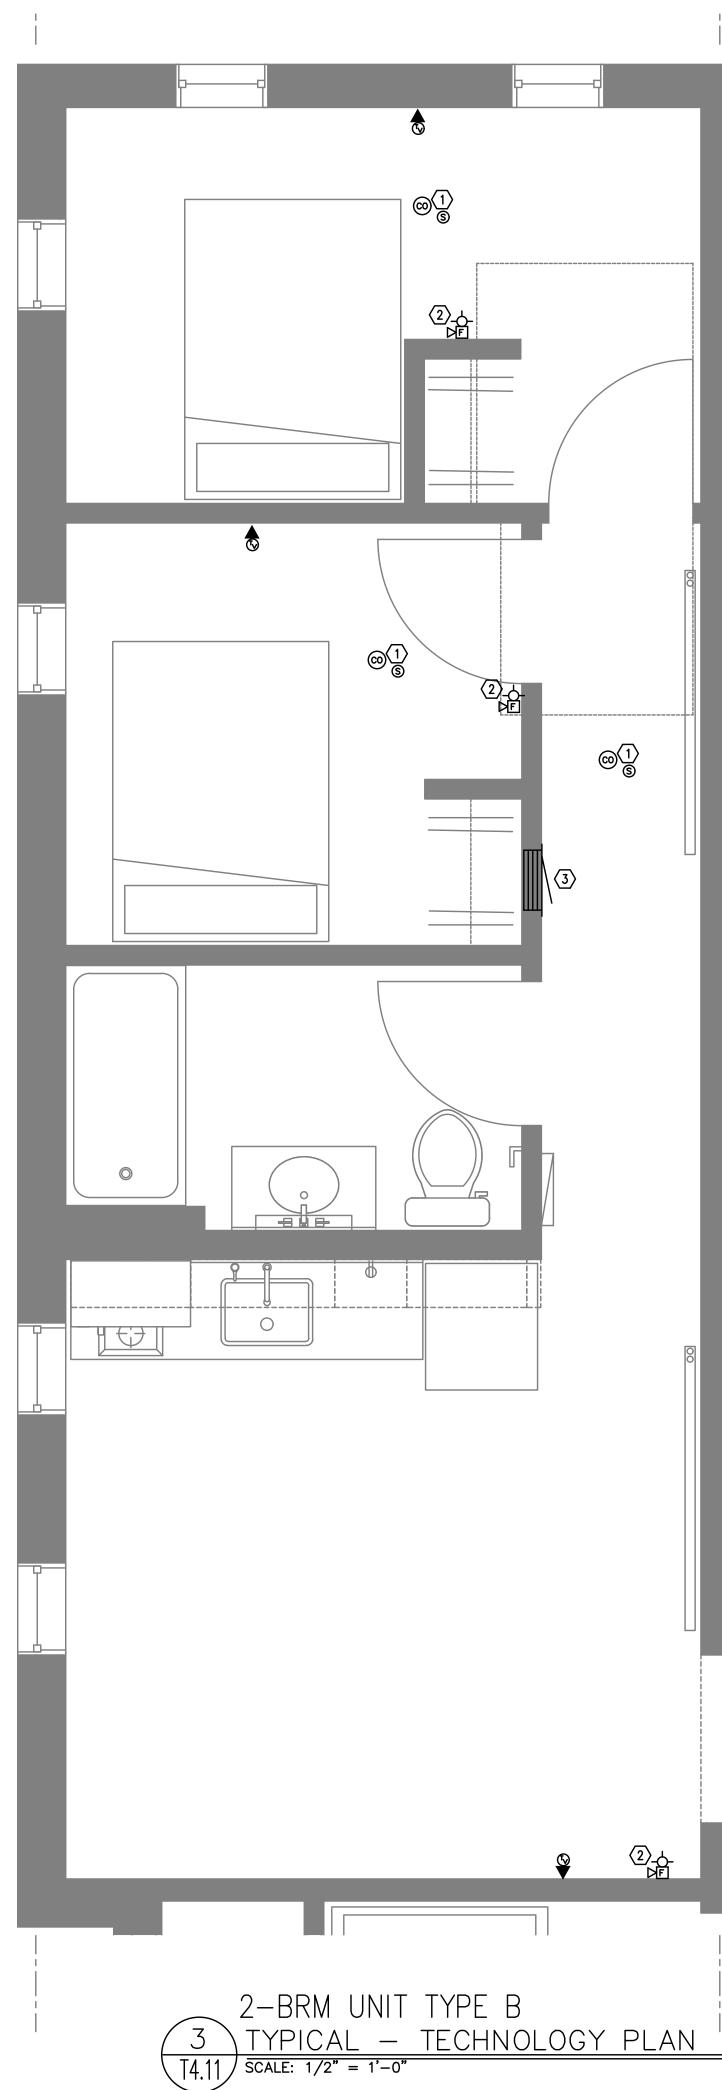
PERMIT SUBMITTAL	8.16.202
Job #:	2020
JUD #.	2020
ORIGINAL SHEET SIZE: 2	24" x 36"

ROOF LEVEL TECHNOLOGY PLAN







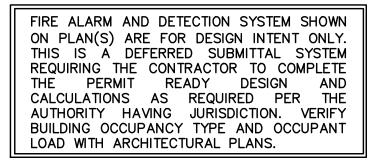

— - — - — (A)



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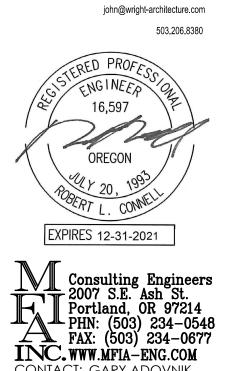
GENERAL NOTES:


- A. ALL PLANS ARE DIAGRAMMATICAL. CONSULT ARCHITECTURAL PLANS FOR EXACT LOCATION OF ALL DEVICES AND FIXTURES.
- B. REFER TO DETAILS ON ELECTRICAL SHEET FOR ADDITIONAL INFORMATION REGARDING ADA REACH REQUIREMENTS FOR OUTLET MOUNTING HEIGHT.
 - C. STANDARD RECEPTACLE MOUNTING HEIGHT IS 18" A.F.F. UNLESS OTHERWISE SPECIFIED. RECEPTACLES LOCATED BELOW WINDOW SILLS SHALL NOT BE LESS THE 15" A.F.F. AS REQUIRED BY CODE. DEVICES LOCATED BELOW WINDOW SILLS MAY BE ROTATED 90" IF NECESSARY. CONTRACTOR TO ADVISE ARCHITECT IMMEDIATELY IF CONFLICT BETWEEN DEVICES AND WINDOW SILLS IS APPARENT.
 - D. COORDINATE WITH ELECTRICAL FOR ROUGH IN OF LOW VOLTAGE DEVICES. REFER TO 'E' SERIES SHEETS FOR ADDITIONAL INFORMATION.

○ NOTES:

— - — - — B

- 1. SMOKE AND 'CO' DETECTOR CAN BE A SINGLE DEVICE.
- 2. FIRE ALARM STROBE/SPEAKER TO REPORT BUILDING FIRE ALARM CONDITIONS.
- 3. 42" HEIGHT 'RF' TRANSPARENT PANEL FOR UTILITY DEMARCATION WITHIN UNIT.



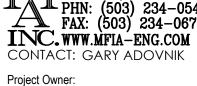

SMART PDX PROPERTIES, LLC

Project Name:

MINNESOTA PLACES

1208 N. JESSUP & 5627 N. MINNESOTA (R226159, R226160)


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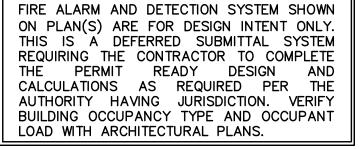
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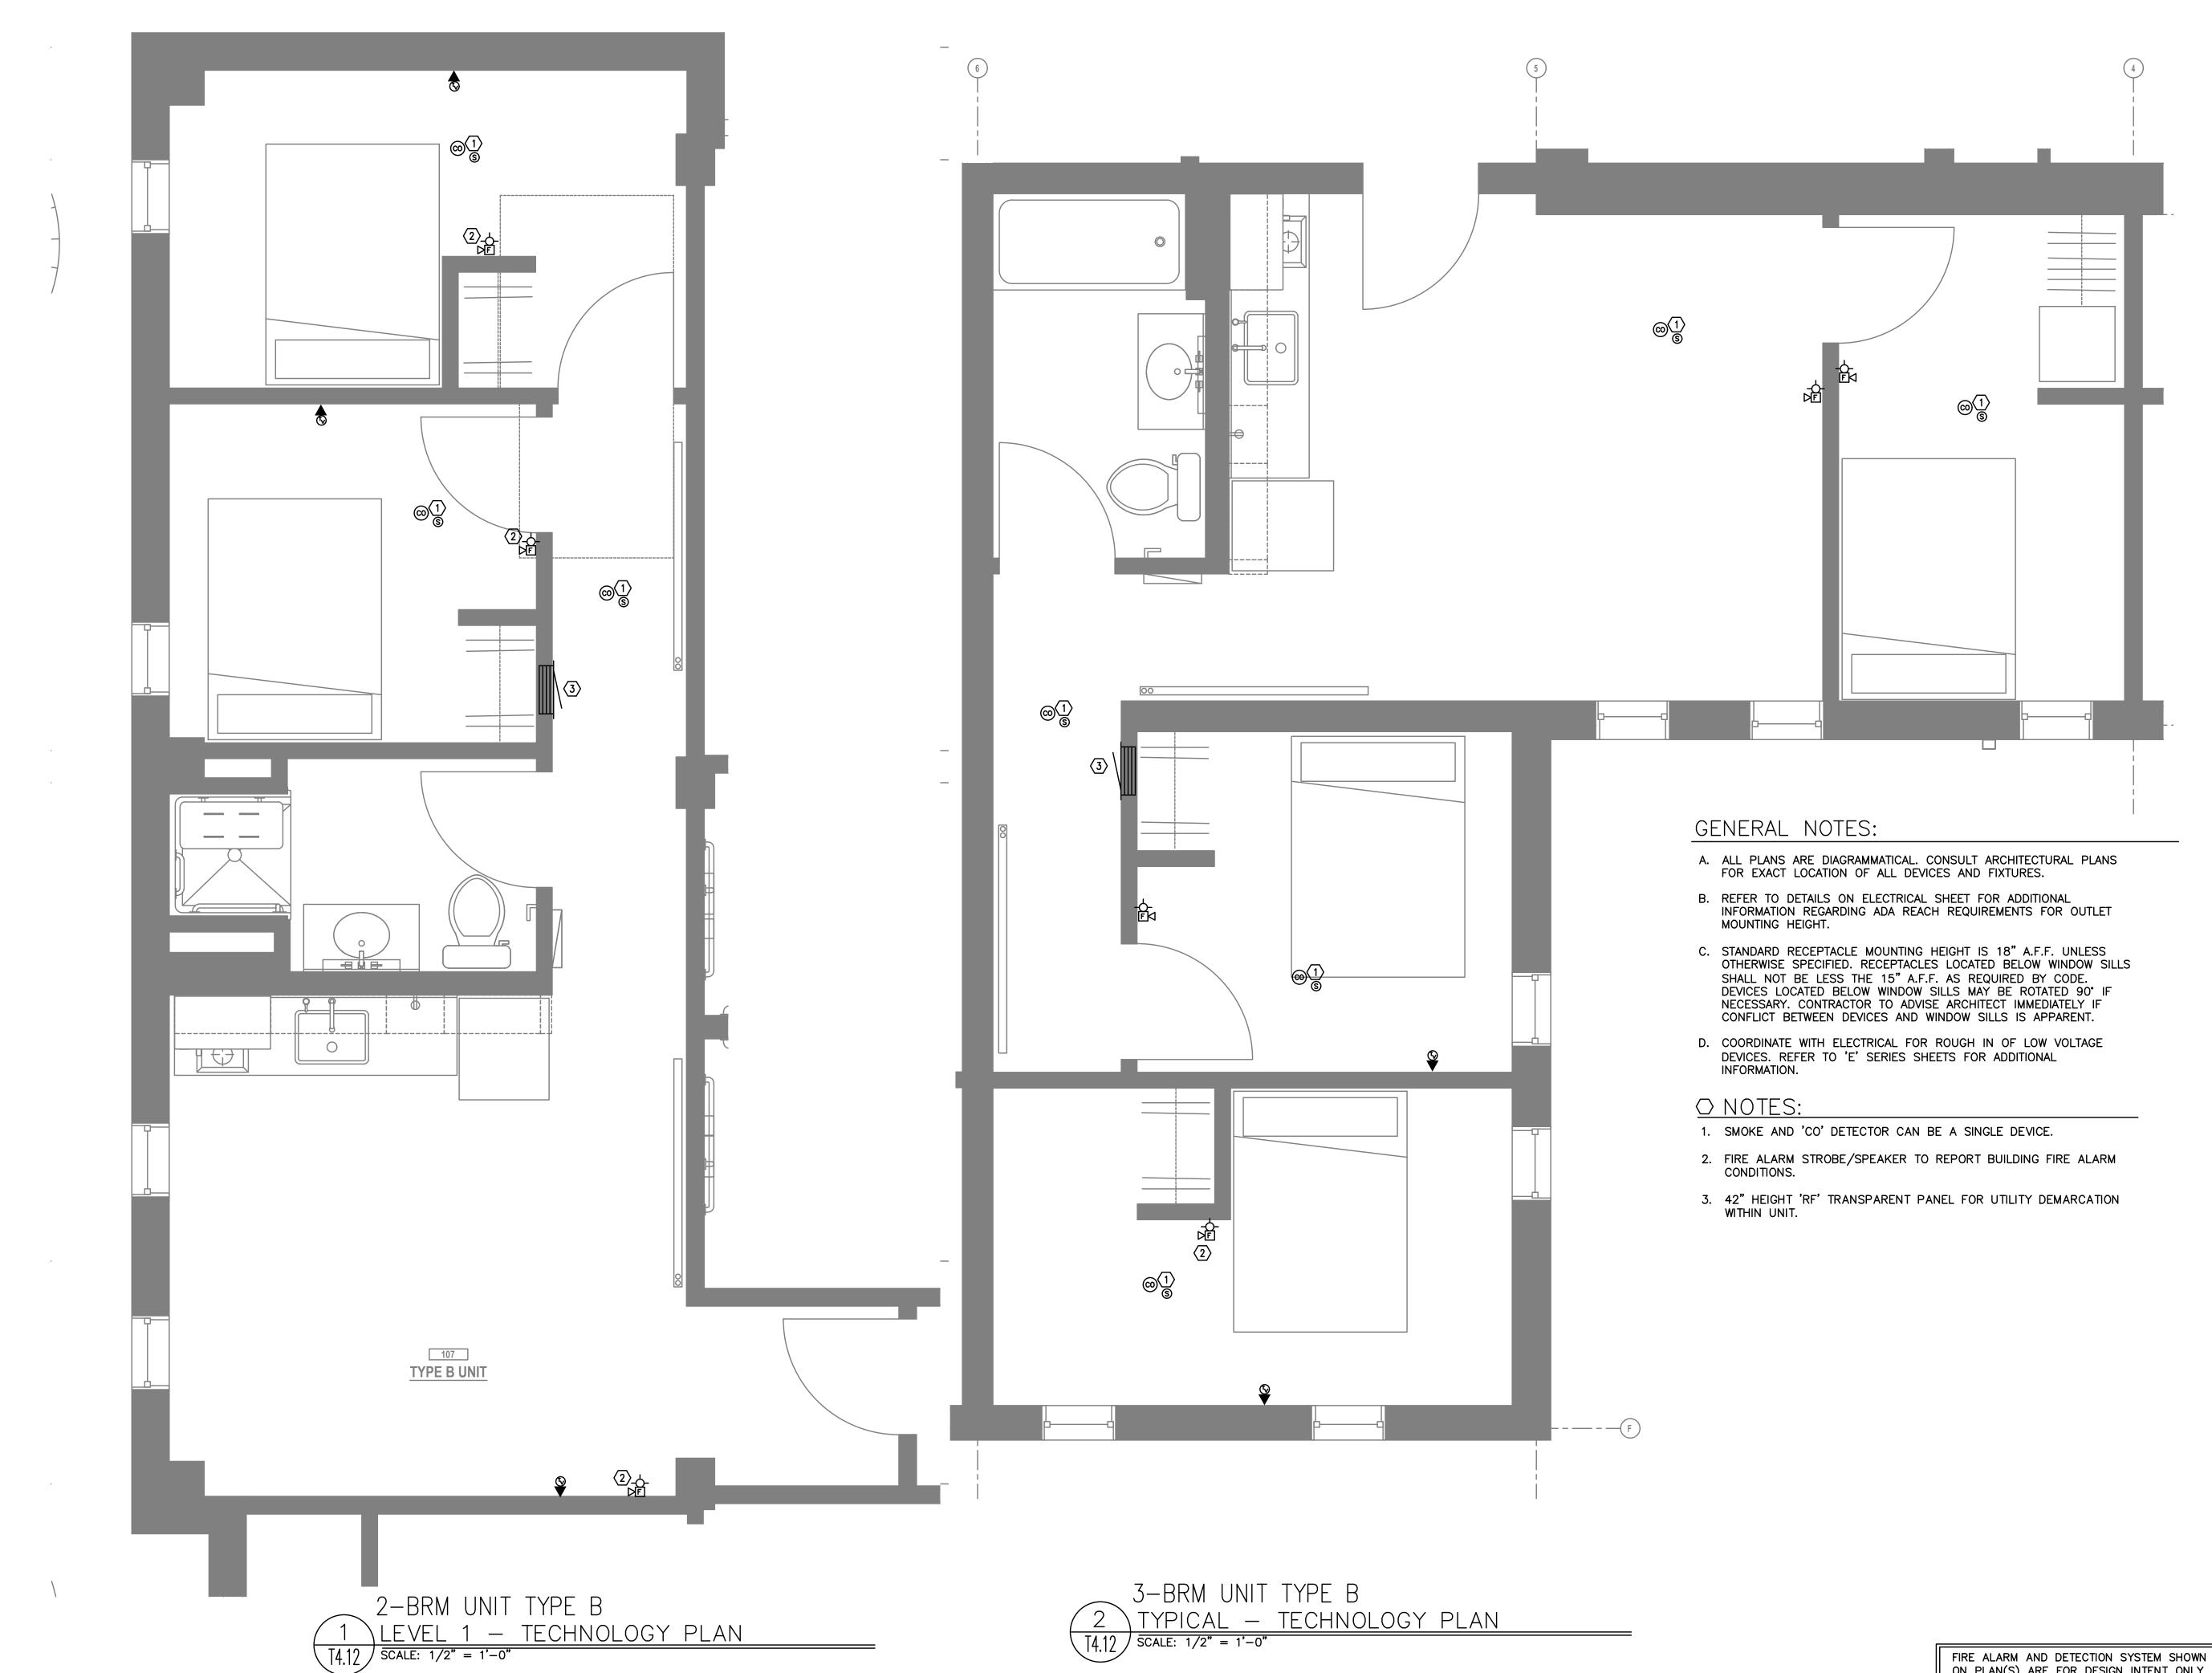
PERMIT SUBMITTAL	8.16.202
Job #:	2020
ORIGINAL SHEET SIZE: 2	24" x 36"
HALF SIZE: 12" x 18"	

TYPICAL UNIT TECHNOLOGY PLANS







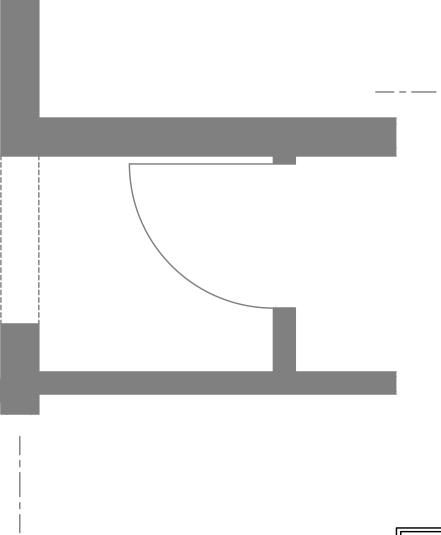

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EXPIRES 12-31-2021

SMART PDX PROPERTIES, LLC

Project Name:

MINNESOTA PLACES


1208 N. JESSUP & 5627 N. MINNESOTA (R226159, R226160)


PERMIT SUBMITTAL

Issued:	
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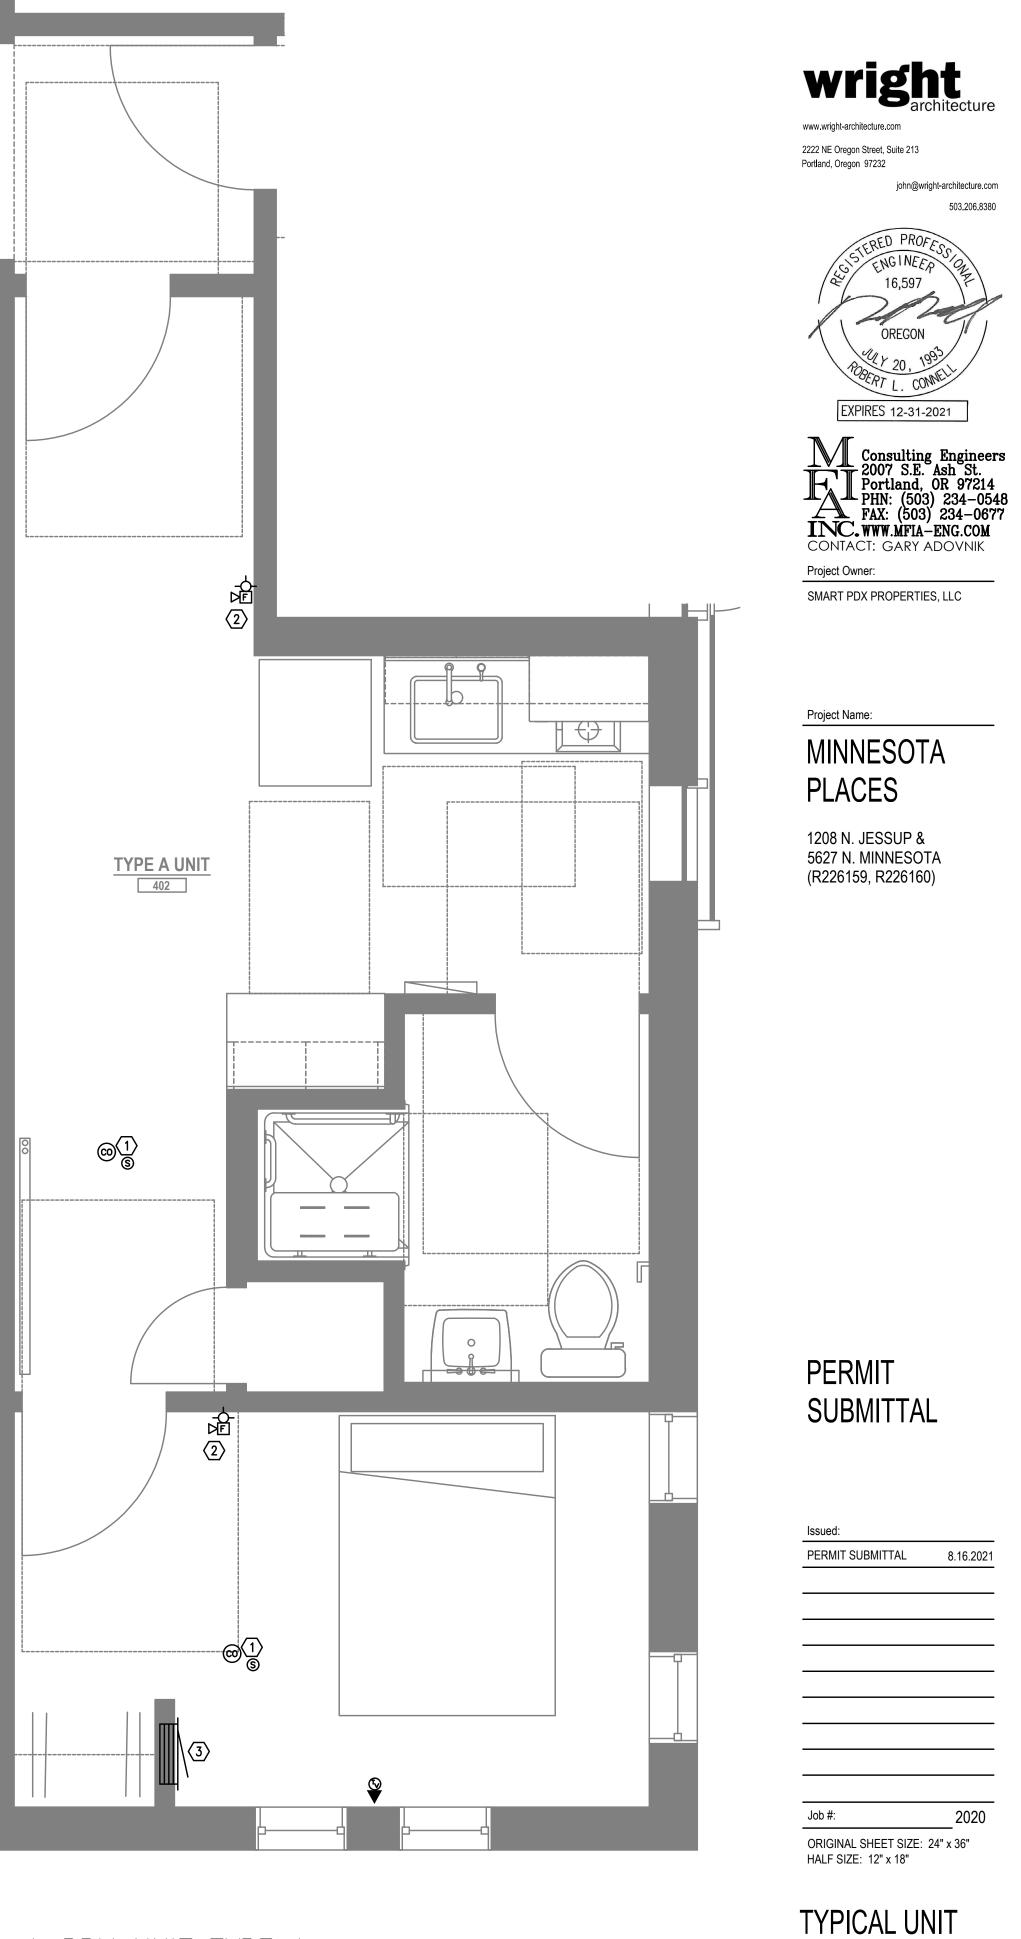
TYPICAL UNIT TECHNOLOGY PLANS

T4.12



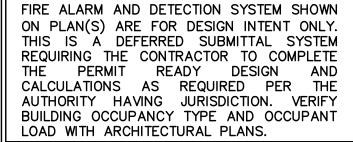

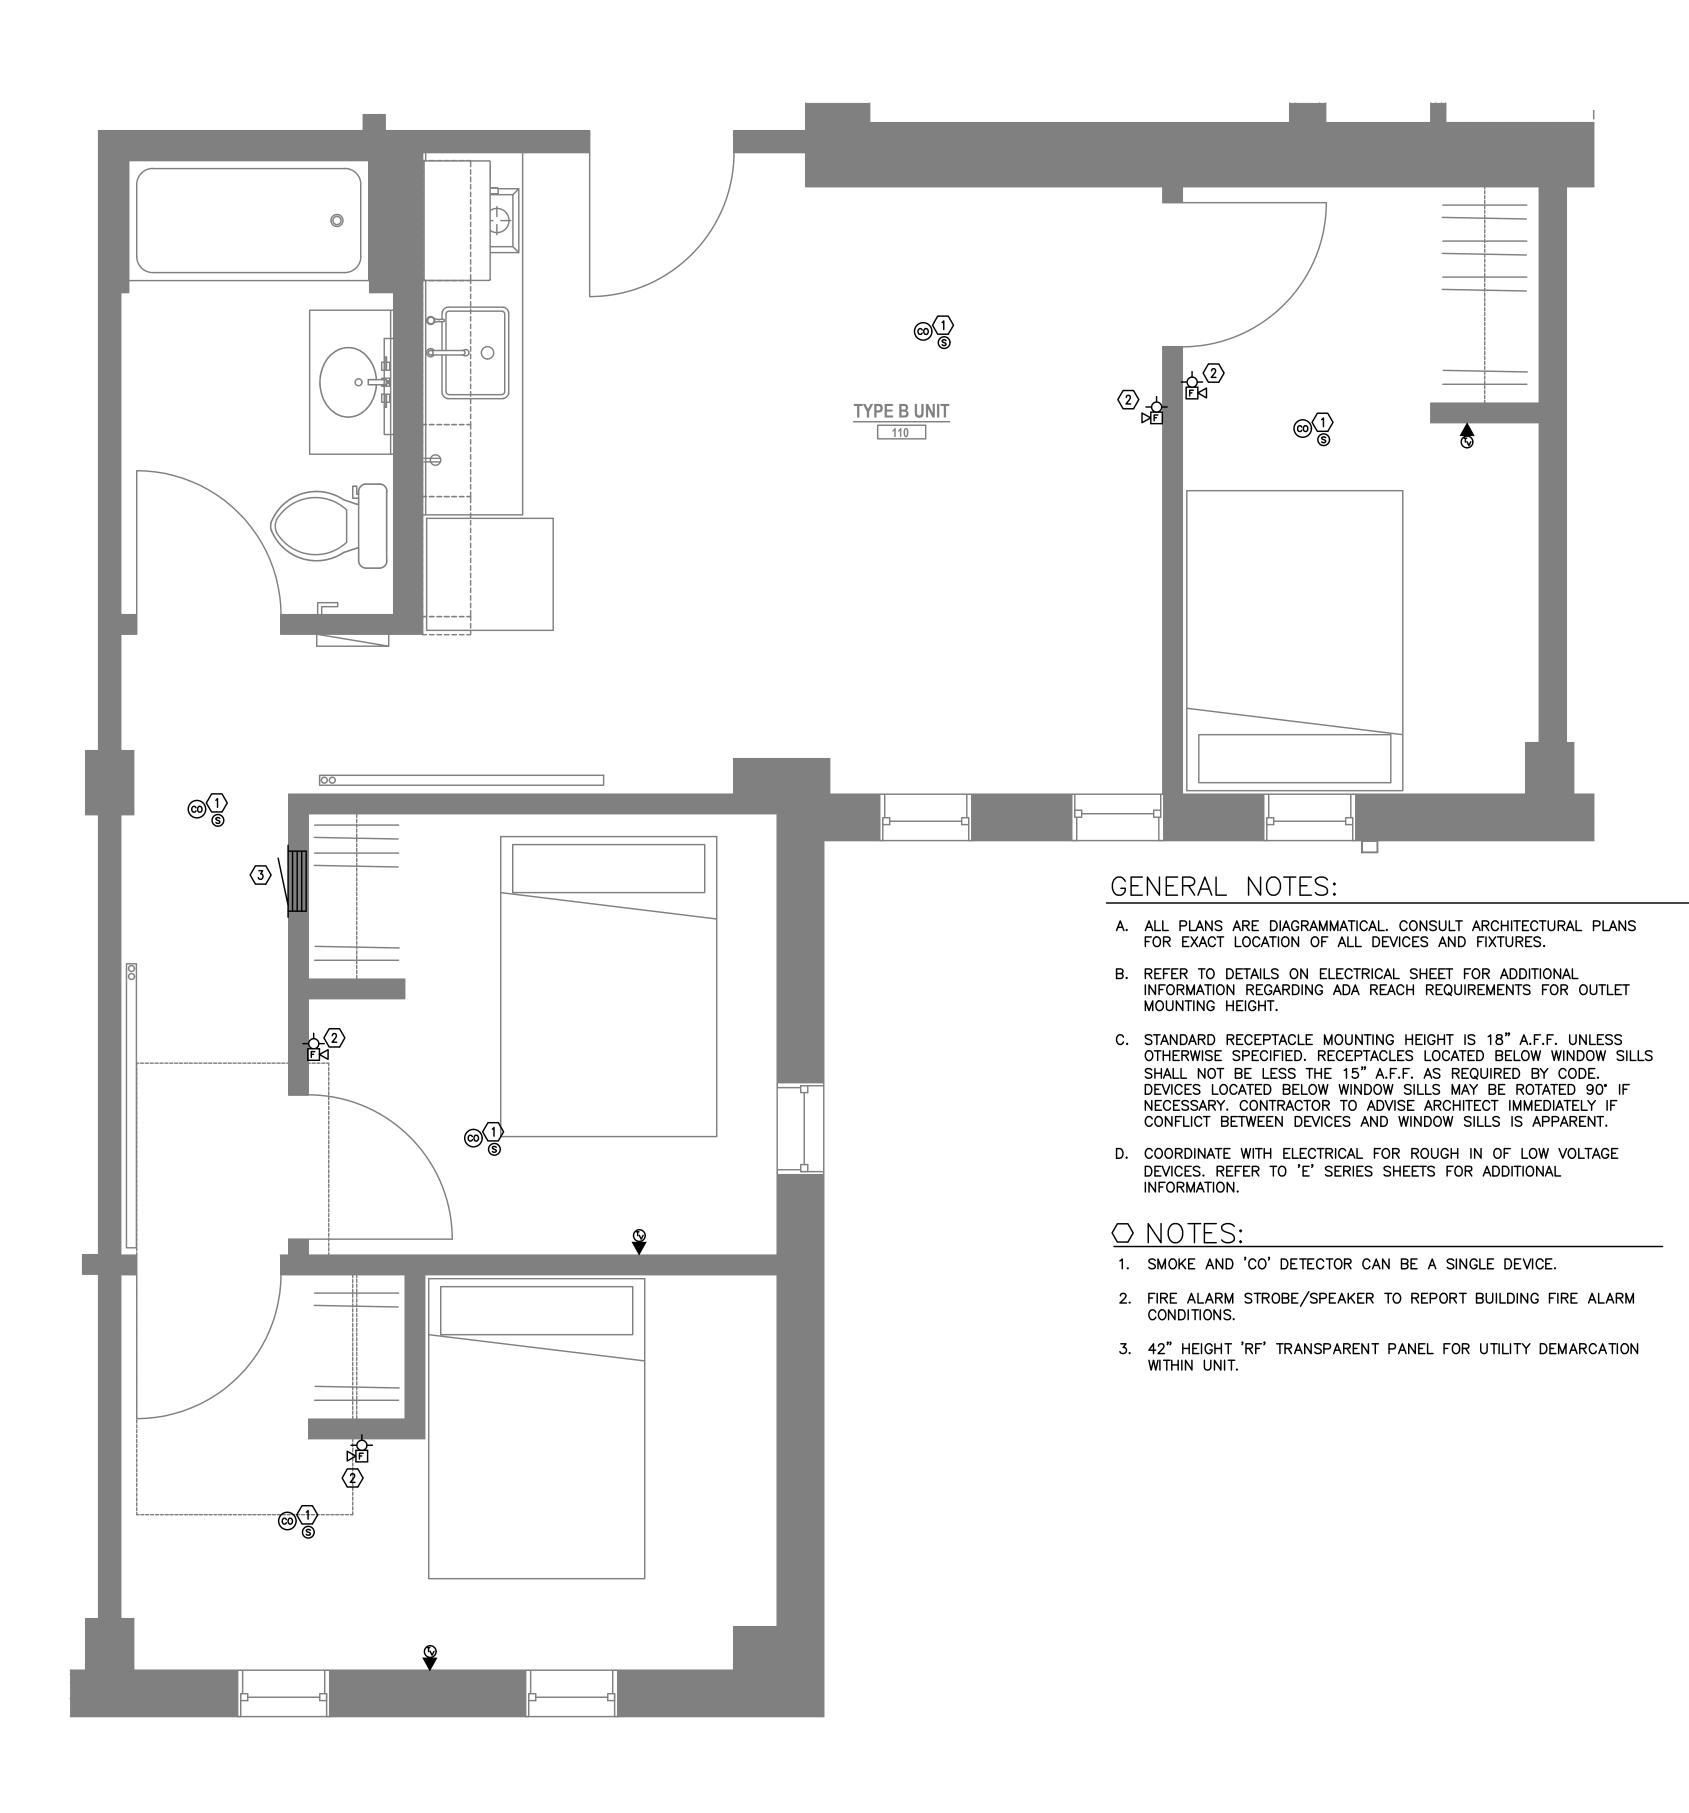3-BRM UNIT TYPE B <u>1 LEVEL 1 - TECHNOLOGY PLAN</u> T4.13 SCALE: 1/2" = 1'-0"




1-BRM UNIT TYPE A 2 LEVEL 4 - TECHNOLOGY PLAN T4.13 SCALE: 1/2" = 1'-0"


FIRE ALARM AND DETECTION SYSTEM SHOWN ON PLAN(S) ARE FOR DESIGN INTENT ONLY. THIS IS A DEFERRED SUBMITTAL SYSTEM REQUIRING THE CONTRACTOR TO COMPLETE THE PERMIT READY DESIGN AND CALCULATIONS AS REQUIRED PER THE AUTHORITY HAVING JURISDICTION. VERIFY BUILDING OCCUPANCY TYPE AND OCCUPANT LOAD WITH ARCHITECTURAL PLANS.

T4.13

TECHNOLOGY

PLANS

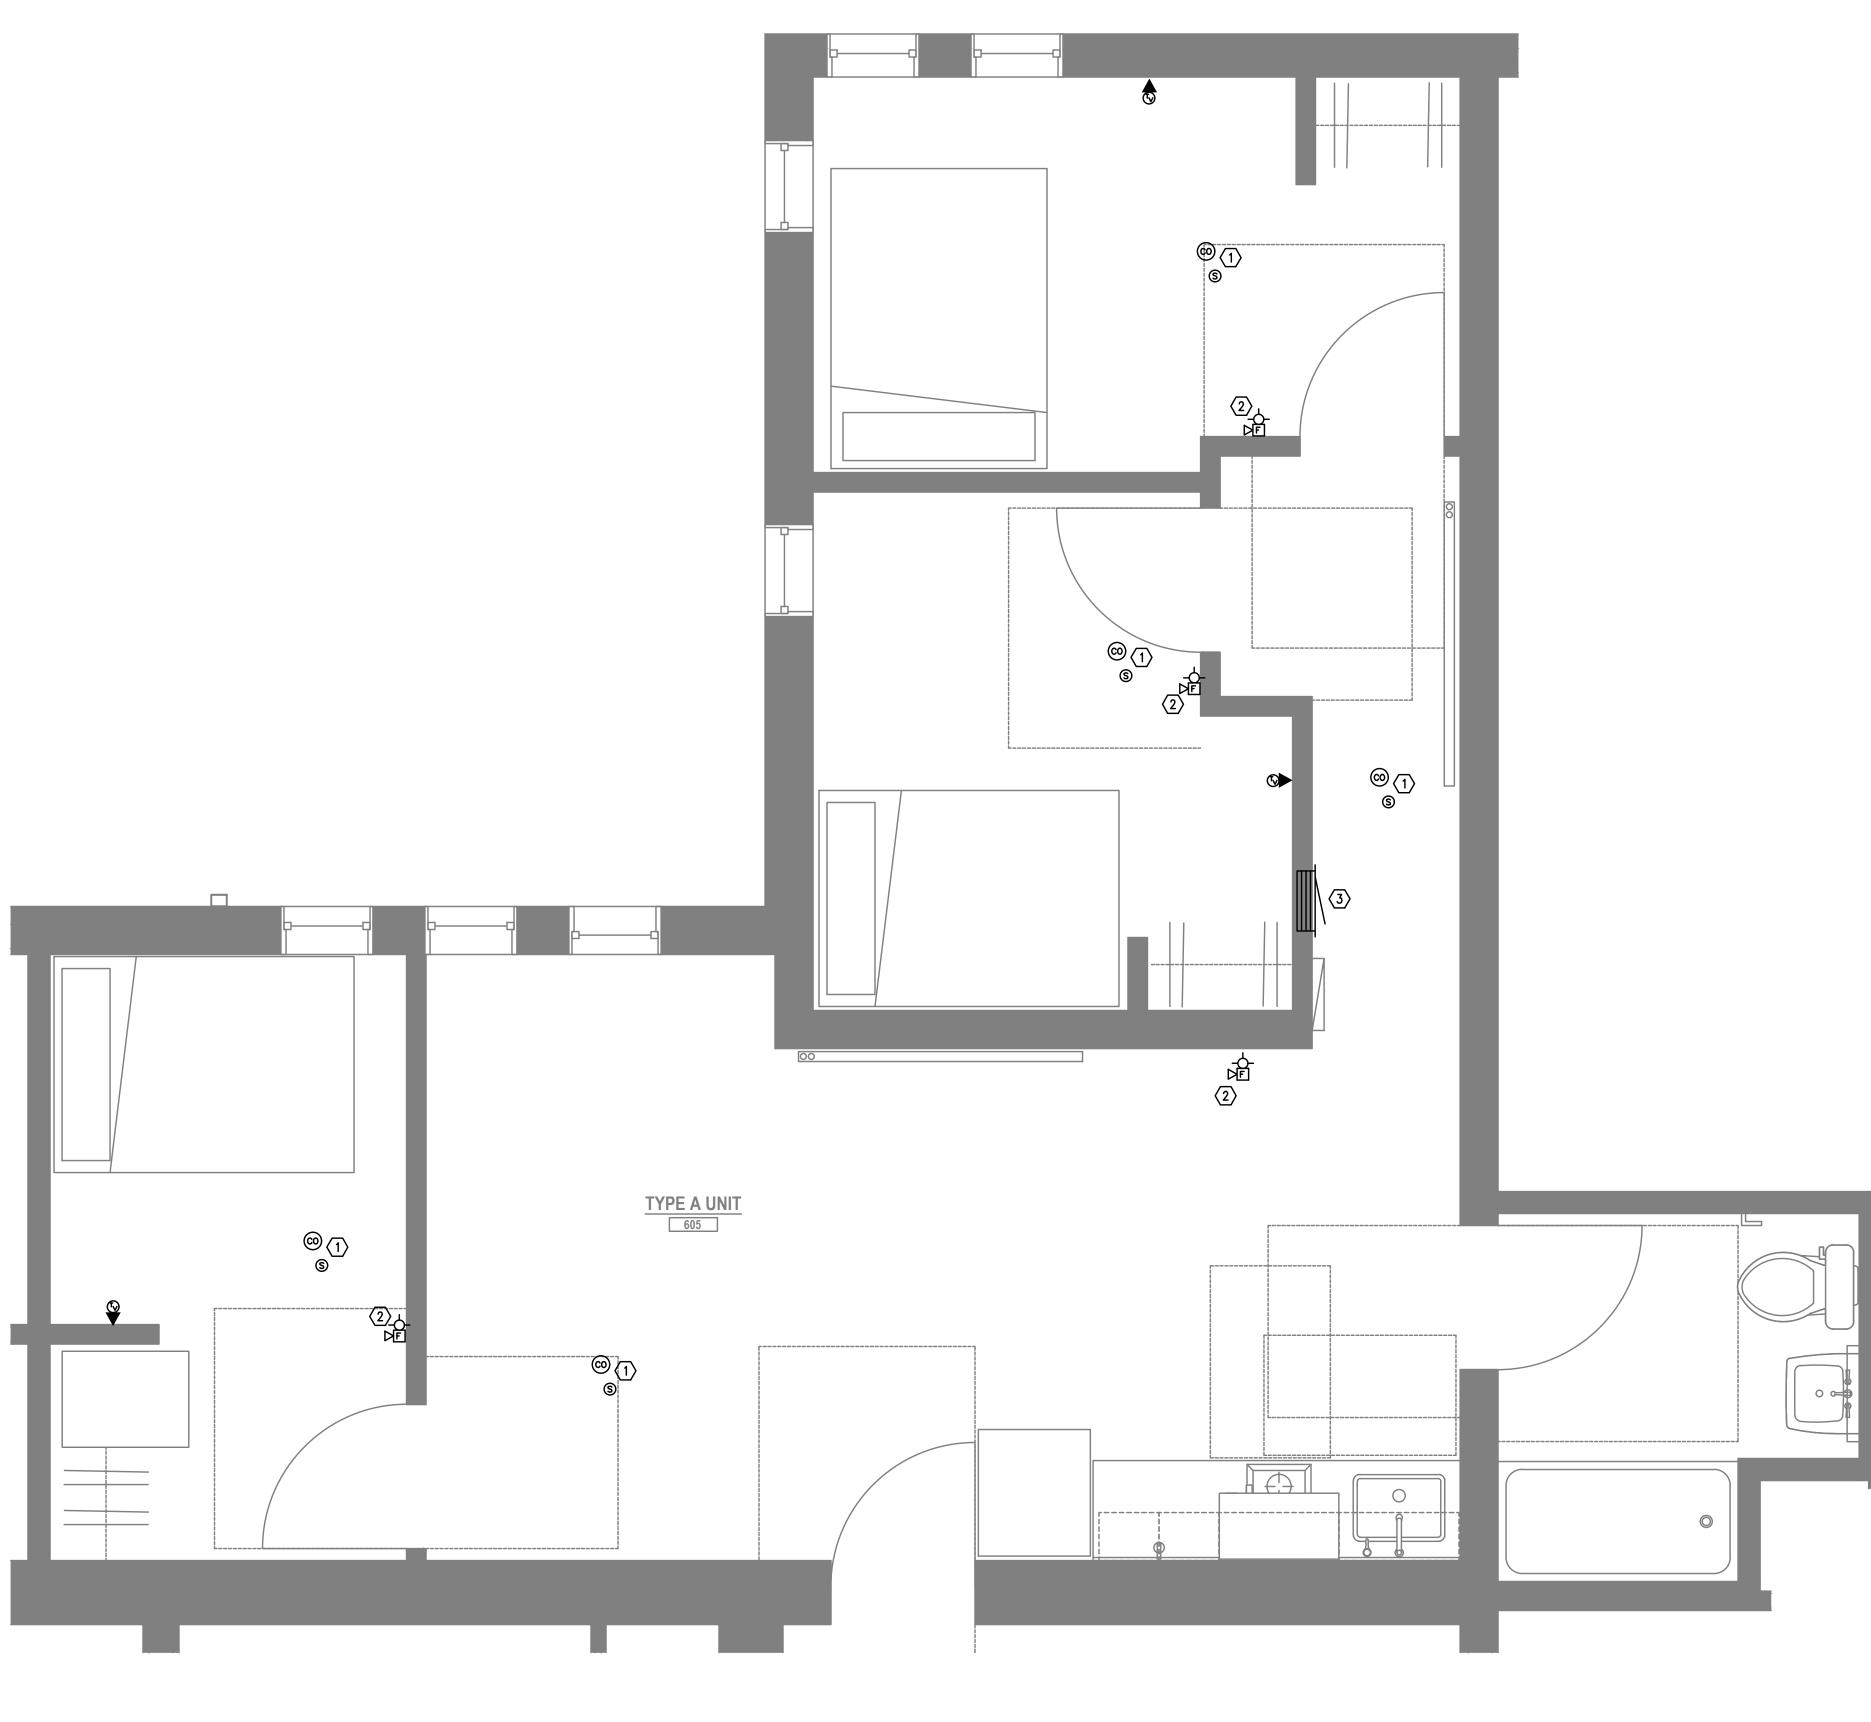

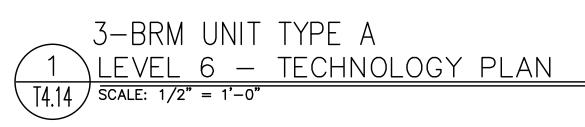

- A. ALL PLANS ARE DIAGRAMMATICAL. CONSULT ARCHITECTURAL PLANS FOR EXACT LOCATION OF ALL DEVICES AND FIXTURES.
- B. REFER TO DETAILS ON ELECTRICAL SHEET FOR ADDITIONAL INFORMATION REGARDING ADA REACH REQUIREMENTS FOR OUTLET MOUNTING HEIGHT.
- C. STANDARD RECEPTACLE MOUNTING HEIGHT IS 18" A.F.F. UNLESS OTHERWISE SPECIFIED. RECEPTACLES LOCATED BELOW WINDOW SILLS SHALL NOT BE LESS THE 15" A.F.F. AS REQUIRED BY CODE. DEVICES LOCATED BELOW WINDOW SILLS MAY BE ROTATED 90° IF NECESSARY. CONTRACTOR TO ADVISE ARCHITECT IMMEDIATELY IF CONFLICT BETWEEN DEVICES AND WINDOW SILLS IS APPARENT.
- D. COORDINATE WITH ELECTRICAL FOR ROUGH IN OF LOW VOLTAGE DEVICES. REFER TO 'E' SERIES SHEETS FOR ADDITIONAL INFORMATION.

○ NOTES:

- 1. SMOKE AND 'CO' DETECTOR CAN BE A SINGLE DEVICE.
- 2. FIRE ALARM STROBE/SPEAKER TO REPORT BUILDING FIRE ALARM CONDITIONS.
- 3. 42" HEIGHT 'RF' TRANSPARENT PANEL FOR UTILITY DEMARCATION WITHIN UNIT.



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Project Owner: SMART PDX PROPERTIES, LLC

Project Name:

MINNESOTA PLACES

1208 N. JESSUP & 5627 N. MINNESOTA (R226159, R226160)

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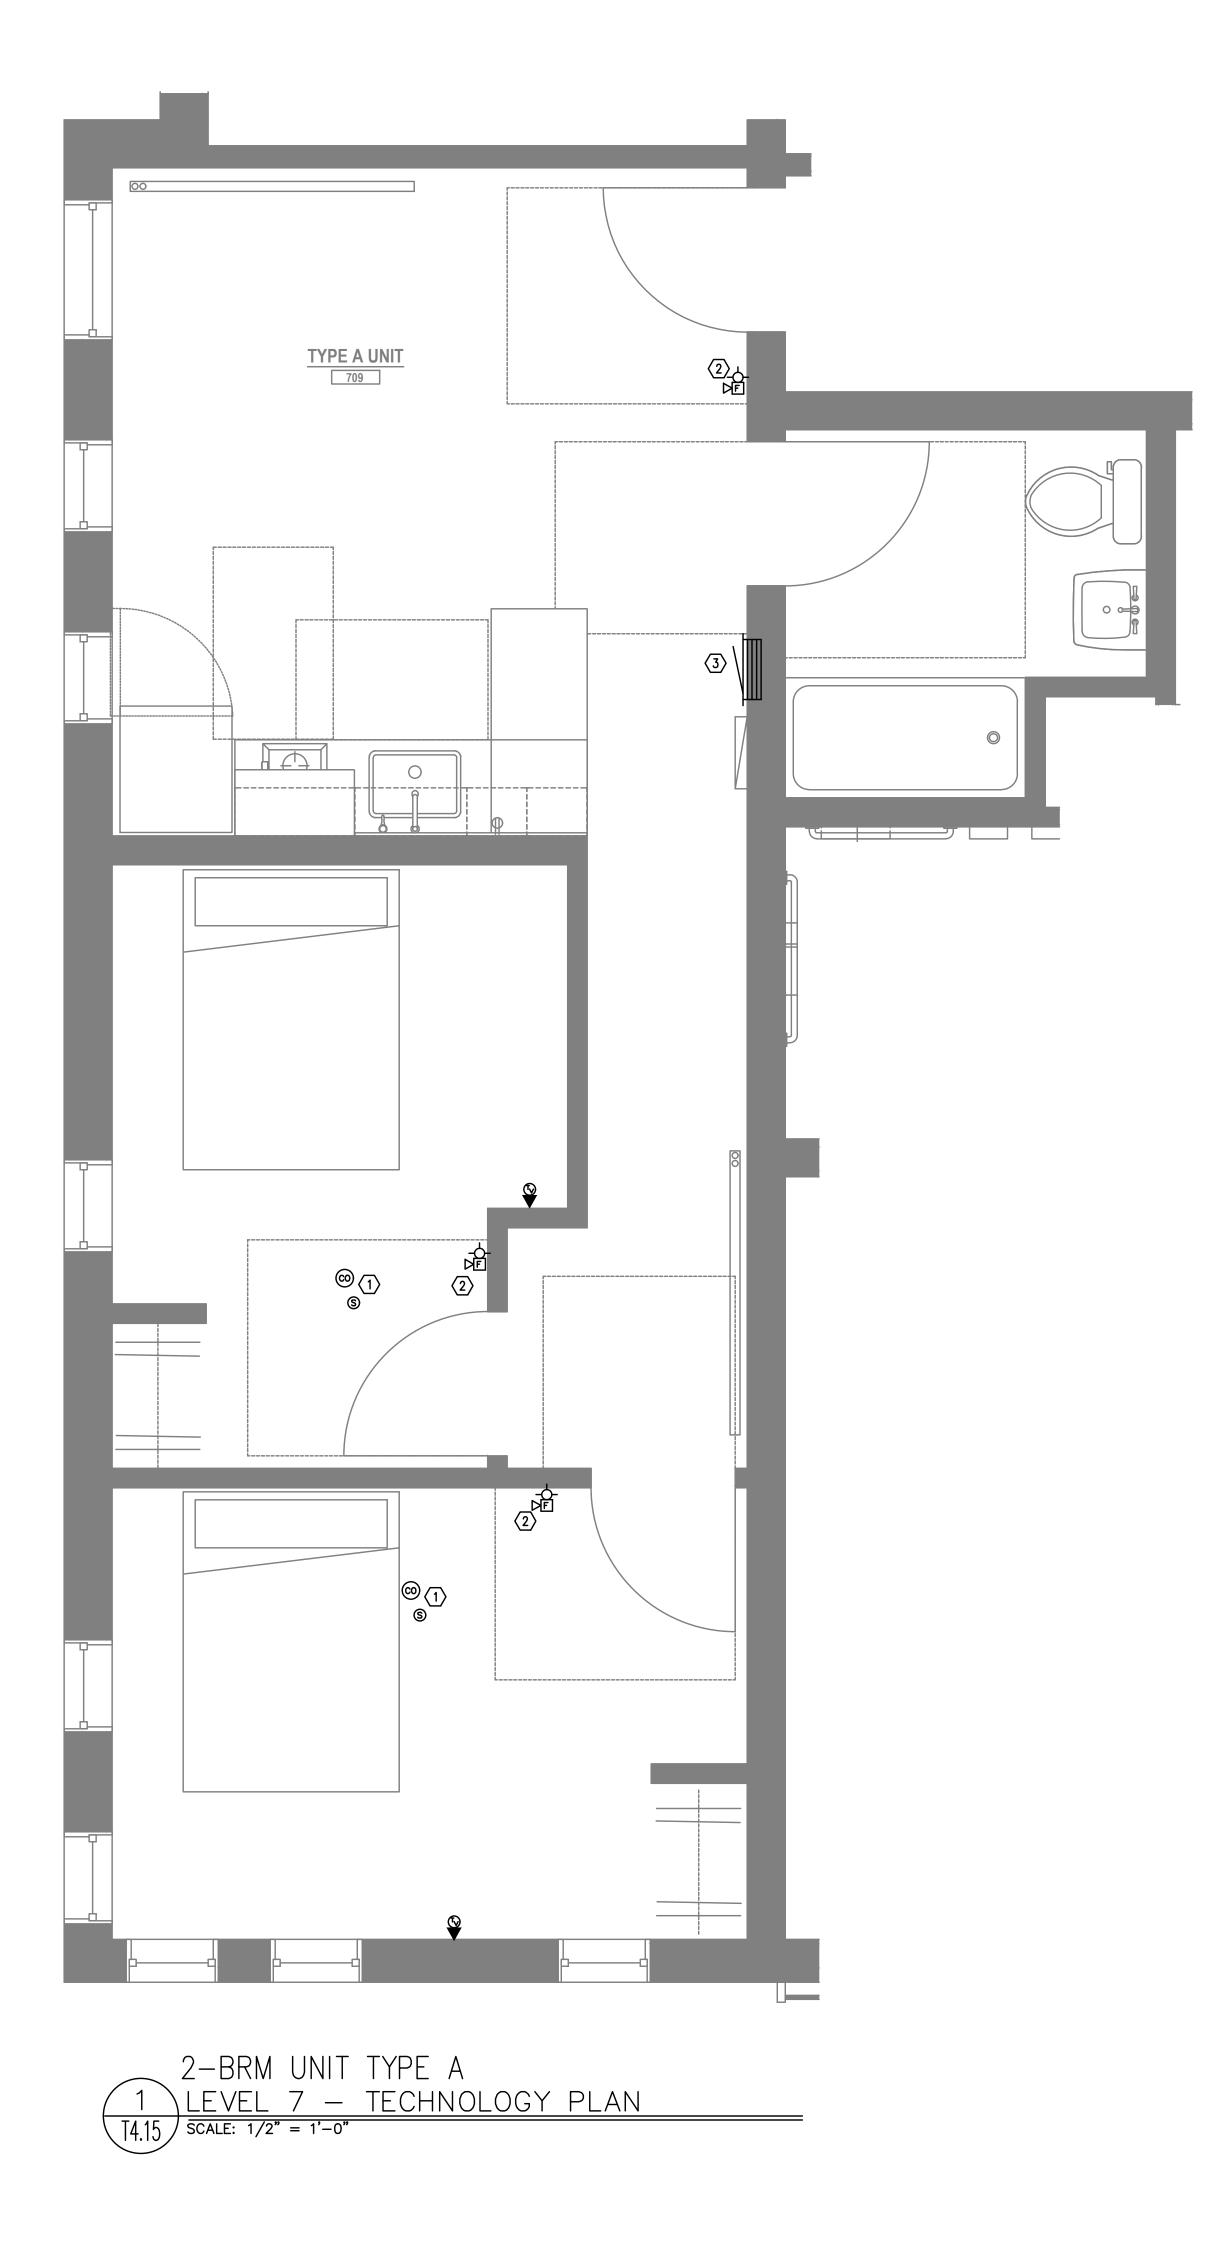
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TYPICAL UNIT TECHNOLOGY PLANS

Drawing Number

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EXPIRES 12-31-2021 Consulting Engineers 2007 S.E. Ash St. Portland, OR 97214 PHN: (503) 234-0548 FAX: (503) 234-0677 INC. WWW.MFIA-ENG.COM CONTACT: GARY ADOVNIK

Project Owner: SMART PDX PROPERTIES, LLC

Project Name:

MINNESOTA PLACES

1208 N. JESSUP & 5627 N. MINNESOTA (R226159, R226160)

PERMIT SUBMITTAL

Issued:	
PERMIT SUBMITTAL 8	8.16.2021
-	
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ORIGINAL SHEET SIZE: 24" x HALF SIZE: 12" x 18"	36"

TYPICAL UNIT TECHNOLOGY PLANS



