

GENERAL NOTES:

L_____

- A. TECHNOLOGY DRAWINGS ARE DIAGRAMMATICAL AND MAY NOT ACCURATELY REFLECT ACTUAL CONSTRUCTION CONDITIONS. THE TECHNOLOGY CONTRACTOR SHALL BE RESPONSIBLE FOR COORDINATING THE INSTALLATION OF ALL TECHNOLOGY EQUIPMENT, WITH ALL TRADES PRIOR TO AND DURING CONSTRUCTION.
- B. TECHNOLOGY ENTRANCE LOCATION DESIGN IS BASED ON INFORMATION PROVIDED BY THE UTILITY THRU THE DESIGN PROCESS. HOWEVER IT IS UP TO THE CONTRACTOR TO VERIFY CONDITIONS AND REQUIREMENTS HAVE NOT CHANGED PRIOR TO THE INSTALLATION DATE.
- C. COORDINATE WITH LOCAL UTILITY PROVIDER FOR EXACT SERVICE CONDUIT SIZES AND LOCATION TO ROUTE TO CONDUIT TO.
- D. CUSTOMER TO PROVIDE ALL TRENCHING AND BACKFILLING. TRENCH TO BE 36 INCHES DEEP AND 30 INCHES WIDE, MEASURED FROM FINAL GRADE.
- E. THE TECHNOLOGY CONTRACTOR SHALL REFER TO THE ARCHITECTURAL DRAWINGS FOR ALL MOUNTING HEIGHTS AND FINISHES OF DEVICES AND FIXTURES.
- F. COORDINATE WITH MECHANICAL PLANS FOR LOCATIONS OF SMOKE, FIRE/SMOKE DAMPERS, AND ROOF TOP UNITS REQUIRING CONNECTION TO FIRE ALARM SYSTEM.
- G. FOR VOICE/DATA OUTLETS PROVIDE A SINGLE GANG MUD-RING WITH A 1" CONDUIT FROM THE TOP OF THE MUD-RING TO ACCESSIBLE CEILING SPACE. TERMINATE CONDUIT WITH END CONNECTORS AND THREAD ON PLASTIC BUSHING FOR CABLE PROTECTION. OUTLET SHALL BE AT THE SAME HEIGHT AS ADJACENT POWER OUTLET AND LESS THAN 18" SEPARATION. COORDINATE WITH ELECTRICAL.
- H. COORDINATE ALL DEVICE LOCATIONS WITH LATEST ARCHITECTURAL INTERIOR ELEVATIONS TO VERIFY DEVICES WILL NOT BE OBSTRUCTED.
- I. REFER TO ENLARGED TYPICAL UNIT PLANS (IF PROVIDED) FOR TYPICAL LAYOUTS FOR ALL APARTMENT UNIT TYPES.

	$> N \qquad $	<u> </u>		
F	FIRE ALARM SYMBOLS FIRE ALARM MANUAL PULL STATION, +48" A.F.F.		<u>SECURITY SYMBOLS</u> cctv camera	A.F.F.
⊡	MAGNETIC DOOR HOLDER SMOKE DETECTOR, DUCT, IONIZATION TYPE W/SAMPLING TUBE	® _{ptz} ⊡<'X'	DOME CAMERA (W/ PTZ OR FIX)	APP. C
₽- 0 0	SMOKE DETECTOR, DUCT, PHOTO TYPE W/SAMPLING TUBE SMOKE DETECTOR, IONIZATION TYPE	G.B.	INTRUSION SENSOR ('X' INDICATES DEG. OF COVERAGE) GLASS BREAK SENSOR	C.O. CATV
® ®	SMOKE DETECTOR, PHOTO TYPE HEAT DETECTOR, RATE-OF-RISE OR FIXED TEMP.	K	DOOR POSITION SENSOR KEYPAD +48" A.F.F.	CCTV CLG
	FIRE MAIN FLOW DETECTION SWITCH FIRE MAIN TAMPER DETECTION SWITCH	C.R. E.L.	PROXIMITY CARD READER +48" A.F.F. ELECTRIC LATCH/LOCK	(E) FACP
පූර්-ලූ පුර	FIRE ALARM BELL, +80" A.F.F., U.O.N. FIRE ALARM SPEAKER, +80" A.F.F.	REX	REQUEST TO EXIT DEVICE	FP FS
Ĕ⊲ ⁻or Œ	FIRE ALARM SPEAKER/STROBE, +80" TO 96" A.F.F. FIRE ALARM STROBE, +80" TO 96" A.F.F.		APPROX. CAMERA VIEW	FSD GND
	FIRE ALARM INPUT MODULE FIRE ALARM OUTPUT MODULE	ENTRY	APARTMENT ENTRY SYSTEM	l R JB
FACP FARA	FIRE ALARM CONTROL PANEL FIRE ALARM REMOTE ANNUNCIATOR		PAGING AND	N.I.C. OFCI
8 ©	STAND ALONE - RESIDENTIAL SMOKE DETECTOR 120V W/ BATTERY CARBON MONOXIDE DETECTOR RESIDENTIAL 120V W/ BATTERY	S	INTERCOM SYMBOLS ceiling mounted speaker	OFOI P.A.
		_ ⊗⊣	WALL MOUNTED SPEAKER	P.E.T. SD
	NOTATIONS		SIGNAL BUZZER	TS
	DRAWING NOTE		SIGNAL HORN VOLUME CONTROL +48" A.F.F.	TTB TYP.
2 E3	DETAIL REFERENCE: TOP=DETAIL NO., BOTTOM=SHEET NO.	ZO1		U.G. U.O.N.
EF 2	MECHANICAL EQUIPMENT MARK NO. (SEE EQUIPMENT SCHEDULE)		- HOMERUN TO EQUIPMENT ~ ZONE INDICATION	W.G. W.P.
AAA	EQUIPMENT NO. (SEE EQUIPMENT SCHEDULE)		-SPEAKER CONNECTION, NOT INDICATING CABLE PATH	X.P.

FIRE ALARM GENERAL NOTES:

A. HIGH-RISE BUILDING SHALL BE PROVIDED WITH AN AUTOMATIC SMOKE DETECTION SYSTEM IN ACCORDANCE WITH SECTION 907.2.12.1, A FIRE DEPARTMENT COMMUNICATION SYSTEM IN ACCORDANCE WITH SECTION 907.2.12.2 AND AN EMERGENCY VOICE ALARM COMMUNICATION SYSTEM IN ACCORDANCE WITH SECTION 907.5.2.2.


B. AREA SMOKE DETECTION IN ACCORDANCE WITH 907.2.12.1.1 SHALL BE CONNECTED TO AN AUTOMATIC FIRE ALARM SYSTEM. THE ACTIVATION OF ANY DETECTOR REQUIRED BY THIS SECTION SHALL ACTIVATE THE EMERGENCY VOICE ALARM SYSTEM IN ACCORDANCE WITH SECTION 907.5.2.2. IN ADDITION TO SMOKE DETECTORS REQUIRED BY SECTIONS 907.2.1 THROUGH 907.2.9 SMOKE DETECTORS SHALL ALSO BE LOCATED IN ROOMS HOUSING MECHANICAL EQUIPMENT, ELECTRICAL EQUIPMENT AND/OR TRANSFORMERS, TELEPHONE EQUIPMENT OR SIMILAR ROOM NOT EQUIPPED WITH A SPRINKLER PROTECTION. ALSO, EACH ELEVATOR MACHINE ROOM, MACHINERY SPACE, CONTROL ROOM, AND ELEVATOR LOBBIES.

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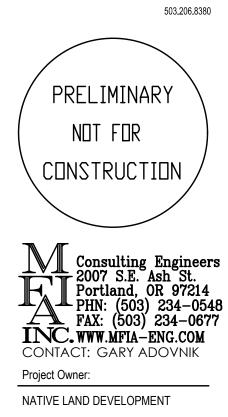
ABBREVIATIONS

ABOVE FINISHED FLOOR APPROXIMATE CONDUIT CONDUIT ONLY CABLE TELEVISION CLOSED CIRCUIT TELEVISION CEILING MOUNTED EXISTING FIRE ALARM CONTROL PANEL FACEPLATE FLOW SWITCH (SEE FIRE ALARM SYMBOLS) FIRE/SMOKE DAMPER GROUND INFRARED JUNCTION BOX NOT IN CONTRACT OWNER FURNISHED, CONTRACTOR INSTALLED OWNER FURNISHED, OWNER INSTALLED PUBLIC ADDRESS PROTECTIVE ENTRANCE TERMINAL SMOKE DAMPER TAMPER SWITCH (SEE FIRE ALARM SYMBOLS) TELEPHONE TERMINAL BOARD TYPICAL UNDERGROUND UNLESS OTHERWISE NOTED WIRE GUARD WEATHERPROOF

EXPLOSION PROOF



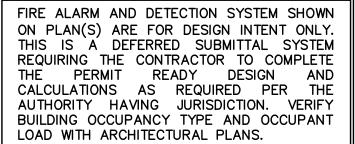



Project Name:

MINNESOTA PLACES

1208 N. JESSUP & 5627 N. MINNESOTA (R226159, R226160)


PERMIT SET

Issued: 7.29.2021 PERMIT SET

Job #: 2020 ORIGINAL SHEET SIZE: 24" x 36" HALF SIZE: 12" x 18"

TECHNOLOGY

SYMBOL LIST

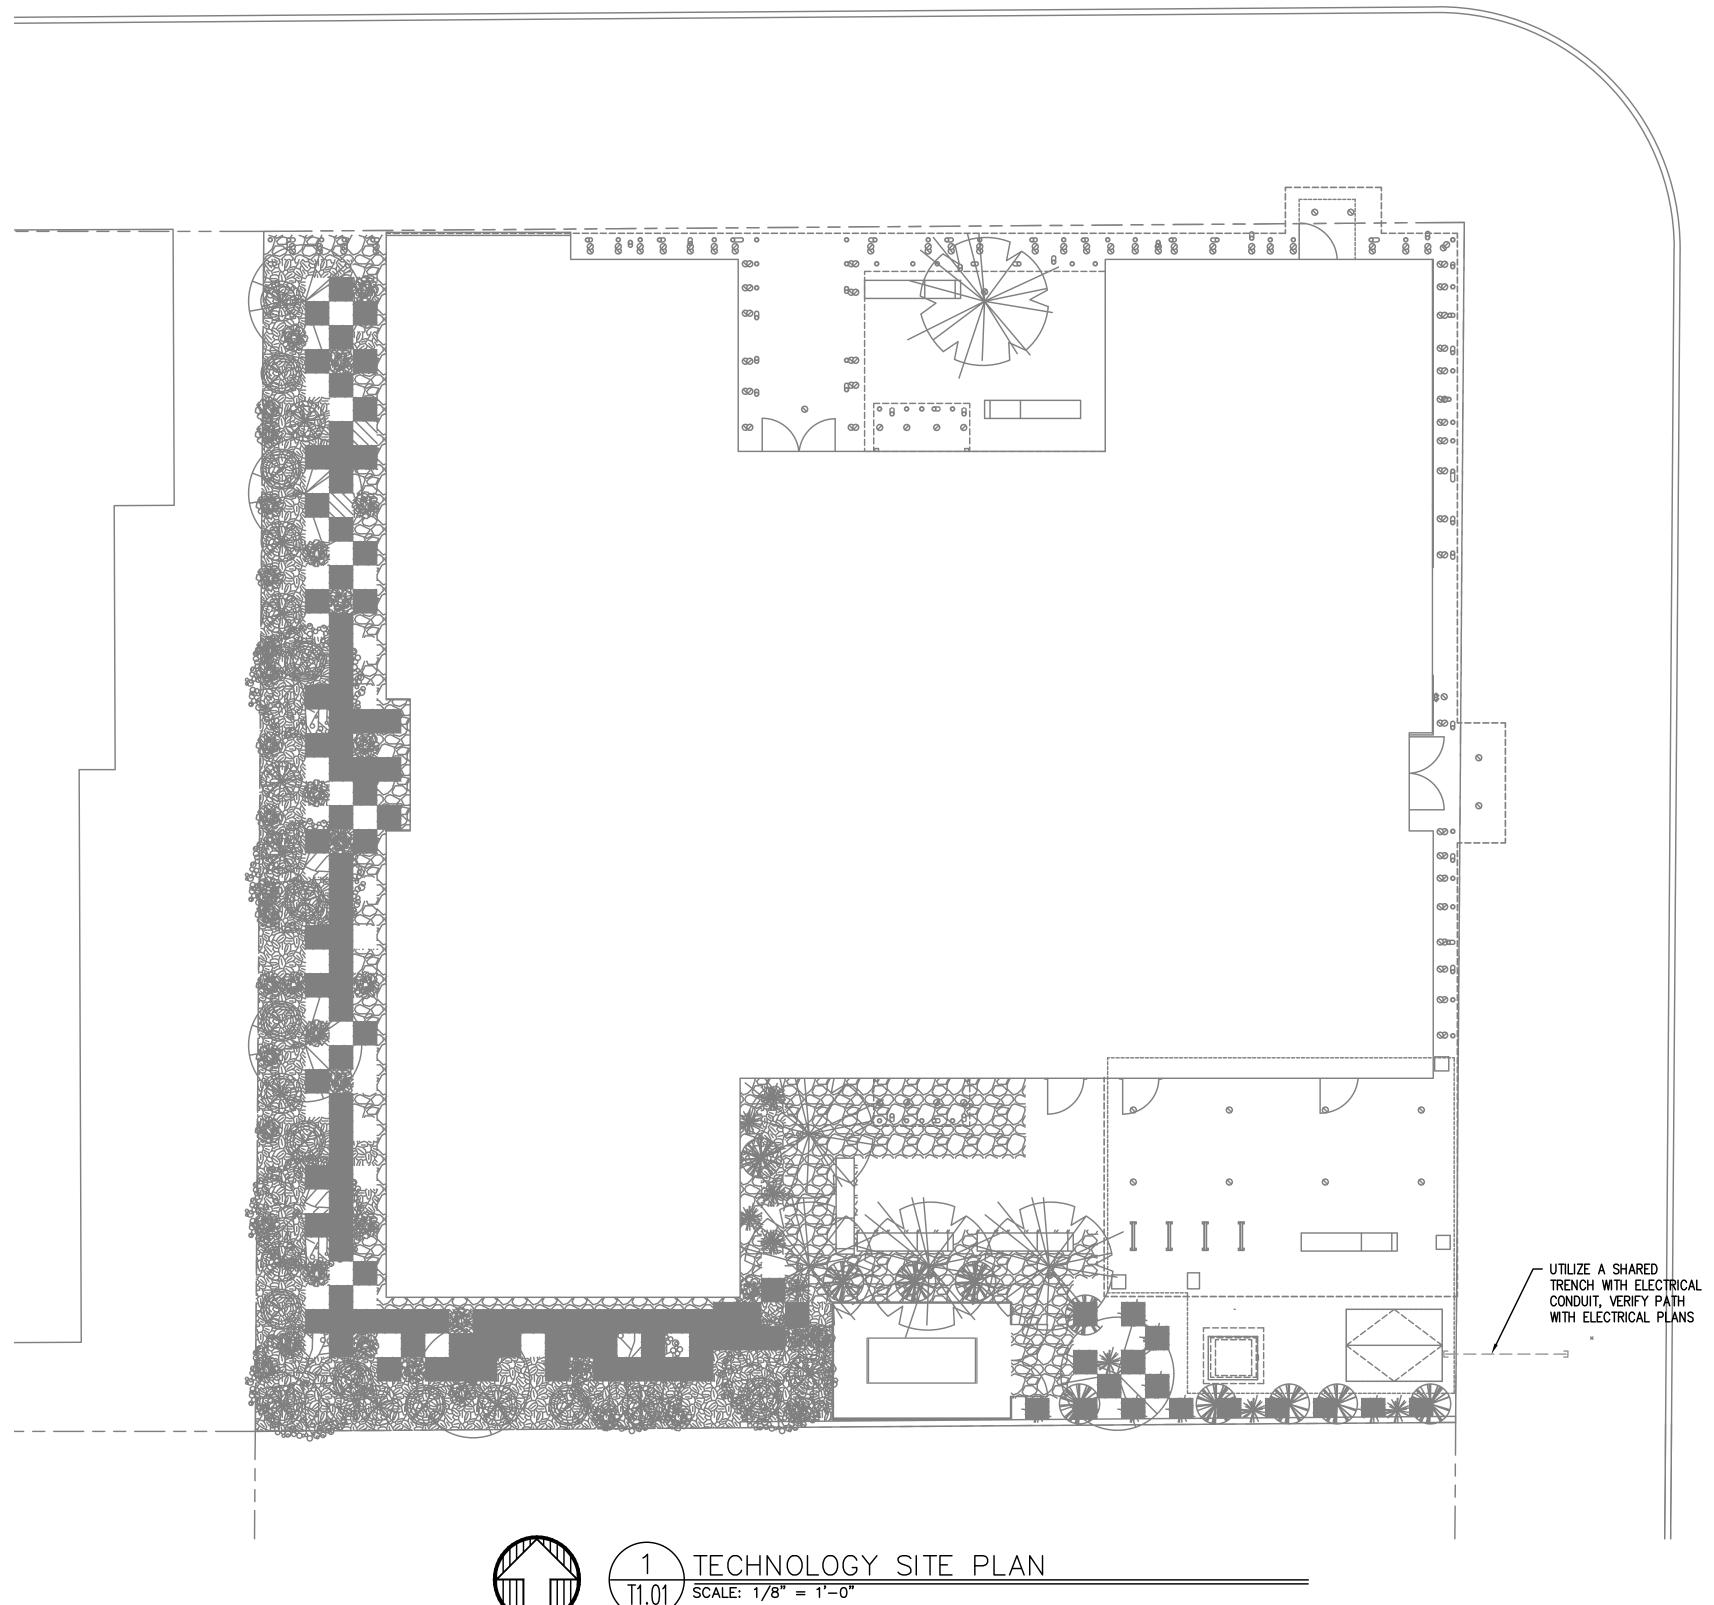

GENERAL NOTES:

- A. ALL WORK SHALL BE PERFORMED IN ACCORDANCE WITH ALL APPLICABLE LOCAL, STATE AND NATIONAL CODES.
- B. PLANS ARE DIAGRAMMATIC AND MAY OR MAY NOT REFLECT ACTUAL FIELD CONDITIONS.
- C. COORDINATE WITH UTILITY PROVIDER FOR EXACT CONDUIT COUNT AND SIZE REQUIREMENTS.
- D. CONTRACTOR SHALL REVIEW THE UTILITY PROVIDER'S SERVICE REQUIREMENTS PRIOR TO THE START OF ANY WORK.
- E. CONTRACTOR SHALL REVIEW ALL PROJECT DOCUMENTS AND SPECIFICATIONS IN DETAIL AND REFER TO THE DOCUMENTS THROUGHOUT THE CONSTRUCTION.
- F. POWER INFORMATION SHOWN FOR REFERENCE ONLY. REFER TO ELECTRICAL SHEETS FOR MOST ACCURATE INFORMATION.

UTILITY REQUIREMENTS

- 1. CUSTOMER TO PROVIDE ALL TRENCHING AND BACKFILLING. TRENCH TO BE 36 INCHES DEEP AND 30 INCHES WIDE, MEASURED FROM FINAL GRADE.
- 2. ALL UTILITY CONDUCTORS TO BE INSTALLED IN PVC CONDUIT WITH NYLON PULL STRINGS (MIN 500 LBS. TEST). UTILITIES TO DETERMINE THE SIZE AND NUMBER OF CONDUITS REQUIRED. ALL ELBOWS TO BE 36 INCH (MIN) RADIUS. ALL BENDS MAY BE FACTORY MADE.
- 3. CONTRACTOR TO LOCATE ALL UNDERGROUND UTILITIES BEFORE TRENCHING.





Project Owner: NATIVE LAND DEVELOPMENT

Project Name:

MINNESOTA PLACES

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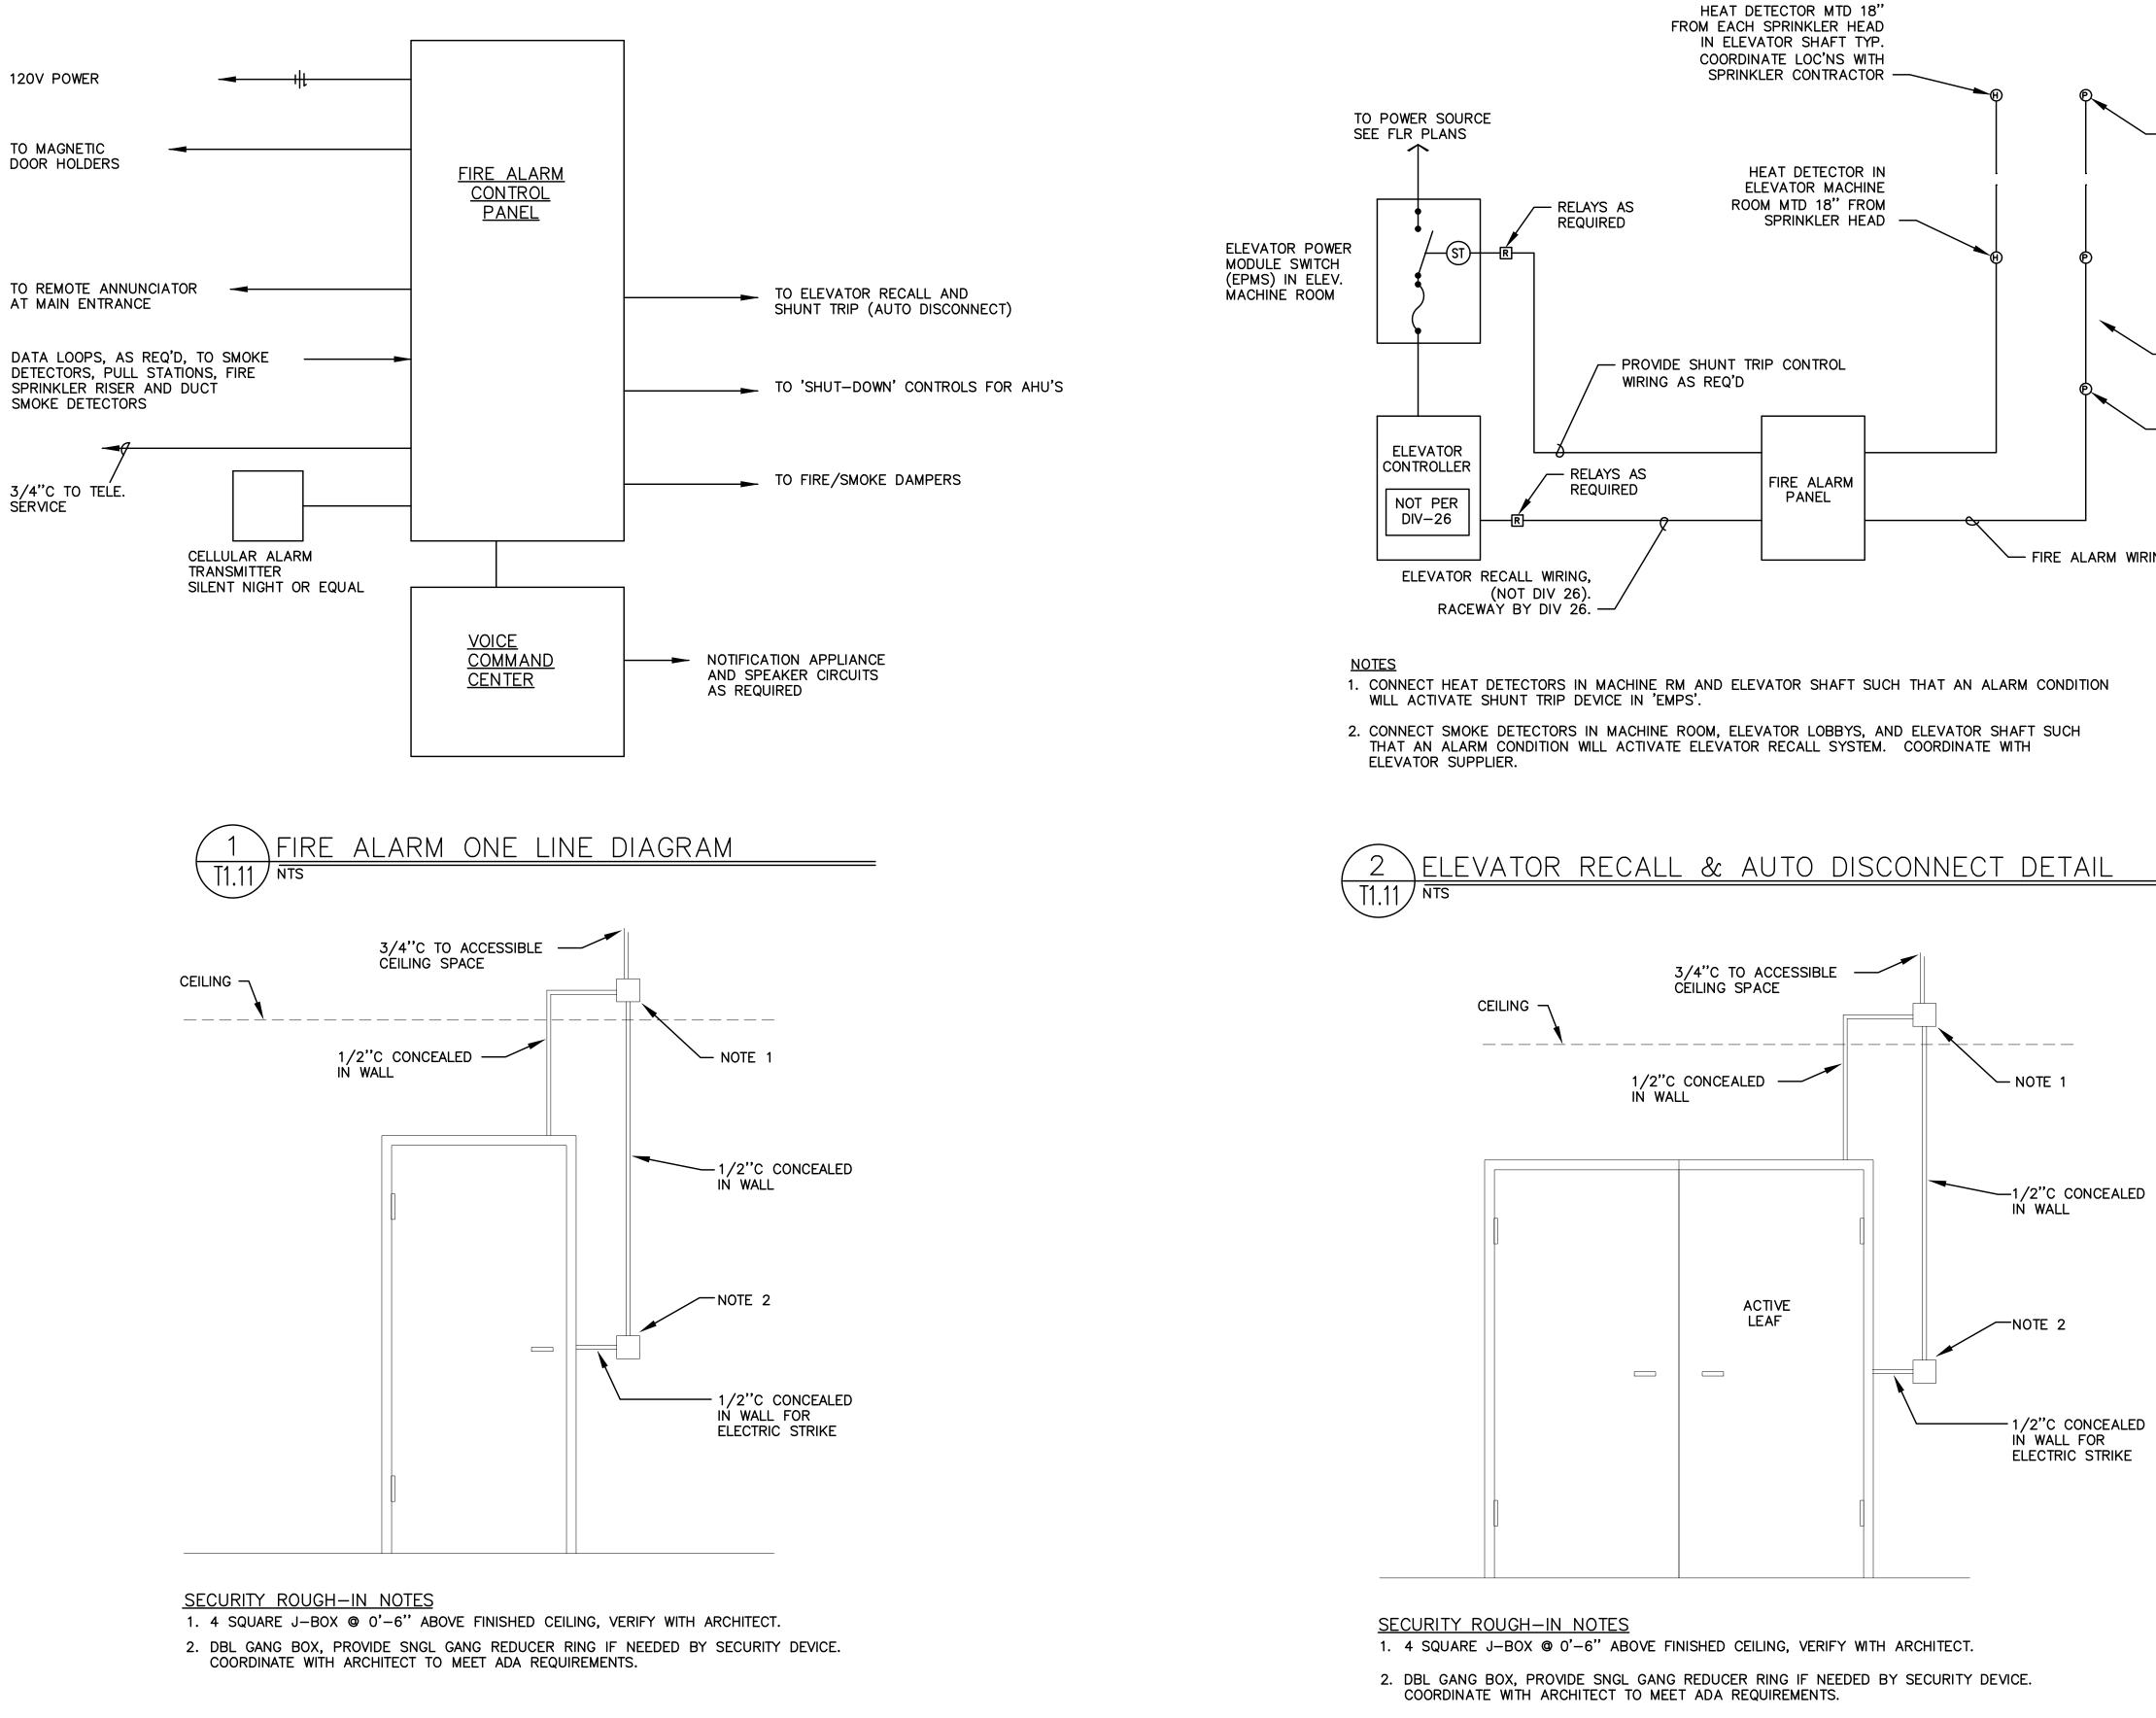
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TECHNOLOGY SITE PLAN

Drawing Number


T1.01





ACCESS CONTROL ROUGH-IN 4 T1.11/ NTS

- SMOKE DETECTOR AT TOP OF ELEV. SHAFT - SMOKE DETECTOR IN ELEV. LOBBY (TYP EACH FLR) - SMOKE DETECTOR IN ELEV. MACHINE ROOM FIRE ALARM WIRING

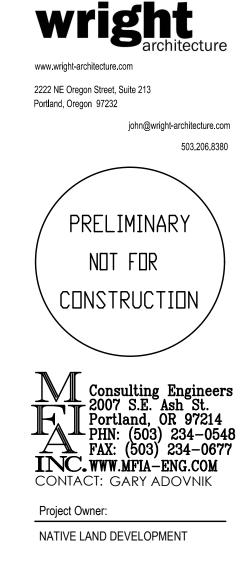

Project Name: MINNESOTA PLACES

1208 N. JESSUP & 5627 N. MINNESOTA (R226159, R226160)

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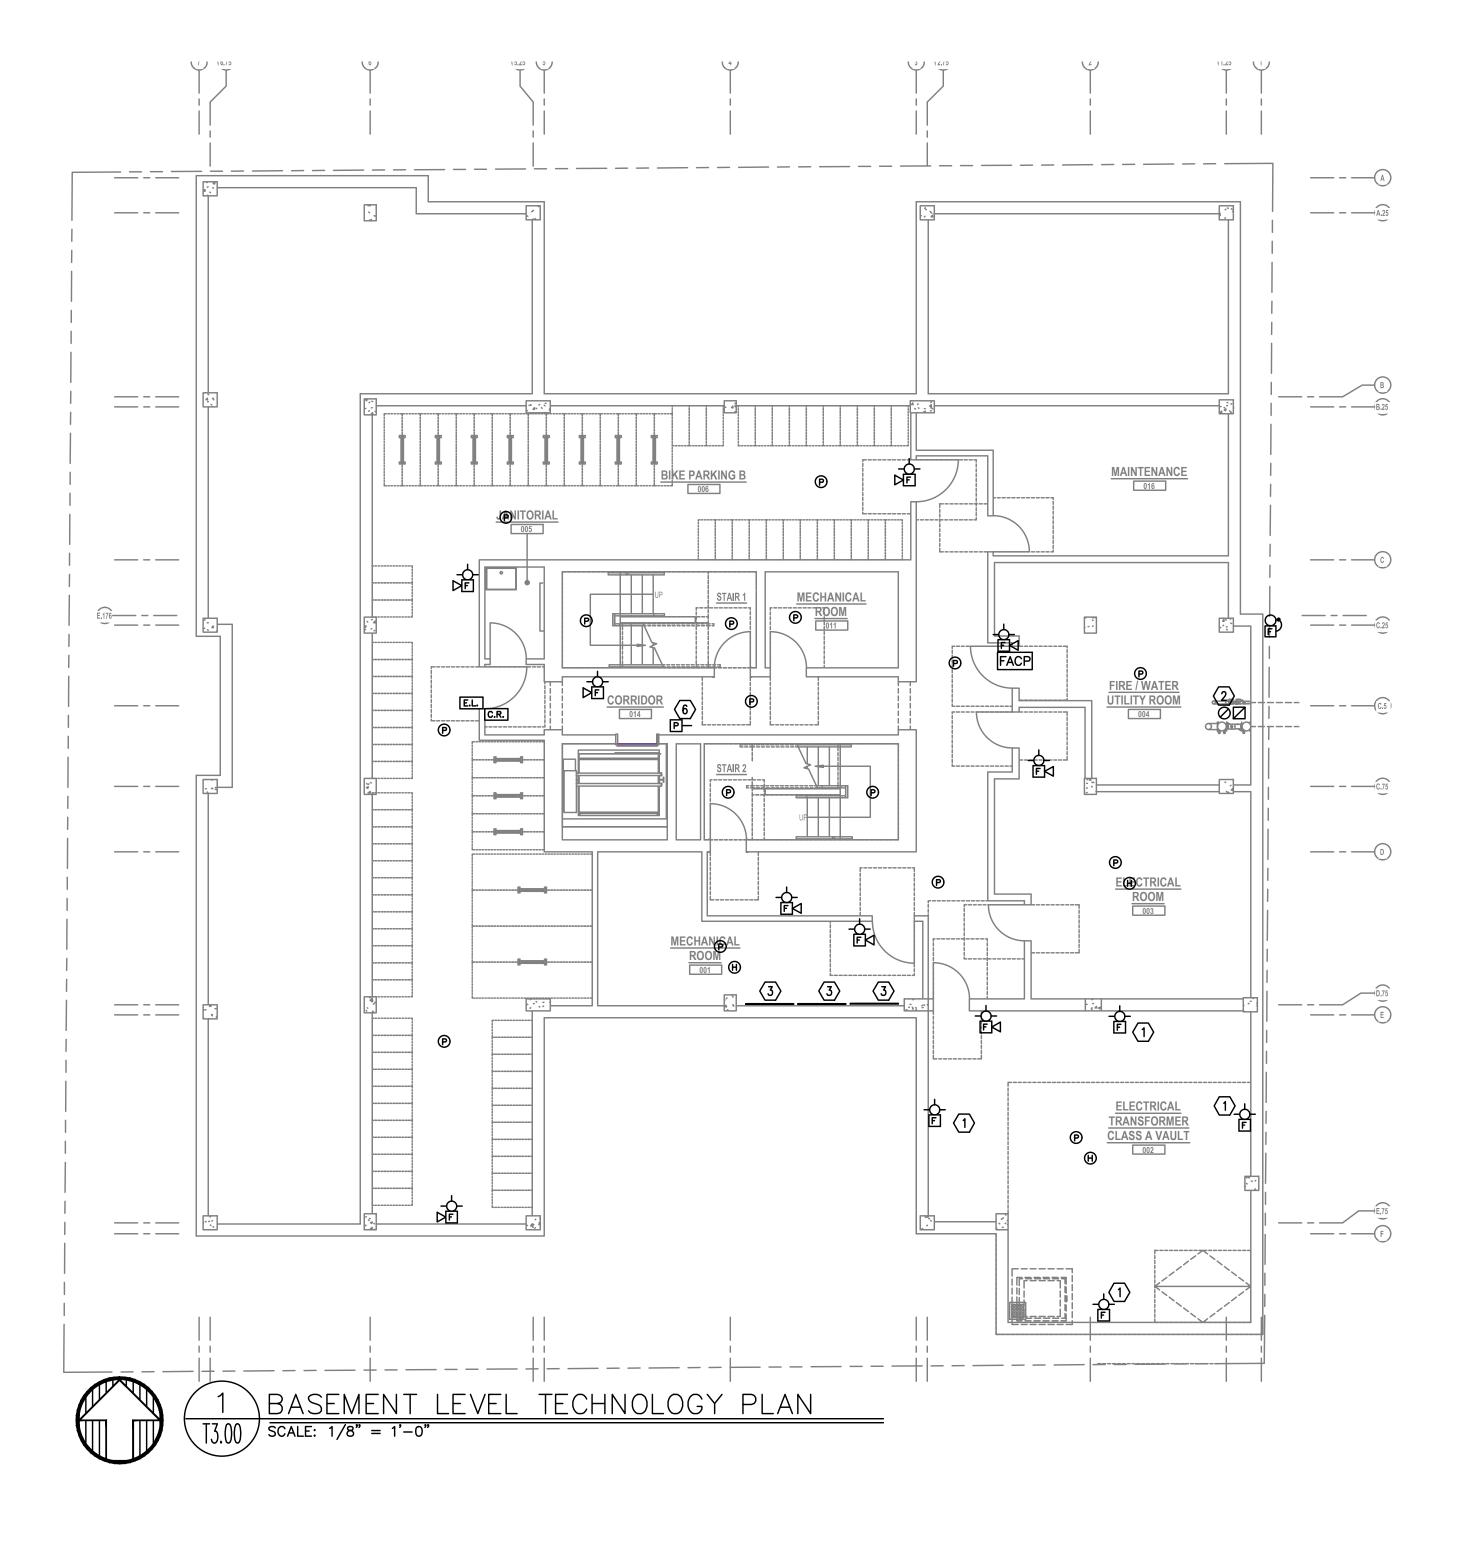
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TECHNOLOGY

ONE-LINE

DIAGRAM

T1.11



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GENERAL NOTES:

- Α.
- ALARM SYSTEM.
- ELECTRICAL.
- APARTMENT UNIT TYPES.

_AN NOTES: ΡI

- UTILITY REQUEST.
- UTILITY.
- DEMARCATION WITHIN UNIT.
- COMBINED UNIT.

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B. THE TECHNOLOGY CONTRACTOR SHALL REFER TO THE ARCHITECTURAL DRAWINGS FOR ALL MOUNTING HEIGHTS AND FINISHES OF DEVICES AND FIXTURES.

C. COORDINATE WITH MECHANICAL PLANS FOR LOCATIONS OF SMOKE, FIRE/SMOKE DAMPERS, AND ROOF TOP UNITS REQUIRING CONNECTION TO FIRE

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F. REFER TO ENLARGED TYPICAL UNIT PLANS (IF PROVIDED) FOR TYPICAL LAYOUTS FOR ALL

1. STROBES TO BE PLACED AT 24" AT ELECTRICAL

2. VERY COUNT AND LOCATION FOR FLOW AND TAMPER SWITCHES WITH FIRE SPRINKLER PLANS.

3. 4x8 FIRE RATED BACKBOARDS FOR CATV AND PHONE

4. 42" 'RF' TRANSPARENT SMART PANEL FOR UTILITY

5. SMOKE AND CO DETECTORS CAN BE A SINGLE

6. VERIFY EXACT LOCATION AND COUNT OF DUCT DETECTORS WITH MECHANICAL PLANS.





NATIVE LAND DEVELOPMENT

Project Name:

MINNESOTA PLACES


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PLAN Drawing Number





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FIRST FLOOR TECHNOLOGY PLAN $\sqrt{\text{SCALE: } 1/8"} = 1'-0"$

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wright www.wright-architecture.com
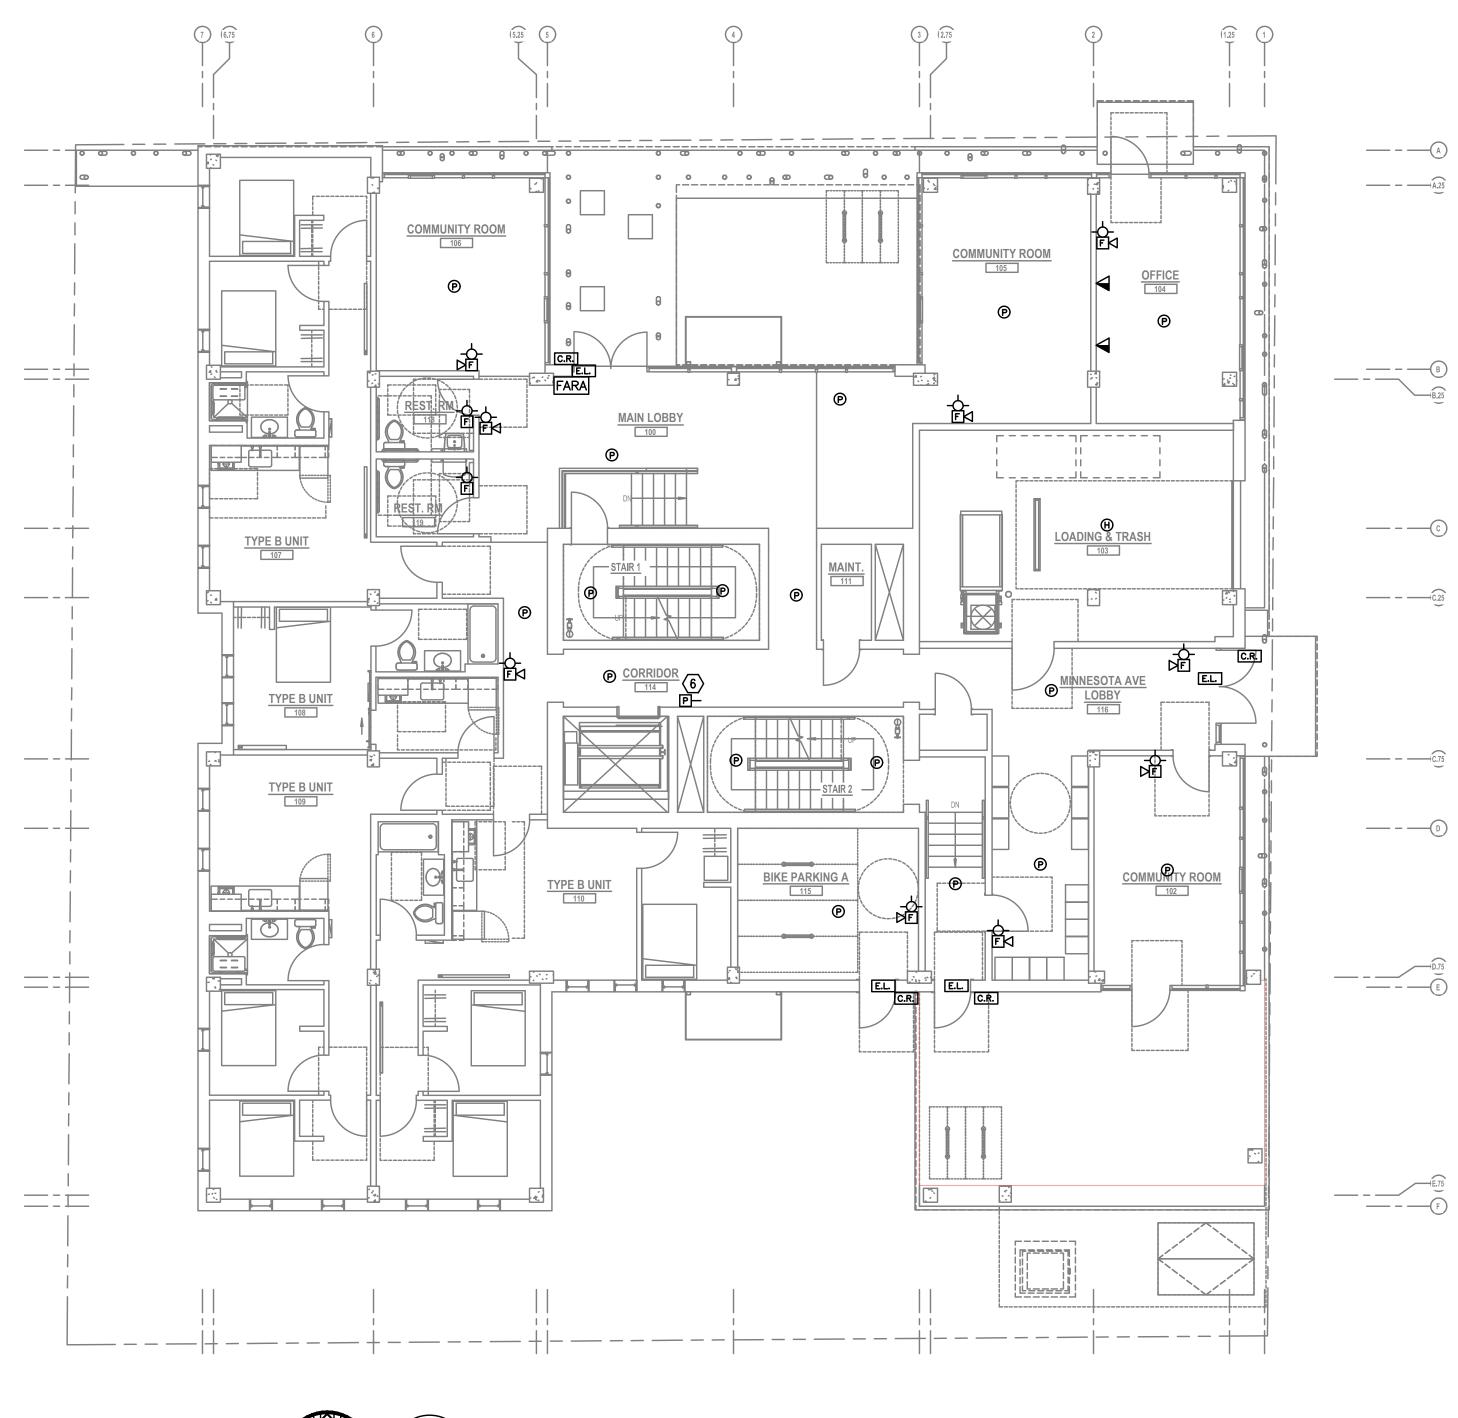
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Project Name:

MINNESOTA PLACES

1208 N. JESSUP & 5627 N. MINNESOTA (R226159, R226160)


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T3.01



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Ρ	LAN	NC)	ES:
1.	STROBES	S TO	ΒE	PLACE

- UTILITY REQUEST.
- UTILITY.
- DEMARCATION WITHIN UNIT.
- 5. SMOKE AND CO DETECTORS CAN BE A SINGLE COMBINED UNIT.
- 6. VERIFY EXACT LOCATION AND COUNT OF DUCT DETECTORS WITH MECHANICAL PLANS.

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4. 42" 'RF' TRANSPARENT SMART PANEL FOR UTILITY
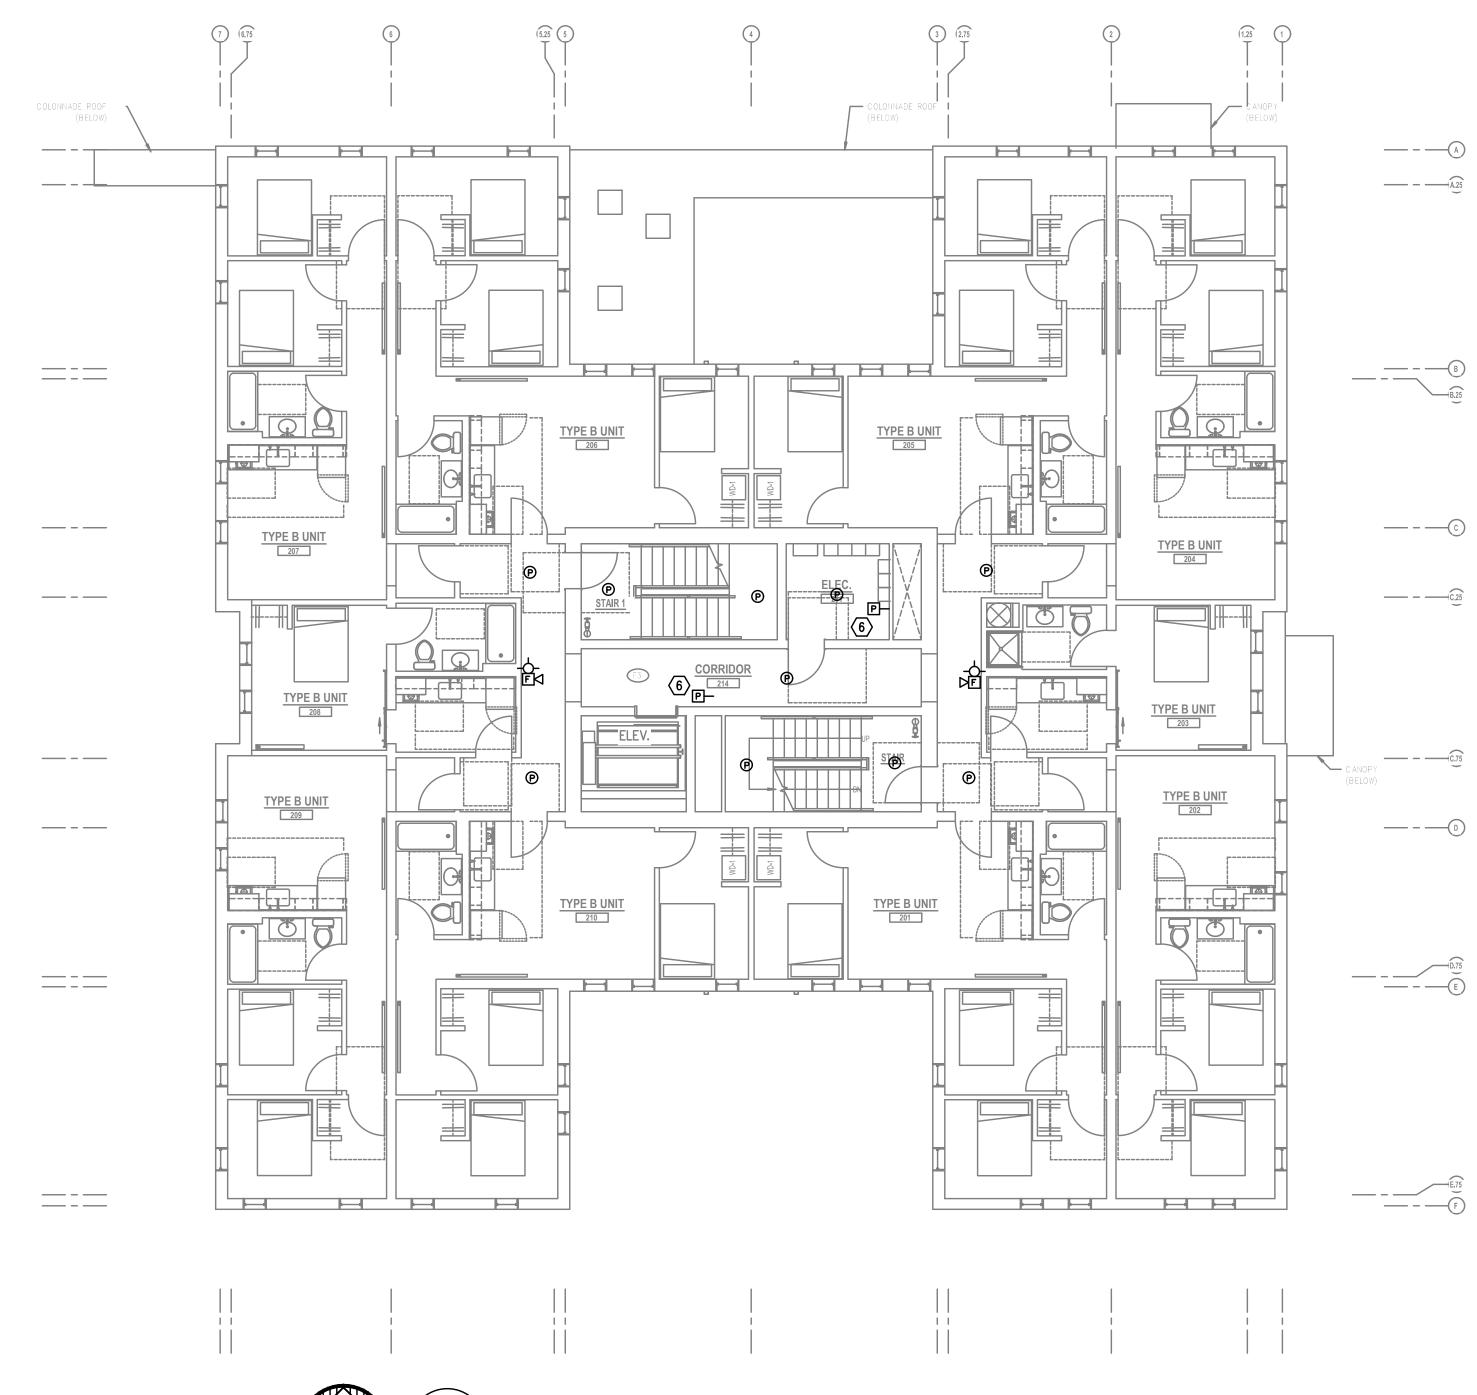
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SECOND FLOOR TECHNOLOGY PLAN

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LOAD WITH ARCHITECTURAL PLANS.




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Project Name:

MINNESOTA PLACES

1208 N. JESSUP & 5627 N. MINNESOTA (R226159, R226160)



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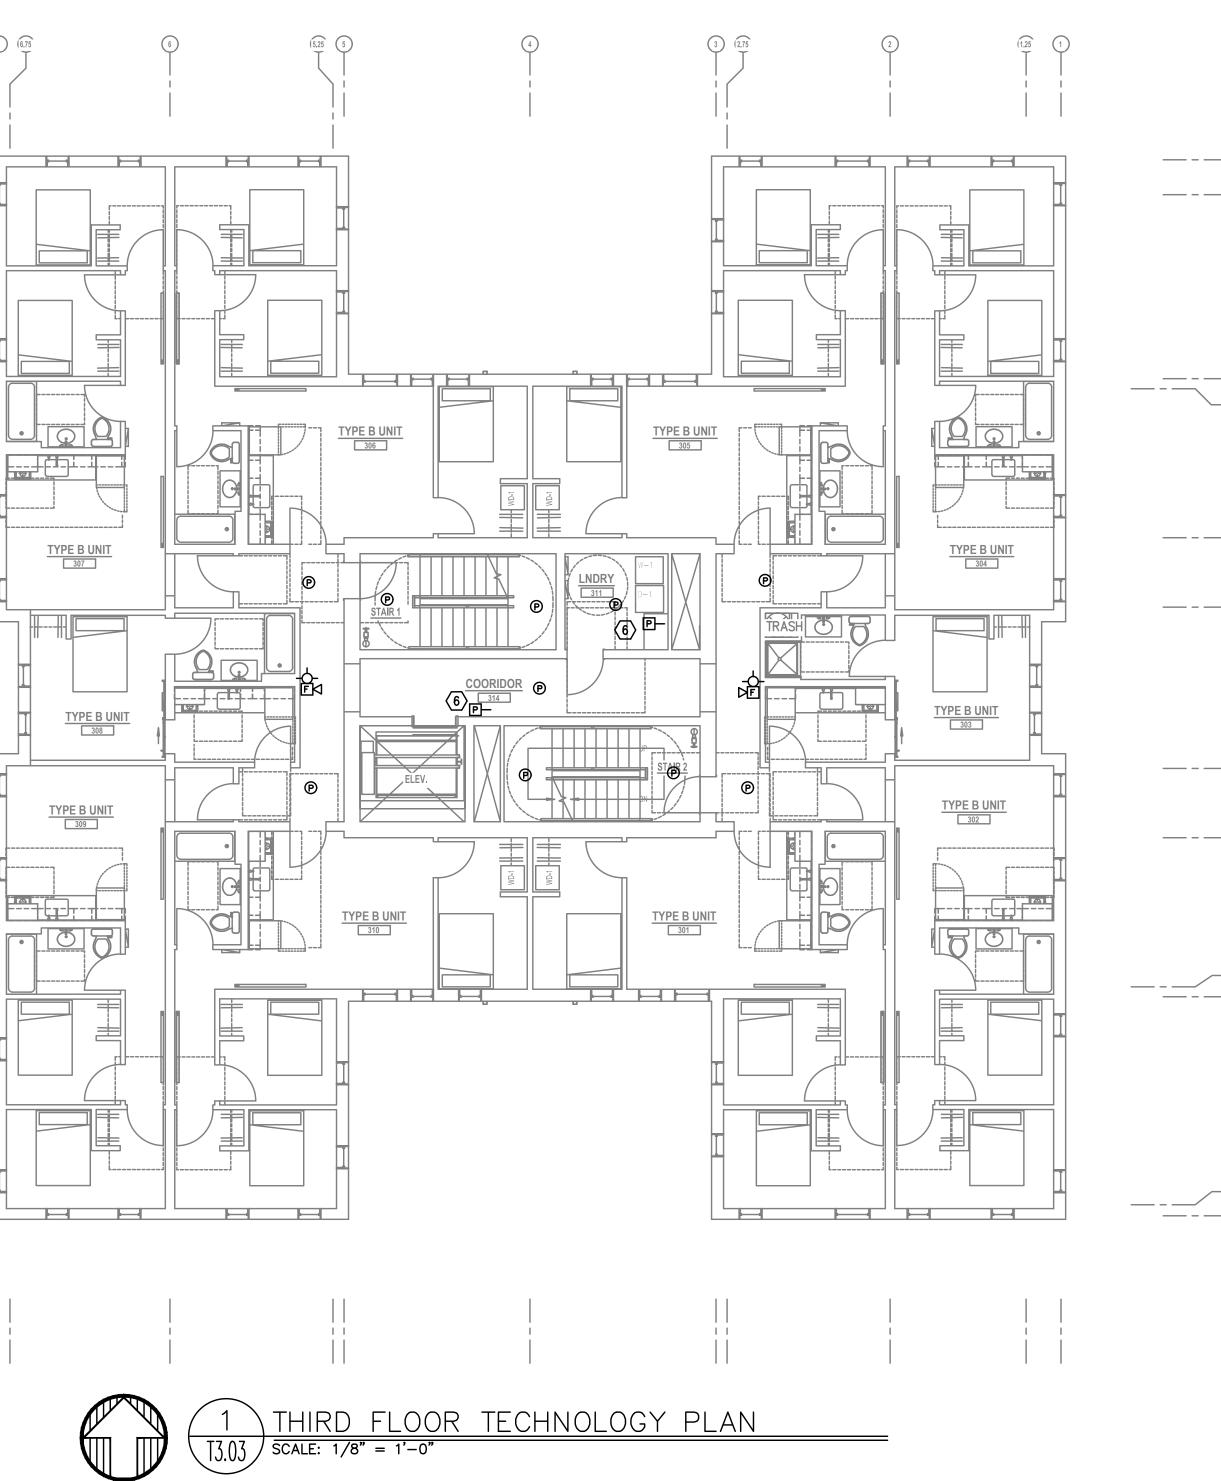
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NATIVE LAND DEVELOPMENT
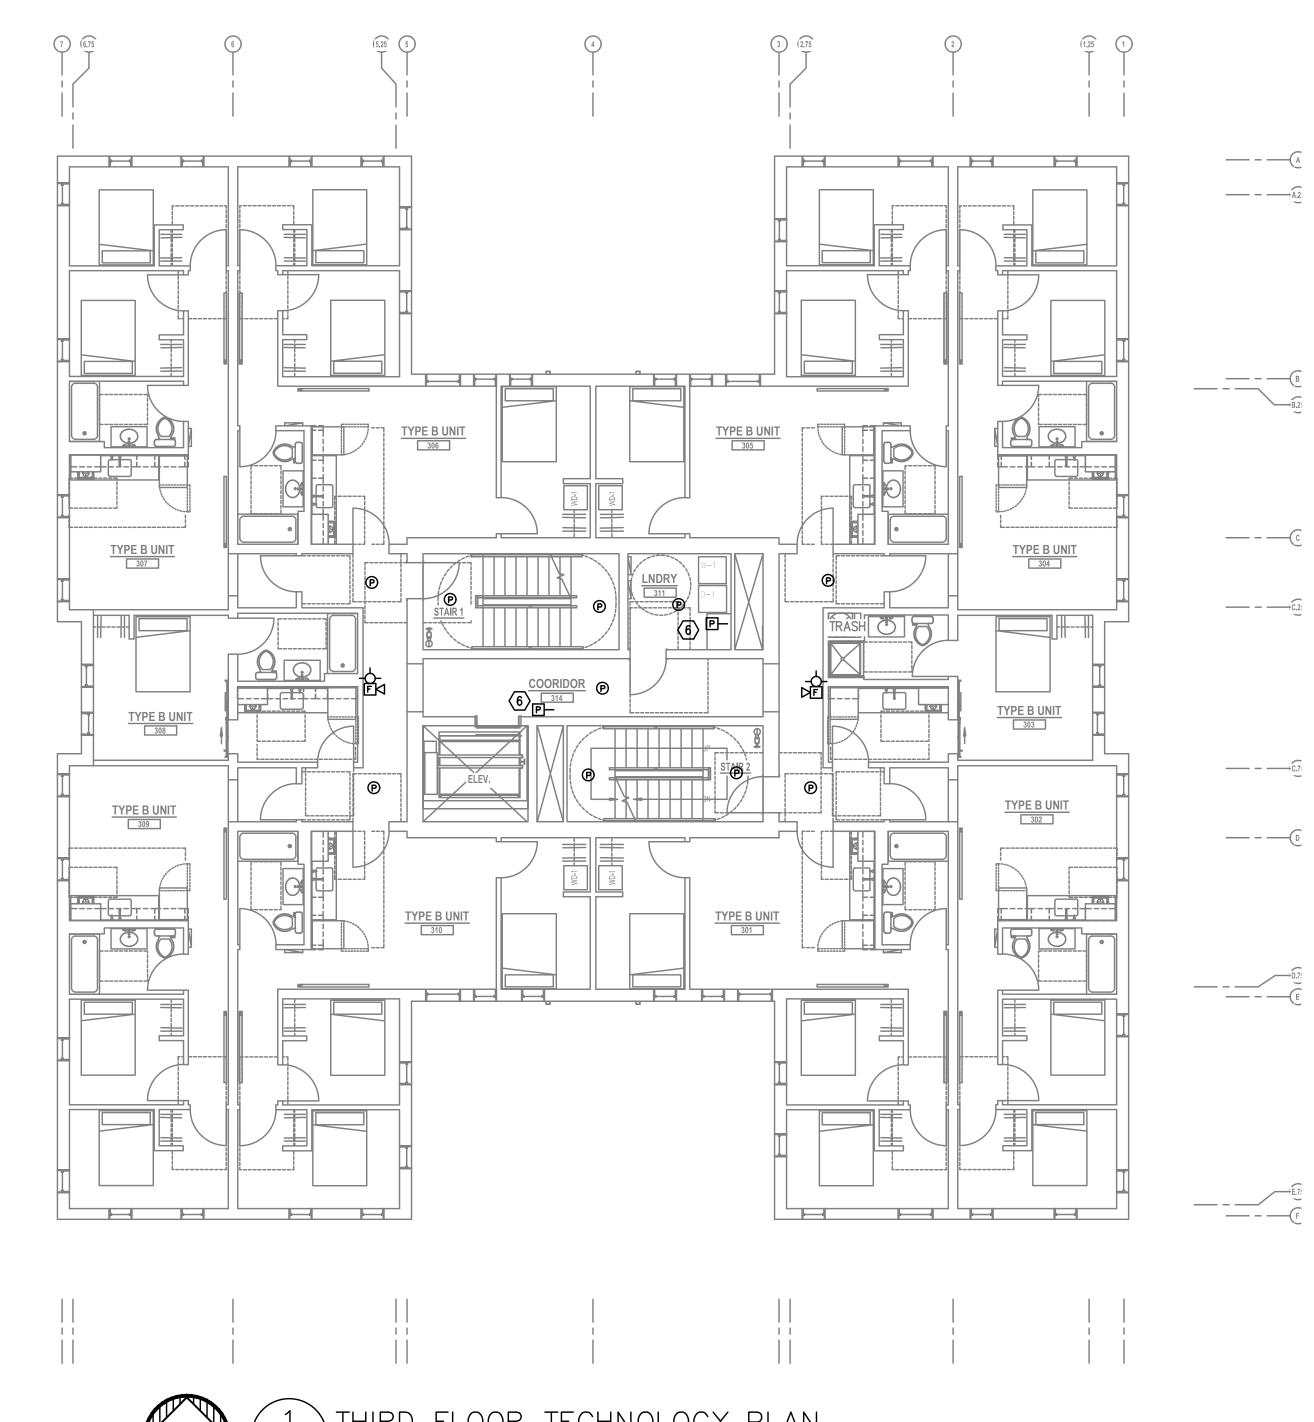
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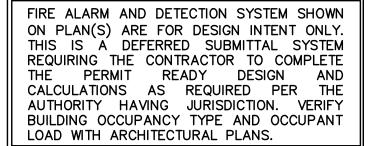
MINNESOTA PLACES

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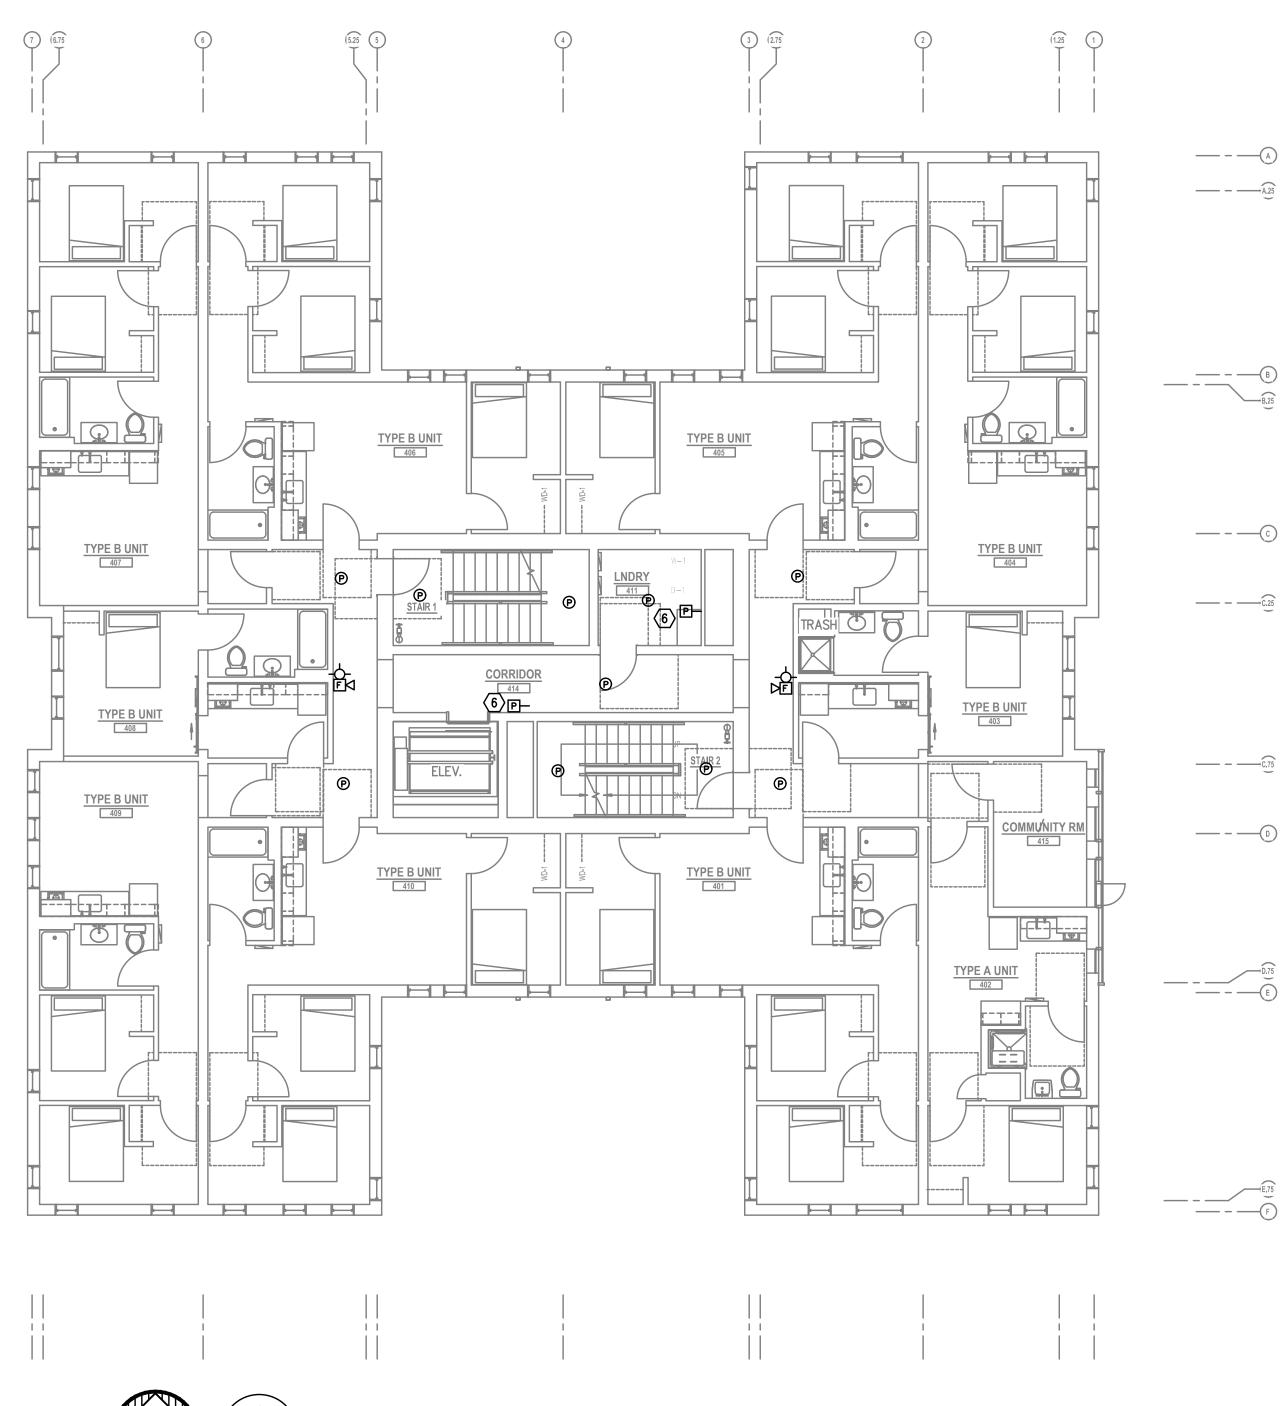
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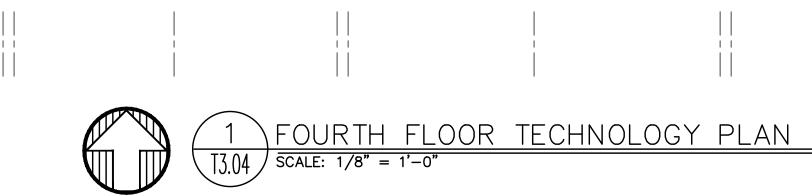
THIRD FLOOR TECHNOLOGY PLAN



Drawing Number

T3.03





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NATIVE LAND DEVELOPMENT

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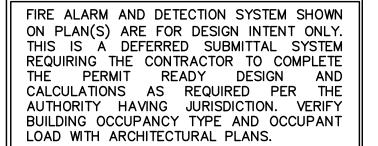
MINNESOTA PLACES


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FOURTH FLOOR TECHNOLOGY PLAN





 $\overline{\text{SCALE: } 1/8" = 1'-0"}$

T3.05

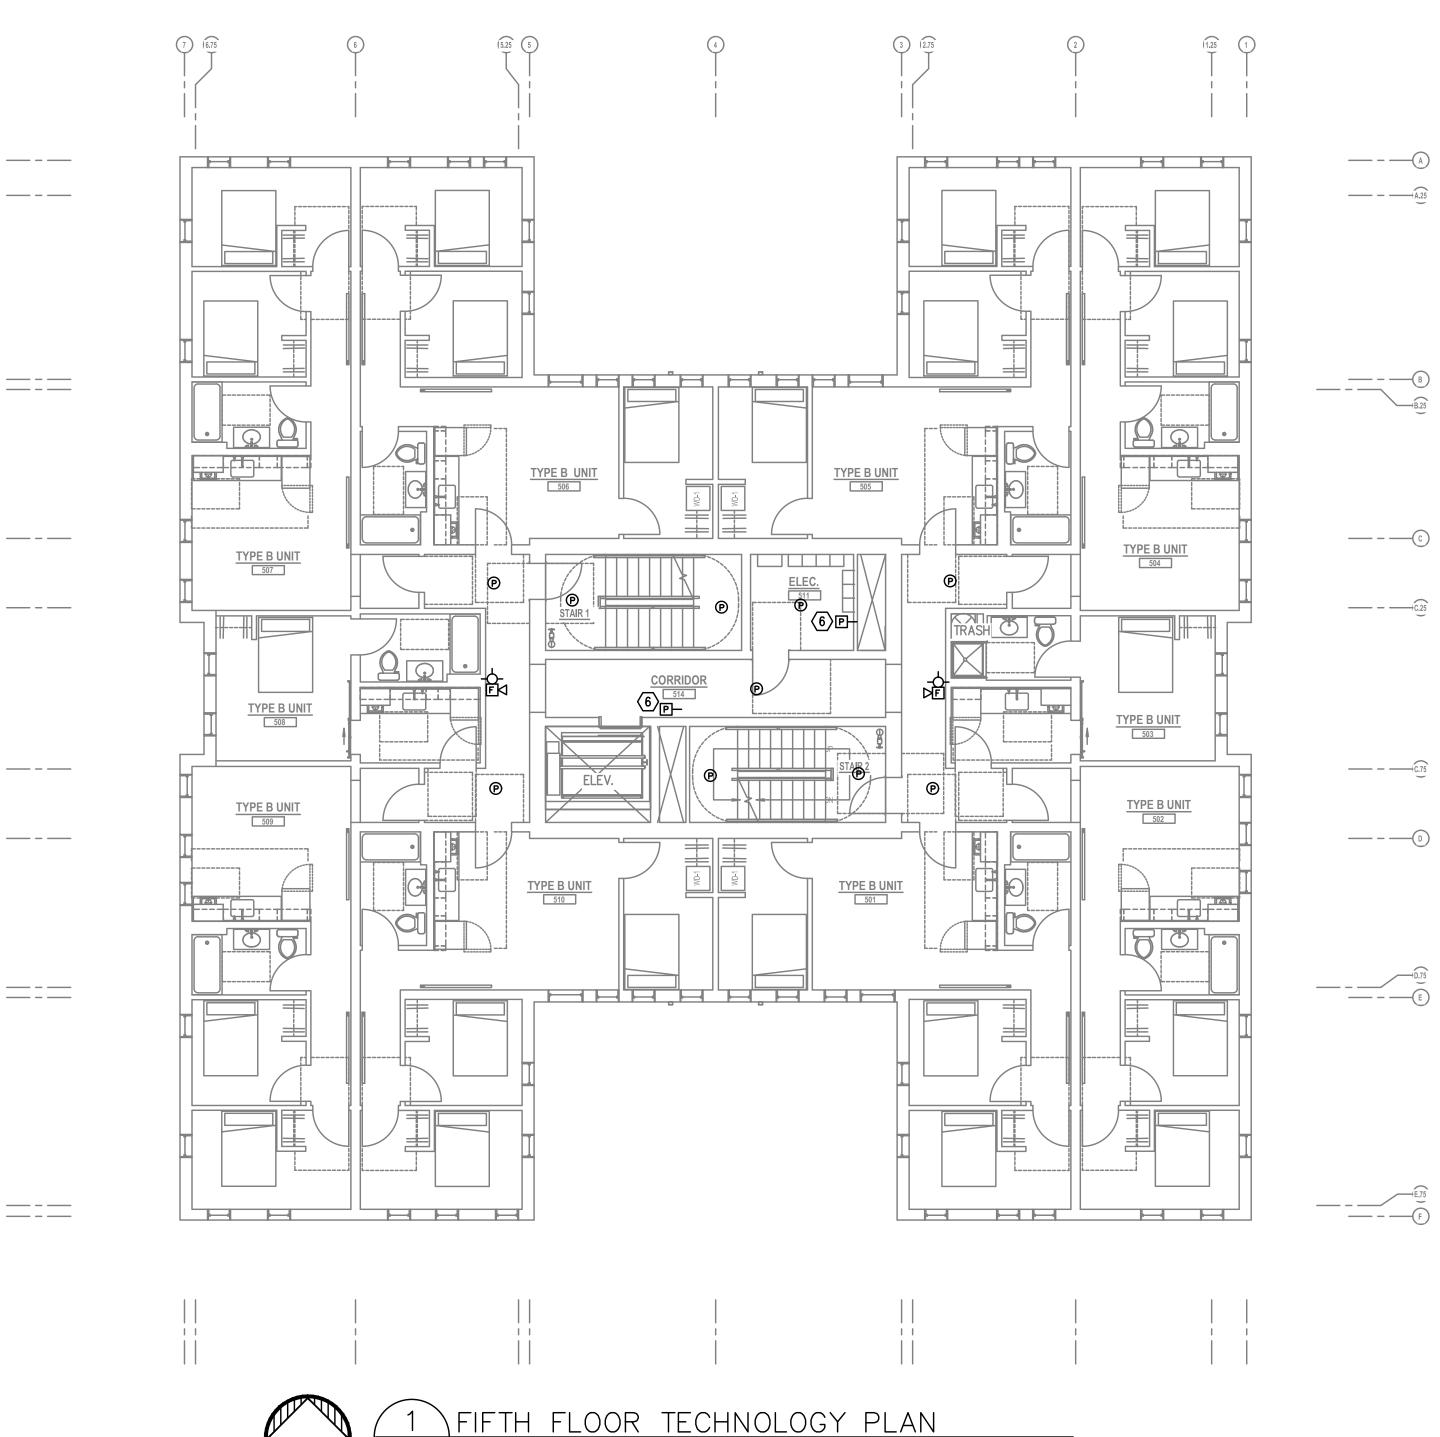L_____

- ____
- ____

- ____
- ____ ____

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- C. COORDINATE WITH MECHANICAL PLANS FOR ALARM SYSTEM.
- THREAD ON PLASTIC BUSHING FOR CABLE THAN 18" SEPARATION. COORDINATE WITH ELECTRICAL.
- Ε. DEVICES WILL NOT BE OBSTRUCTED.
- F. REFER TO ENLARGED TYPICAL UNIT PLANS (IF PROVIDED) FOR TYPICAL LAYOUTS FOR ALL APARTMENT UNIT TYPES.

PLAN NOTES: 1. STROBES TO BE PLACED AT 24" AT ELECTRICAL UTILITY REQUEST.

- SWITCHES WITH FIRE SPRINKLER PLANS.
- UTILITY.
- DEMARCATION WITHIN UNIT.
- 5. SMOKE AND CO DETECTORS CAN BE A SINGLE COMBINED UNIT.
- 6. VERIFY EXACT LOCATION AND COUNT OF DUCT DETECTORS WITH MECHANICAL PLANS.

A. TECHNOLOGY DRAWINGS ARE DIAGRAMMATICAL AND CONSTRUCTION CONDITIONS. THE TECHNOLOGY TECHNOLOGY EQUIPMENT, WITH ALL TRADES PRIOR

B. THE TECHNOLOGY CONTRACTOR SHALL REFER TO THE ARCHITECTURAL DRAWINGS FOR ALL MOUNTING HEIGHTS AND FINISHES OF DEVICES AND FIXTURES.

LOCATIONS OF SMOKE, FIRE/SMOKE DAMPERS, AND ROOF TOP UNITS REQUIRING CONNECTION TO FIRE

D. FOR VOICE/DATA OUTLETS PROVIDE A SINGLE GANG MUD-RING WITH A 1" CONDUIT FROM THE TOP OF THE MUD-RING TO ACCESSIBLE CEILING SPACE. TERMINATE CONDUIT WITH END CONNECTORS AND PROTECTION. OUTLET SHALL BE AT THE SAME HEIGHT AS ADJACENT POWER OUTLET AND LESS

COORDINATE ALL DEVICE LOCATIONS WITH LATEST ARCHITECTURAL INTERIOR ELEVATIONS TO VERIFY

2. VERY COUNT AND LOCATION FOR FLOW AND TAMPER

3. 4x8 FIRE RATED BACKBOARDS FOR CATV AND PHONE

4. 42" 'RF' TRANSPARENT SMART PANEL FOR UTILITY



2222 NE Oregon Street, Suite 213 Portland, Oregon 97232



NATIVE LAND DEVELOPMENT

Project Name:


MINNESOTA PLACES

1208 N. JESSUP & 5627 N. MINNESOTA (R226159, R226160)


PERMIT SET

Issued:	
PERMIT SET	7.29.2021
Job #:	2020
ORIGINAL SHEET SIZE: HALF SIZE: 12" x 18"	24" x 36"

FIFTH FLOOR TECHNOLOGY PLAN

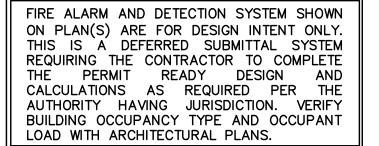



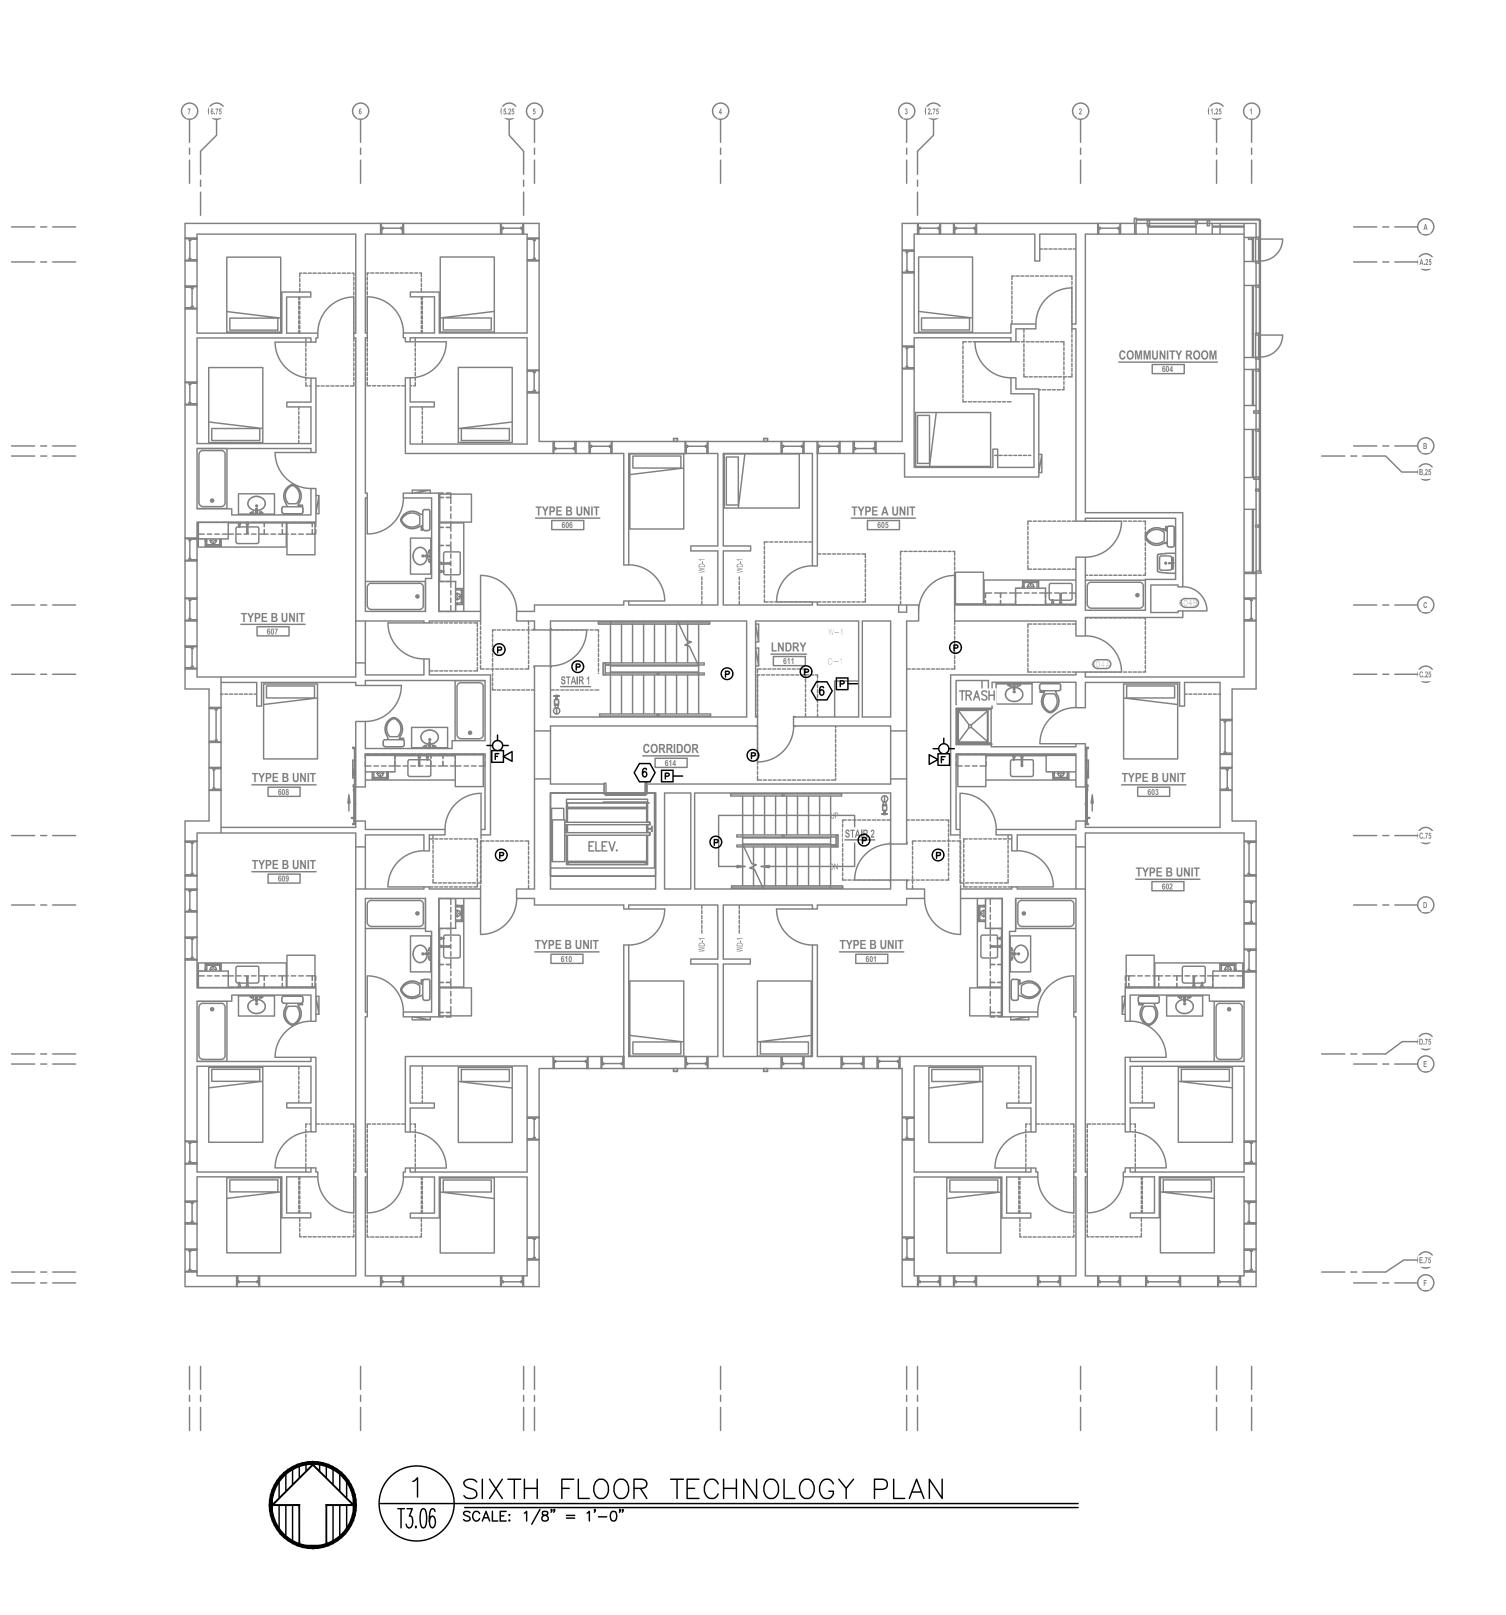

L_____

GENERAL NOTES:

- MAY NOT ACCURATELY REFLECT ACTUAL CONTRACTOR SHALL BE RESPONSIBLE FOR COORDINATING THE INSTALLATION OF ALL TO AND DURING CONSTRUCTION.
- C. COORDINATE WITH MECHANICAL PLANS FOR ALARM SYSTEM.
- THREAD ON PLASTIC BUSHING FOR CABLE THAN 18" SEPARATION. COORDINATE WITH ELECTRICAL.
- Ε. DEVICES WILL NOT BE OBSTRUCTED.
- F. REFER TO ENLARGED TYPICAL UNIT PLANS (IF PROVIDED) FOR TYPICAL LAYOUTS FOR ALL APARTMENT UNIT TYPES.

PLAN NOTES: 1. STROBES TO BE PLACED AT 24" AT ELECTRICAL UTILITY REQUEST.

- SWITCHES WITH FIRE SPRINKLER PLANS.
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COORDINATE ALL DEVICE LOCATIONS WITH LATEST ARCHITECTURAL INTERIOR ELEVATIONS TO VERIFY


2. VERY COUNT AND LOCATION FOR FLOW AND TAMPER

3. 4x8 FIRE RATED BACKBOARDS FOR CATV AND PHONE

4. 42" 'RF' TRANSPARENT SMART PANEL FOR UTILITY



2222 NE Oregon Street, Suite 213 Portland, Oregon 97232

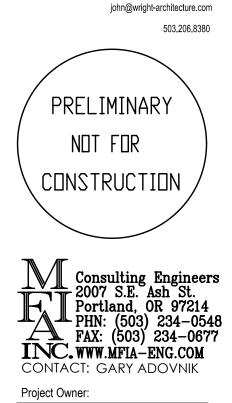

NATIVE LAND DEVELOPMENT

Project Name:


MINNESOTA PLACES

1208 N. JESSUP & 5627 N. MINNESOTA (R226159, R226160)


PERMIT SET

Issued:	
PERMIT SET	7.29.202
Job #:	2020
ORIGINAL SHEET SIZE: HALF SIZE: 12" x 18"	24" x 36"



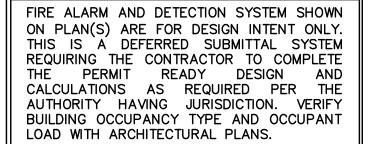



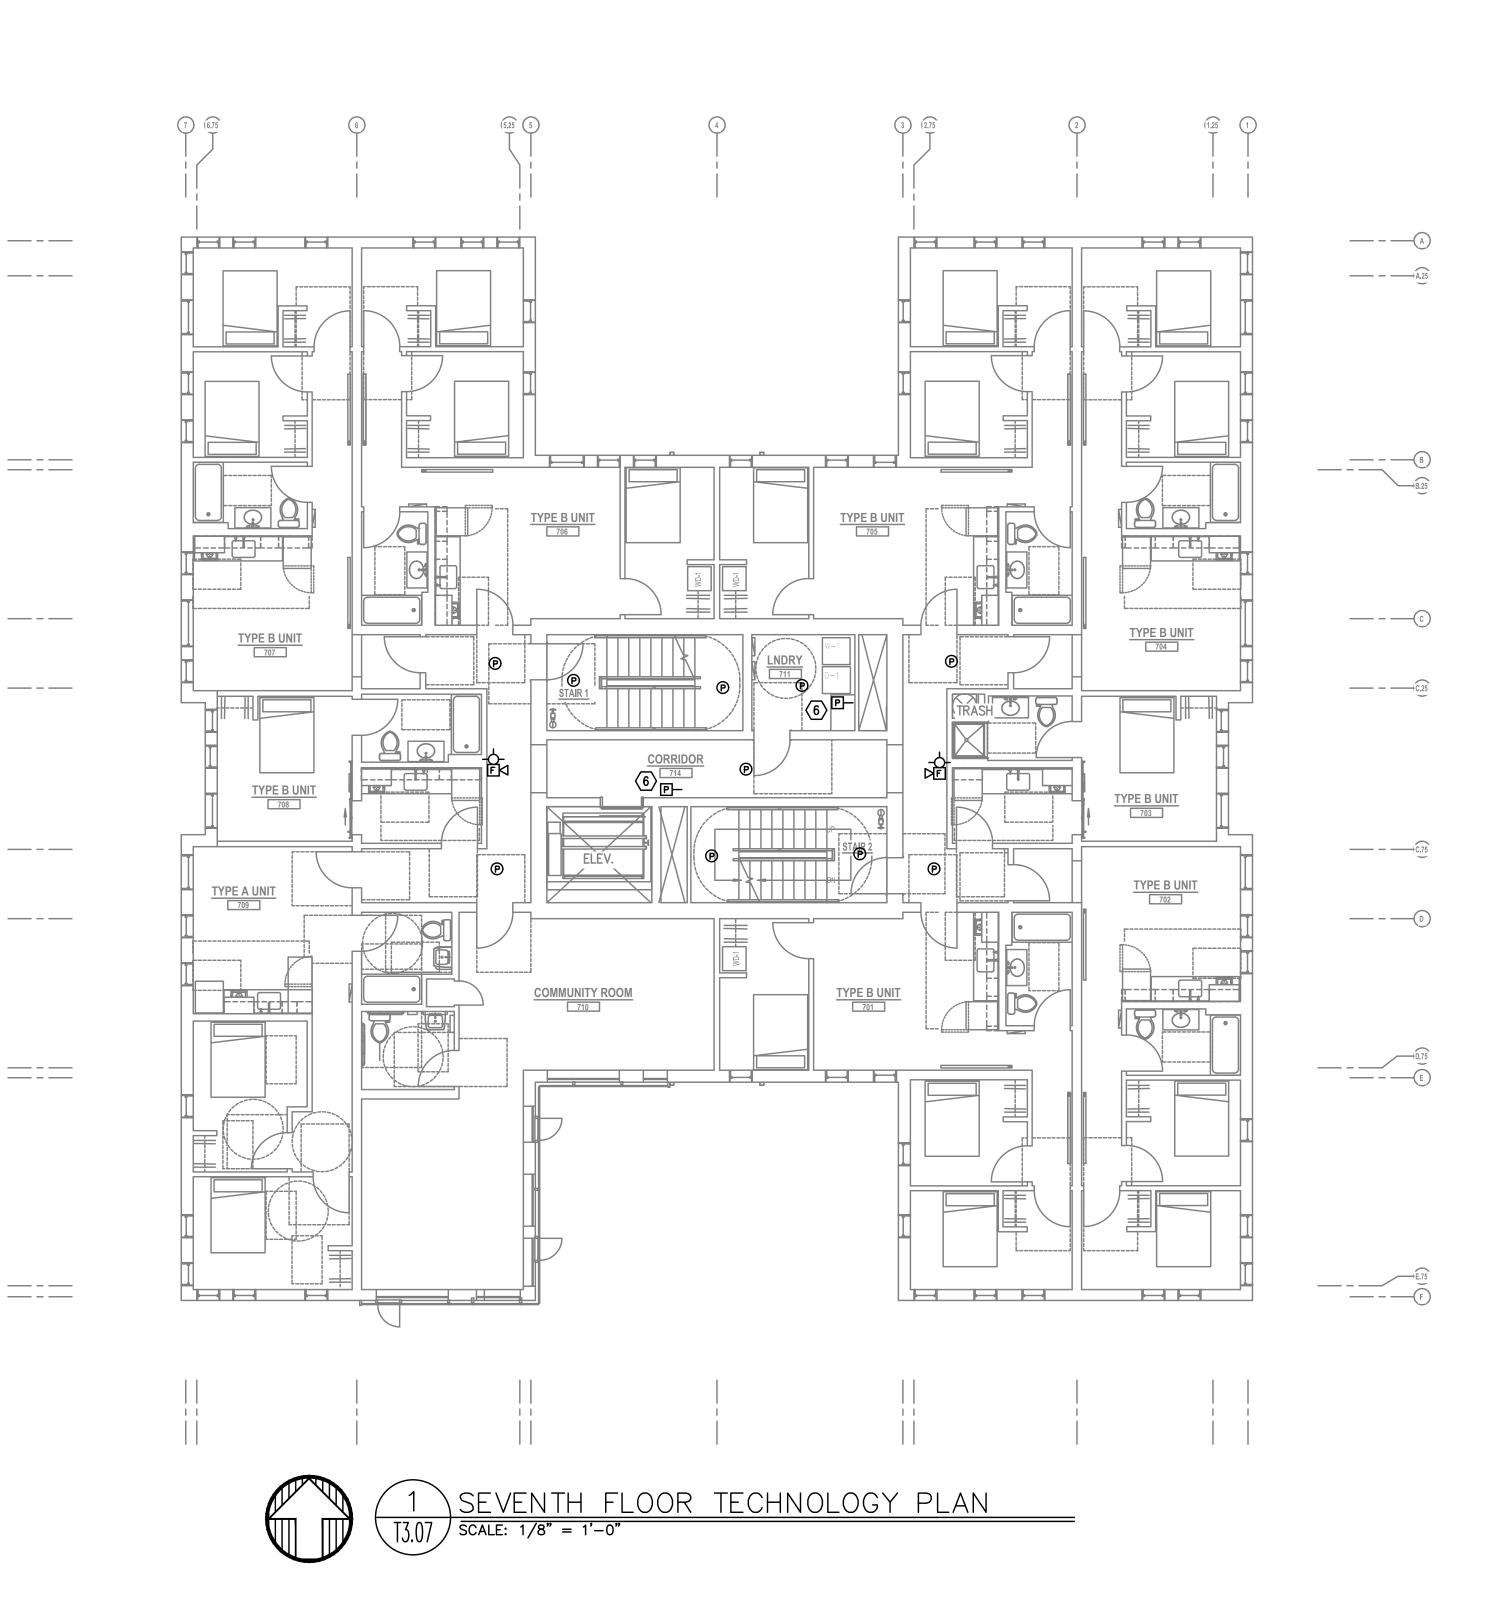

L_____

GENERAL NOTES:

- MAY NOT ACCURATELY REFLECT ACTUAL CONTRACTOR SHALL BE RESPONSIBLE FOR COORDINATING THE INSTALLATION OF ALL TO AND DURING CONSTRUCTION.
- C. COORDINATE WITH MECHANICAL PLANS FOR ALARM SYSTEM.
- THREAD ON PLASTIC BUSHING FOR CABLE THAN 18" SEPARATION. COORDINATE WITH ELECTRICAL.
- Ε. DEVICES WILL NOT BE OBSTRUCTED.
- F. REFER TO ENLARGED TYPICAL UNIT PLANS (IF PROVIDED) FOR TYPICAL LAYOUTS FOR ALL APARTMENT UNIT TYPES.

PLAN NOTES: 1. STROBES TO BE PLACED AT 24" AT ELECTRICAL UTILITY REQUEST.

- SWITCHES WITH FIRE SPRINKLER PLANS.
- UTILITY.
- DEMARCATION WITHIN UNIT.
- 5. SMOKE AND CO DETECTORS CAN BE A SINGLE COMBINED UNIT.
- 6. VERIFY EXACT LOCATION AND COUNT OF DUCT DETECTORS WITH MECHANICAL PLANS.

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LOCATIONS OF SMOKE, FIRE/SMOKE DAMPERS, AND ROOF TOP UNITS REQUIRING CONNECTION TO FIRE

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COORDINATE ALL DEVICE LOCATIONS WITH LATEST ARCHITECTURAL INTERIOR ELEVATIONS TO VERIFY

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3. 4x8 FIRE RATED BACKBOARDS FOR CATV AND PHONE

4. 42" 'RF' TRANSPARENT SMART PANEL FOR UTILITY



2222 NE Oregon Street, Suite 213 Portland, Oregon 97232 john@wright-architecture.com



NATIVE LAND DEVELOPMENT

Project Name:


MINNESOTA PLACES

1208 N. JESSUP & 5627 N. MINNESOTA (R226159, R226160)

PERMIT SET


Issued:	
PERMIT SET	7.29.2021
Job #:	2020
ORIGINAL SHEET SIZE: 2 HALF SIZE: 12" x 18"	24" x 36"

SEVENTH FLOOR TECHNOLOGY PLAN

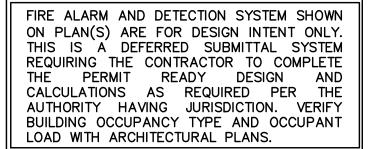

Drawing Number

T3.07

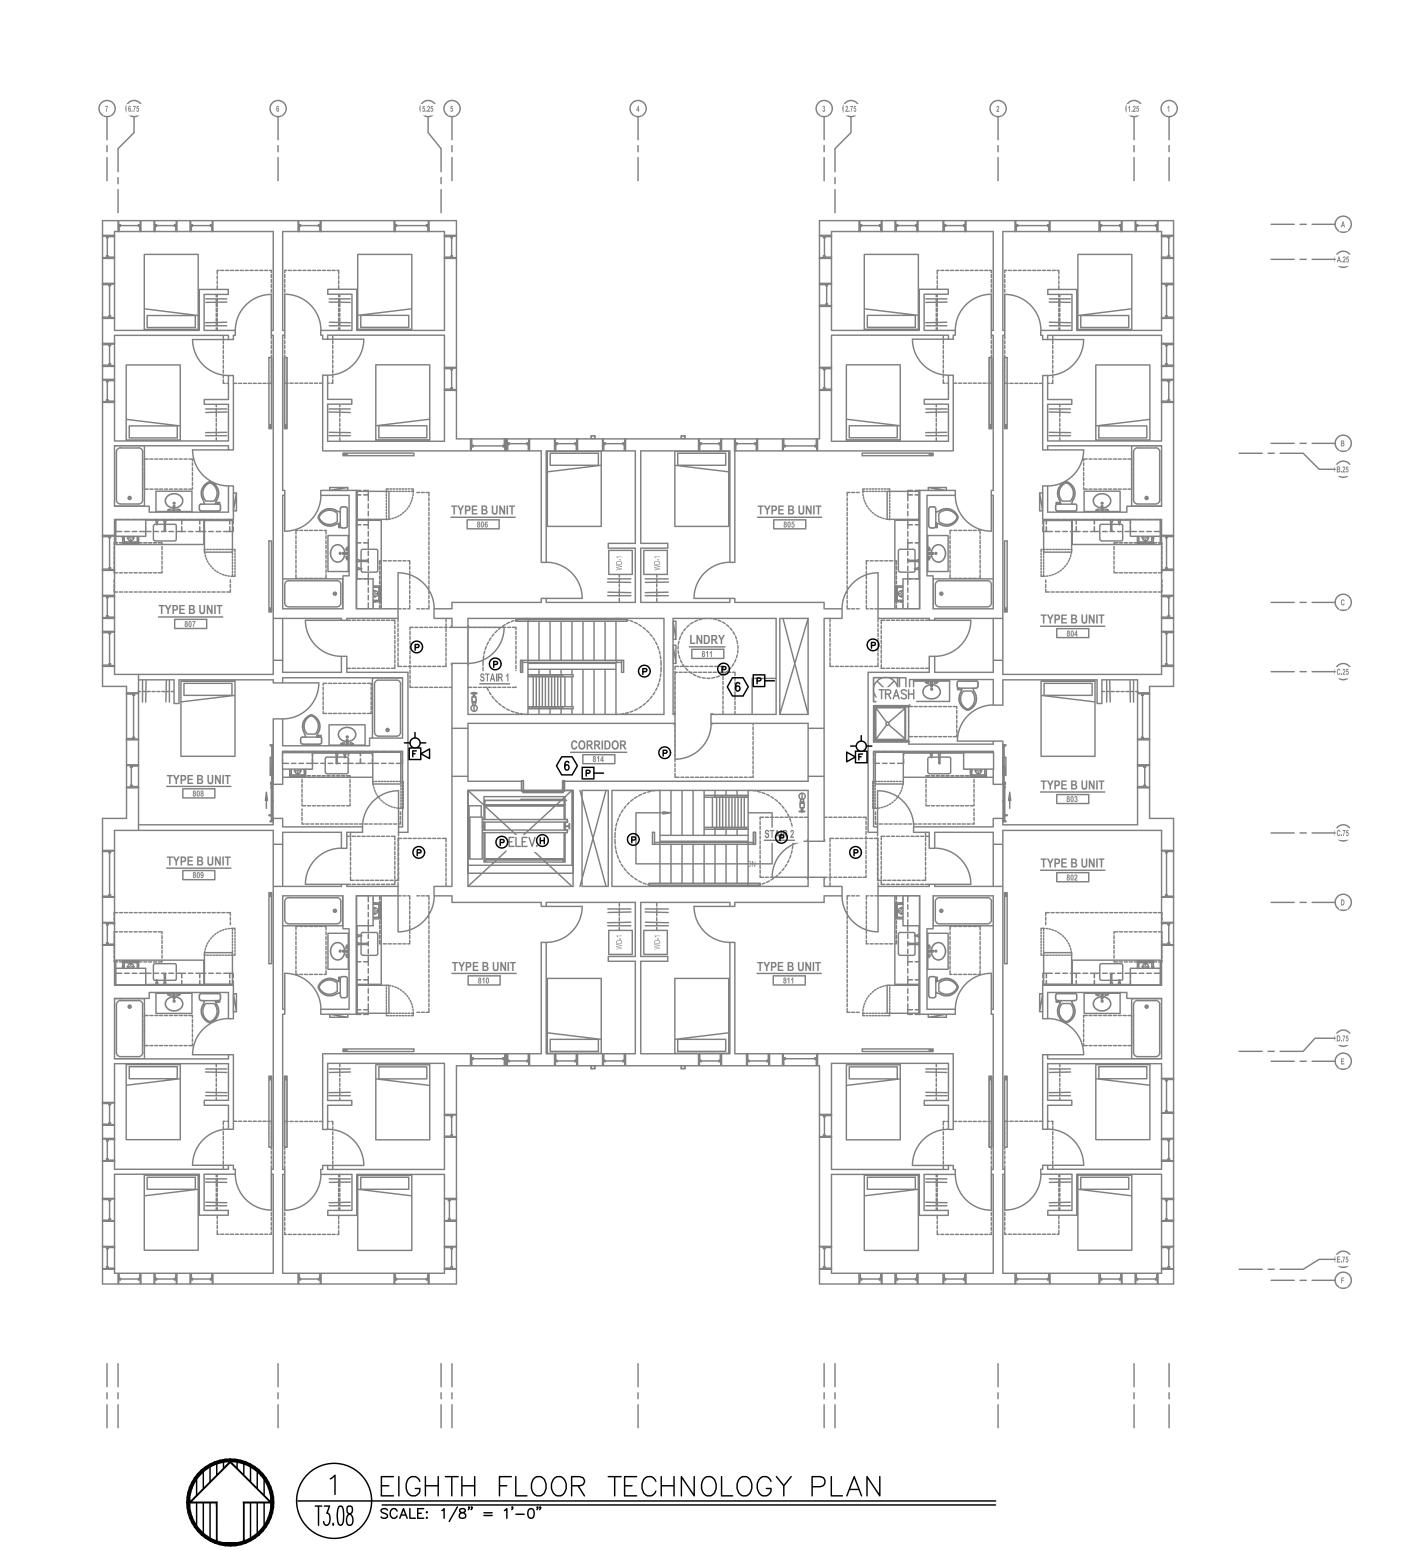

L_____

<u>GENERAL NOTES:</u>

- MAY NOT ACCURATELY REFLECT ACTUAL CONTRACTOR SHALL BE RESPONSIBLE FOR COORDINATING THE INSTALLATION OF ALL TO AND DURING CONSTRUCTION.
- C. COORDINATE WITH MECHANICAL PLANS FOR ALARM SYSTEM.
- THREAD ON PLASTIC BUSHING FOR CABLE THAN 18" SEPARATION. COORDINATE WITH ELECTRICAL.
- Ε. DEVICES WILL NOT BE OBSTRUCTED.
- F. REFER TO ENLARGED TYPICAL UNIT PLANS (IF PROVIDED) FOR TYPICAL LAYOUTS FOR ALL APARTMENT UNIT TYPES.

PLAN NOTES: 1. STROBES TO BE PLACED AT 24" AT ELECTRICAL UTILITY REQUEST.

- SWITCHES WITH FIRE SPRINKLER PLANS.
- UTILITY.
- DEMARCATION WITHIN UNIT.
- 5. SMOKE AND CO DETECTORS CAN BE A SINGLE COMBINED UNIT.
- 6. VERIFY EXACT LOCATION AND COUNT OF DUCT DETECTORS WITH MECHANICAL PLANS.

A. TECHNOLOGY DRAWINGS ARE DIAGRAMMATICAL AND CONSTRUCTION CONDITIONS. THE TECHNOLOGY TECHNOLOGY EQUIPMENT, WITH ALL TRADES PRIOR

B. THE TECHNOLOGY CONTRACTOR SHALL REFER TO THE ARCHITECTURAL DRAWINGS FOR ALL MOUNTING HEIGHTS AND FINISHES OF DEVICES AND FIXTURES.

LOCATIONS OF SMOKE, FIRE/SMOKE DAMPERS, AND ROOF TOP UNITS REQUIRING CONNECTION TO FIRE

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COORDINATE ALL DEVICE LOCATIONS WITH LATEST ARCHITECTURAL INTERIOR ELEVATIONS TO VERIFY

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3. 4x8 FIRE RATED BACKBOARDS FOR CATV AND PHONE

4. 42" 'RF' TRANSPARENT SMART PANEL FOR UTILITY



2222 NE Oregon Street, Suite 213 Portland, Oregon 97232



NATIVE LAND DEVELOPMENT

Project Name:


MINNESOTA PLACES

1208 N. JESSUP & 5627 N. MINNESOTA (R226159, R226160)


PERMIT SET

Issued:	
PERMIT SET	7.29.2021
Job #:	2020
ORIGINAL SHEET SIZE: 2 HALF SIZE: 12" x 18"	24" x 36"

EIGHTH FLOOR TECHNOLOGY PLAN Drawing Number

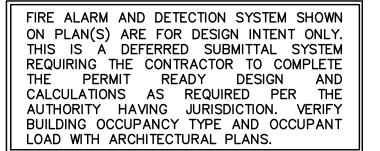



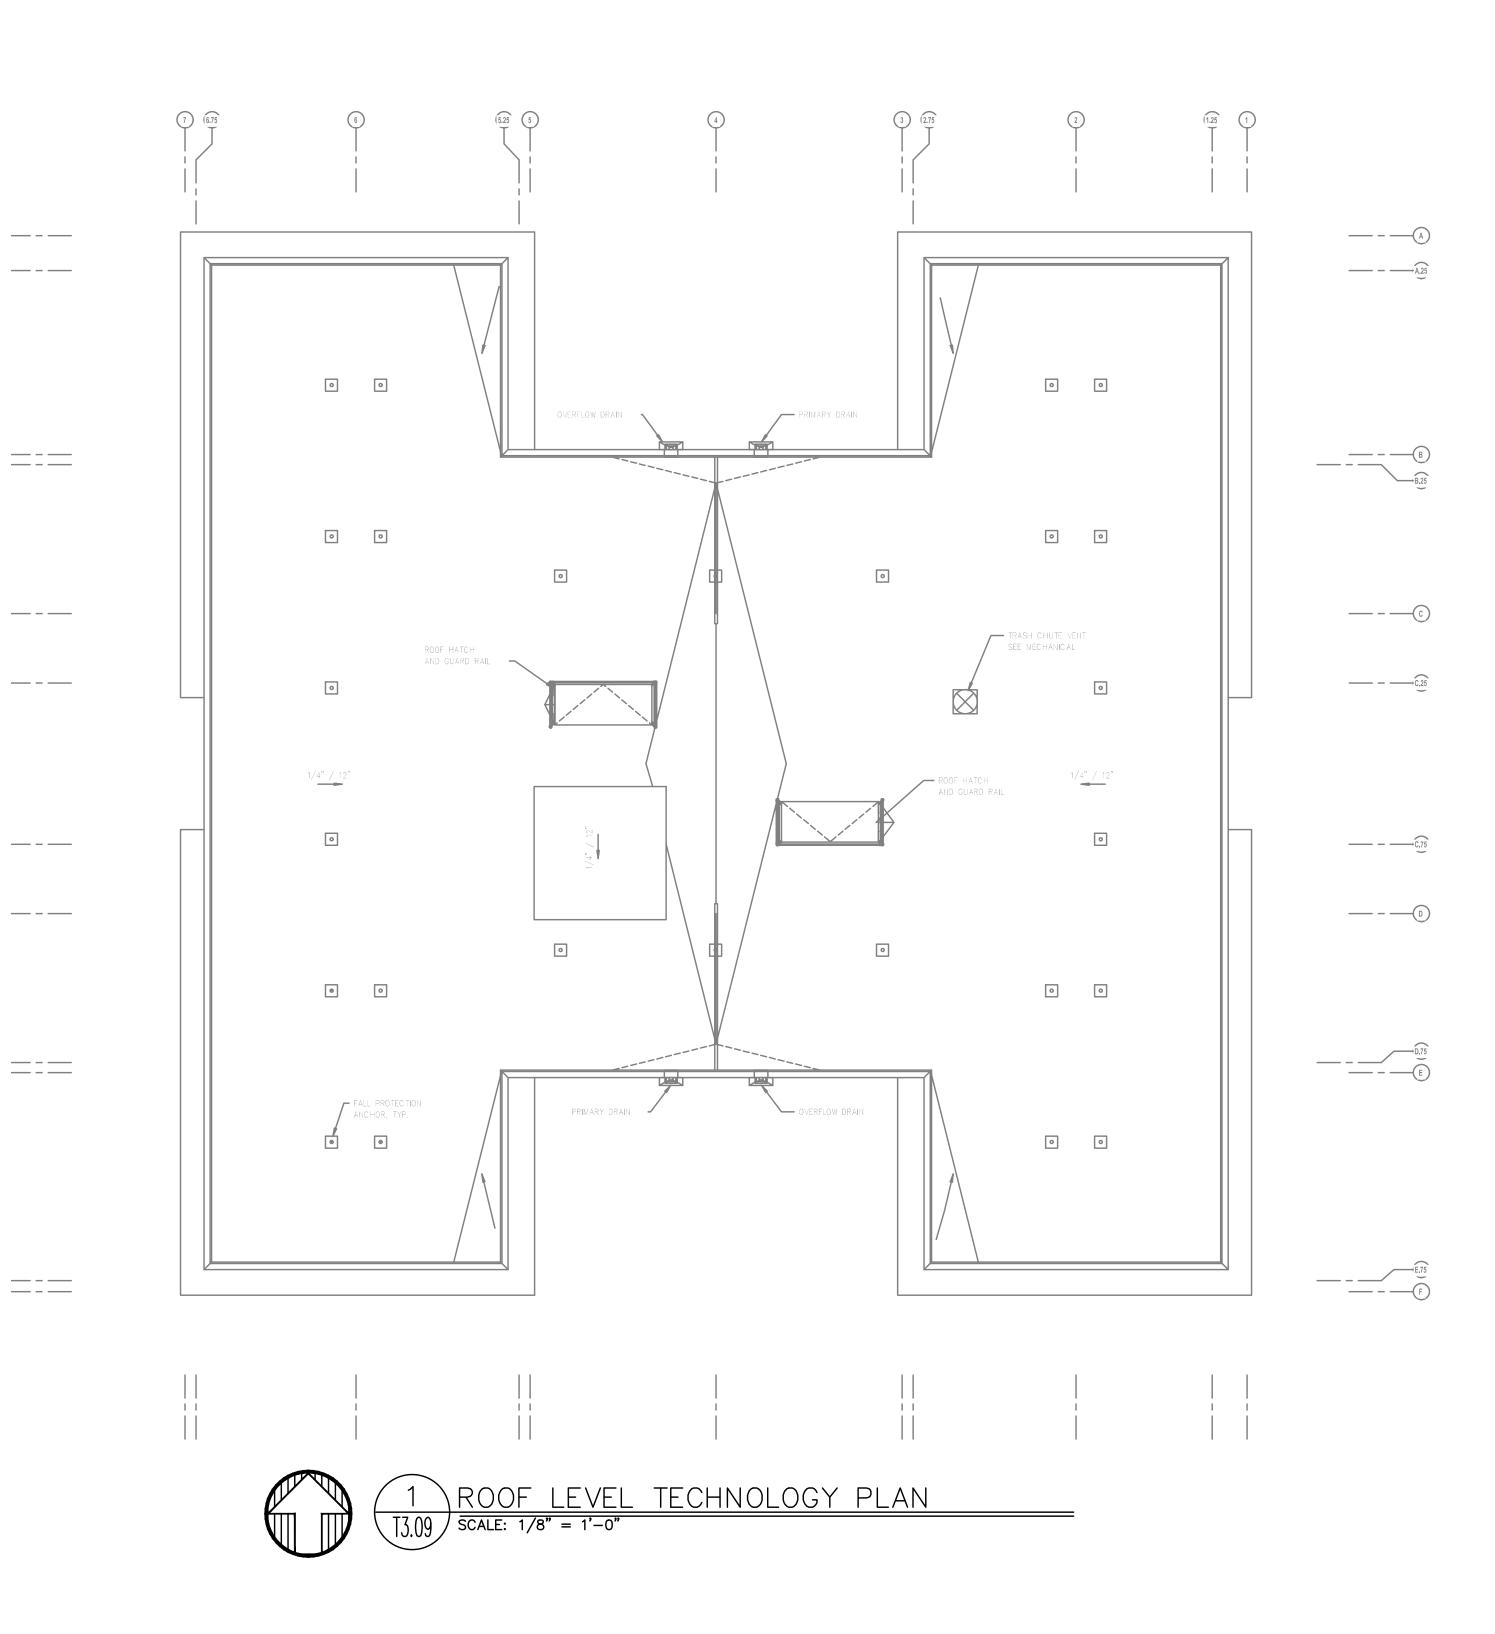

L_____

GENERAL NOTES:

- MAY NOT ACCURATELY REFLECT ACTUAL CONTRACTOR SHALL BE RESPONSIBLE FOR COORDINATING THE INSTALLATION OF ALL TO AND DURING CONSTRUCTION.
- C. COORDINATE WITH MECHANICAL PLANS FOR ALARM SYSTEM.
- THREAD ON PLASTIC BUSHING FOR CABLE THAN 18" SEPARATION. COORDINATE WITH ELECTRICAL.
- Ε. DEVICES WILL NOT BE OBSTRUCTED.
- F. REFER TO ENLARGED TYPICAL UNIT PLANS (IF PROVIDED) FOR TYPICAL LAYOUTS FOR ALL APARTMENT UNIT TYPES.

PLAN NOTES: 1. STROBES TO BE PLACED AT 24" AT ELECTRICAL UTILITY REQUEST.

- SWITCHES WITH FIRE SPRINKLER PLANS.
- UTILITY.
- DEMARCATION WITHIN UNIT.
- 5. SMOKE AND CO DETECTORS CAN BE A SINGLE COMBINED UNIT.
- 6. VERIFY EXACT LOCATION AND COUNT OF DUCT DETECTORS WITH MECHANICAL PLANS.

A. TECHNOLOGY DRAWINGS ARE DIAGRAMMATICAL AND CONSTRUCTION CONDITIONS. THE TECHNOLOGY TECHNOLOGY EQUIPMENT, WITH ALL TRADES PRIOR

B. THE TECHNOLOGY CONTRACTOR SHALL REFER TO THE ARCHITECTURAL DRAWINGS FOR ALL MOUNTING HEIGHTS AND FINISHES OF DEVICES AND FIXTURES.

LOCATIONS OF SMOKE, FIRE/SMOKE DAMPERS, AND ROOF TOP UNITS REQUIRING CONNECTION TO FIRE

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COORDINATE ALL DEVICE LOCATIONS WITH LATEST ARCHITECTURAL INTERIOR ELEVATIONS TO VERIFY

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3. 4x8 FIRE RATED BACKBOARDS FOR CATV AND PHONE

4. 42" 'RF' TRANSPARENT SMART PANEL FOR UTILITY



2222 NE Oregon Street, Suite 213 Portland, Oregon 97232



NATIVE LAND DEVELOPMENT

Project Name:

MINNESOTA PLACES

1208 N. JESSUP & 5627 N. MINNESOTA (R226159, R226160)


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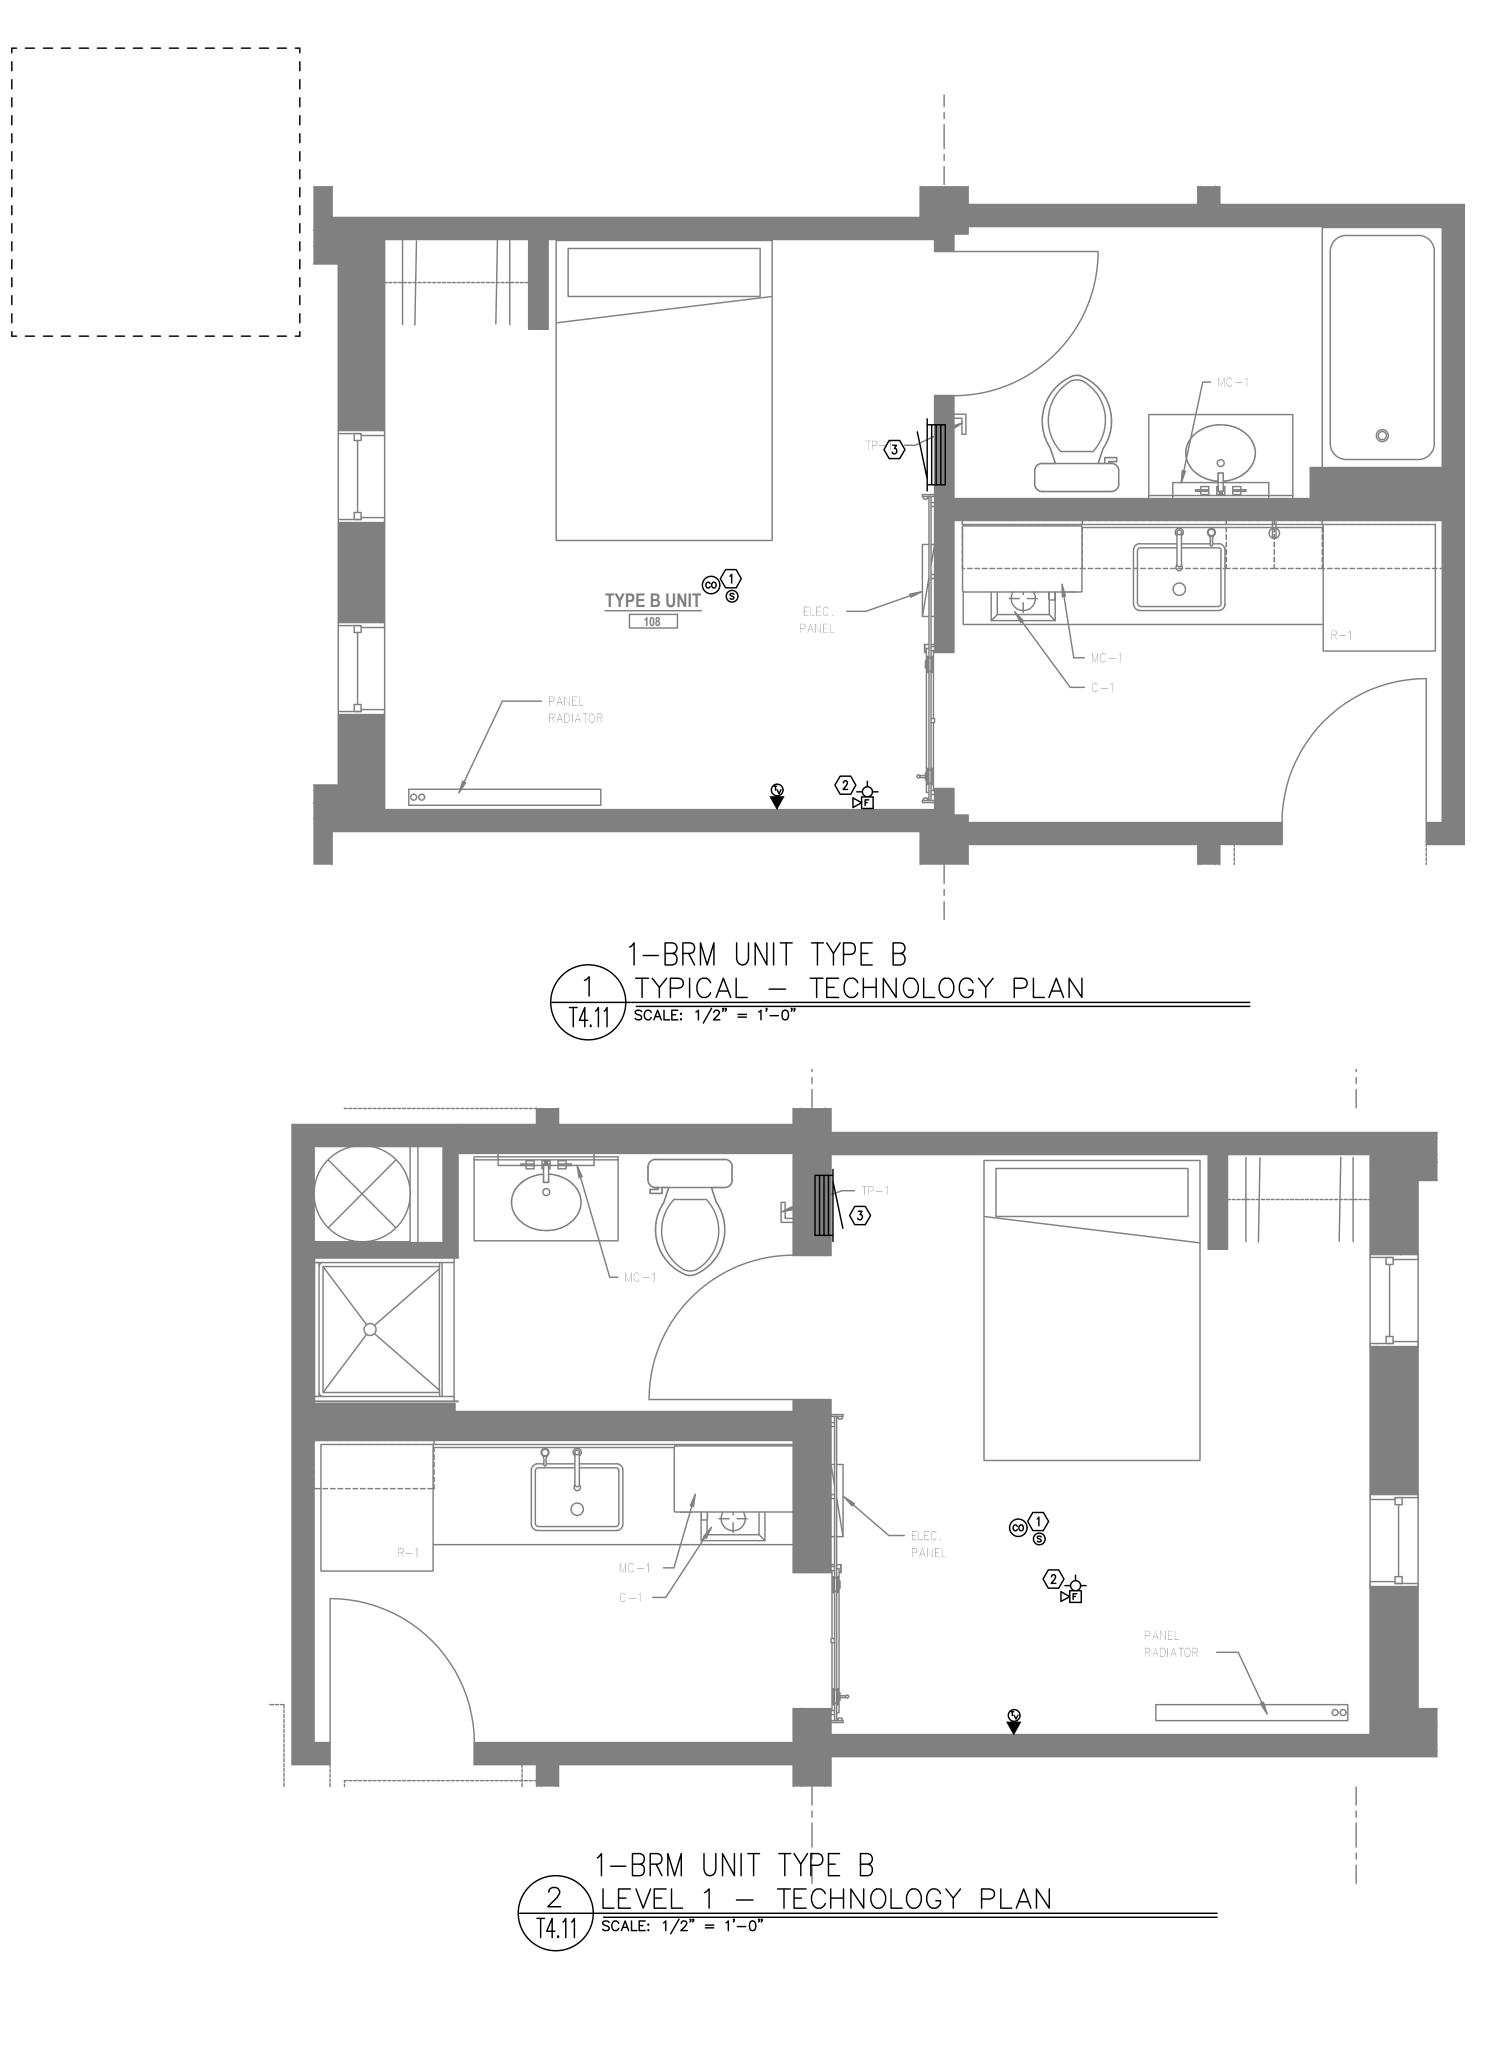
Issued:	
PERMIT SET	7.29.2021
Job #:	2020
ORIGINAL SHEET SIZE: 2 HALF SIZE: 12" x 18"	24" x 36"


ROOF LEVEL TECHNOLOGY PLAN







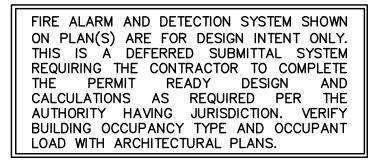

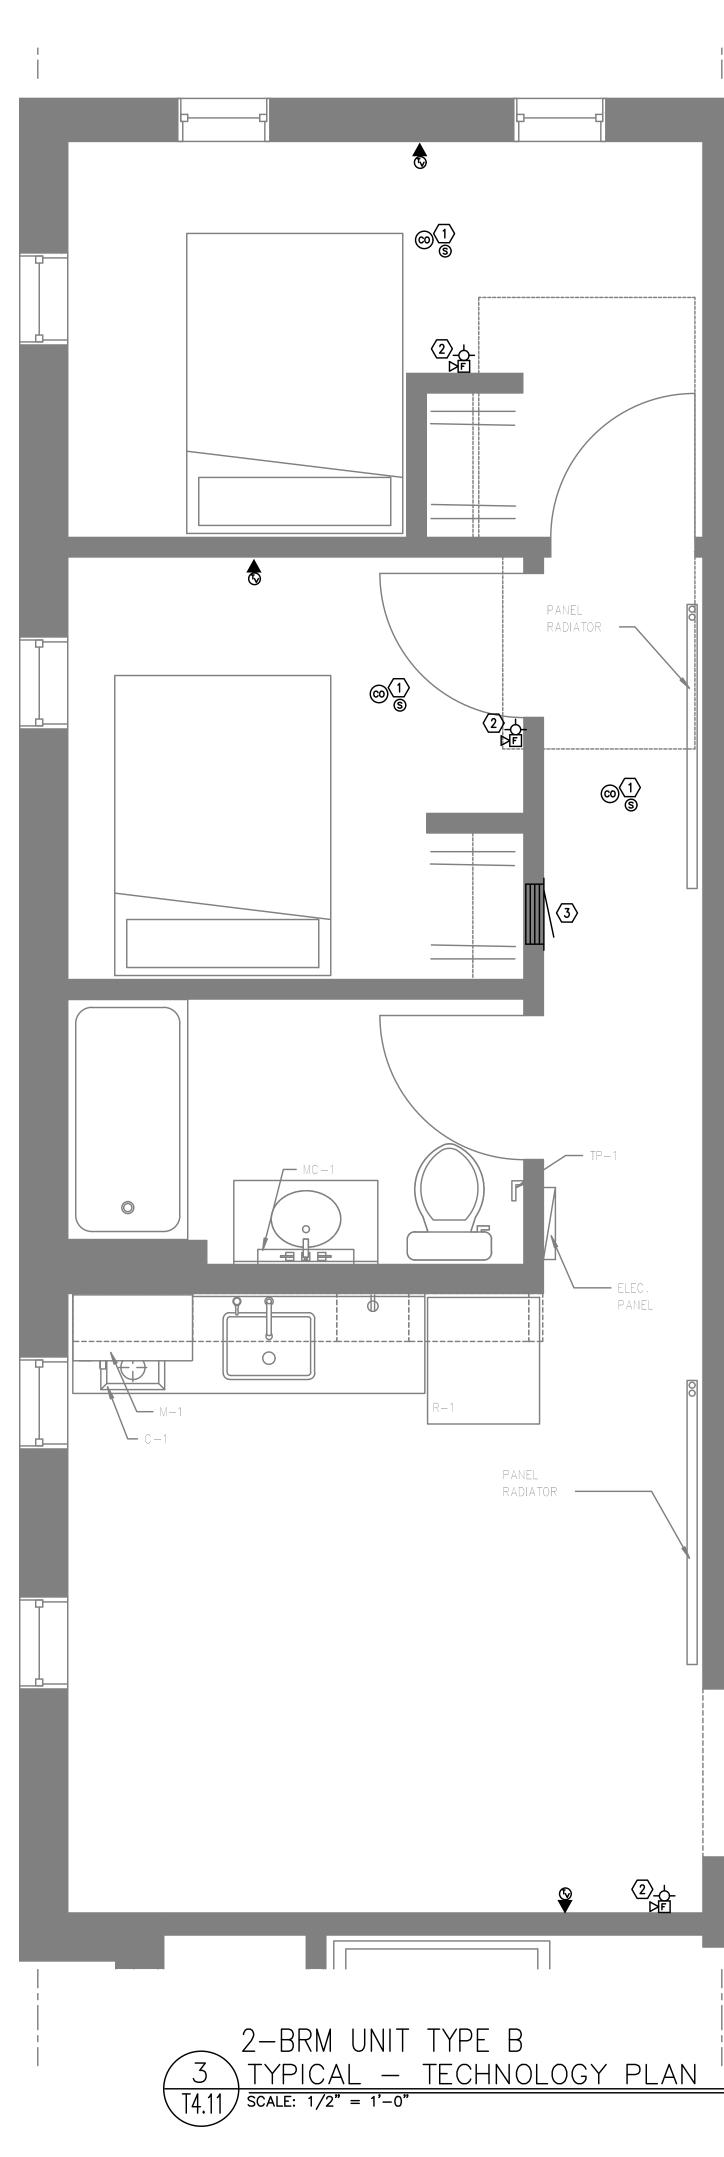

_____A

GENERAL NOTES:

- A. ALL PLANS ARE DIAGRAMMATICAL. CONSULT ARCHITECTURAL PLANS FOR EXACT LOCATION OF ALL DEVICES AND FIXTURES.
- B. REFER TO DETAILS ON ELECTRICAL SHEET FOR ADDITIONAL INFORMATION REGARDING ADA REACH REQUIREMENTS FOR OUTLET MOUNTING HEIGHT.
 - C. STANDARD RECEPTACLE MOUNTING HEIGHT IS 18" A.F.F. UNLESS OTHERWISE SPECIFIED. RECEPTACLES LOCATED BELOW WINDOW SILLS SHALL NOT BE LESS THE 15" A.F.F. AS REQUIRED BY CODE. DEVICES LOCATED BELOW WINDOW SILLS MAY BE ROTATED 90" IF NECESSARY. CONTRACTOR TO ADVISE ARCHITECT IMMEDIATELY IF CONFLICT BETWEEN DEVICES AND WINDOW SILLS IS APPARENT.
 - D. COORDINATE WITH ELECTRICAL FOR ROUGH IN OF LOW VOLTAGE DEVICES. REFER TO 'E' SERIES SHEETS FOR ADDITIONAL INFORMATION.

○ NOTES:

— - — - — B

- 1. SMOKE AND 'CO' DETECTOR CAN BE A SINGLE DEVICE.
- 2. FIRE ALARM STROBE/SPEAKER TO REPORT BUILDING FIRE ALARM CONDITIONS.
- 3. 42" HEIGHT 'RF' TRANSPARENT PANEL FOR UTILITY DEMARCATION WITHIN UNIT.



wright

Project Name:

MINNESOTA PLACES


1208 N. JESSUP & 5627 N. MINNESOTA (R226159, R226160)

PERMIT SET


PERMIT SET	7.29.2021
Job #:	2020
ORIGINAL SHEET SIZE: HALF SIZE: 12" x 18"	24" x 36"

TYPICAL UNIT TECHNOLOGY PLANS

Drawing Number

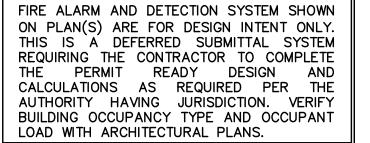

T4.11

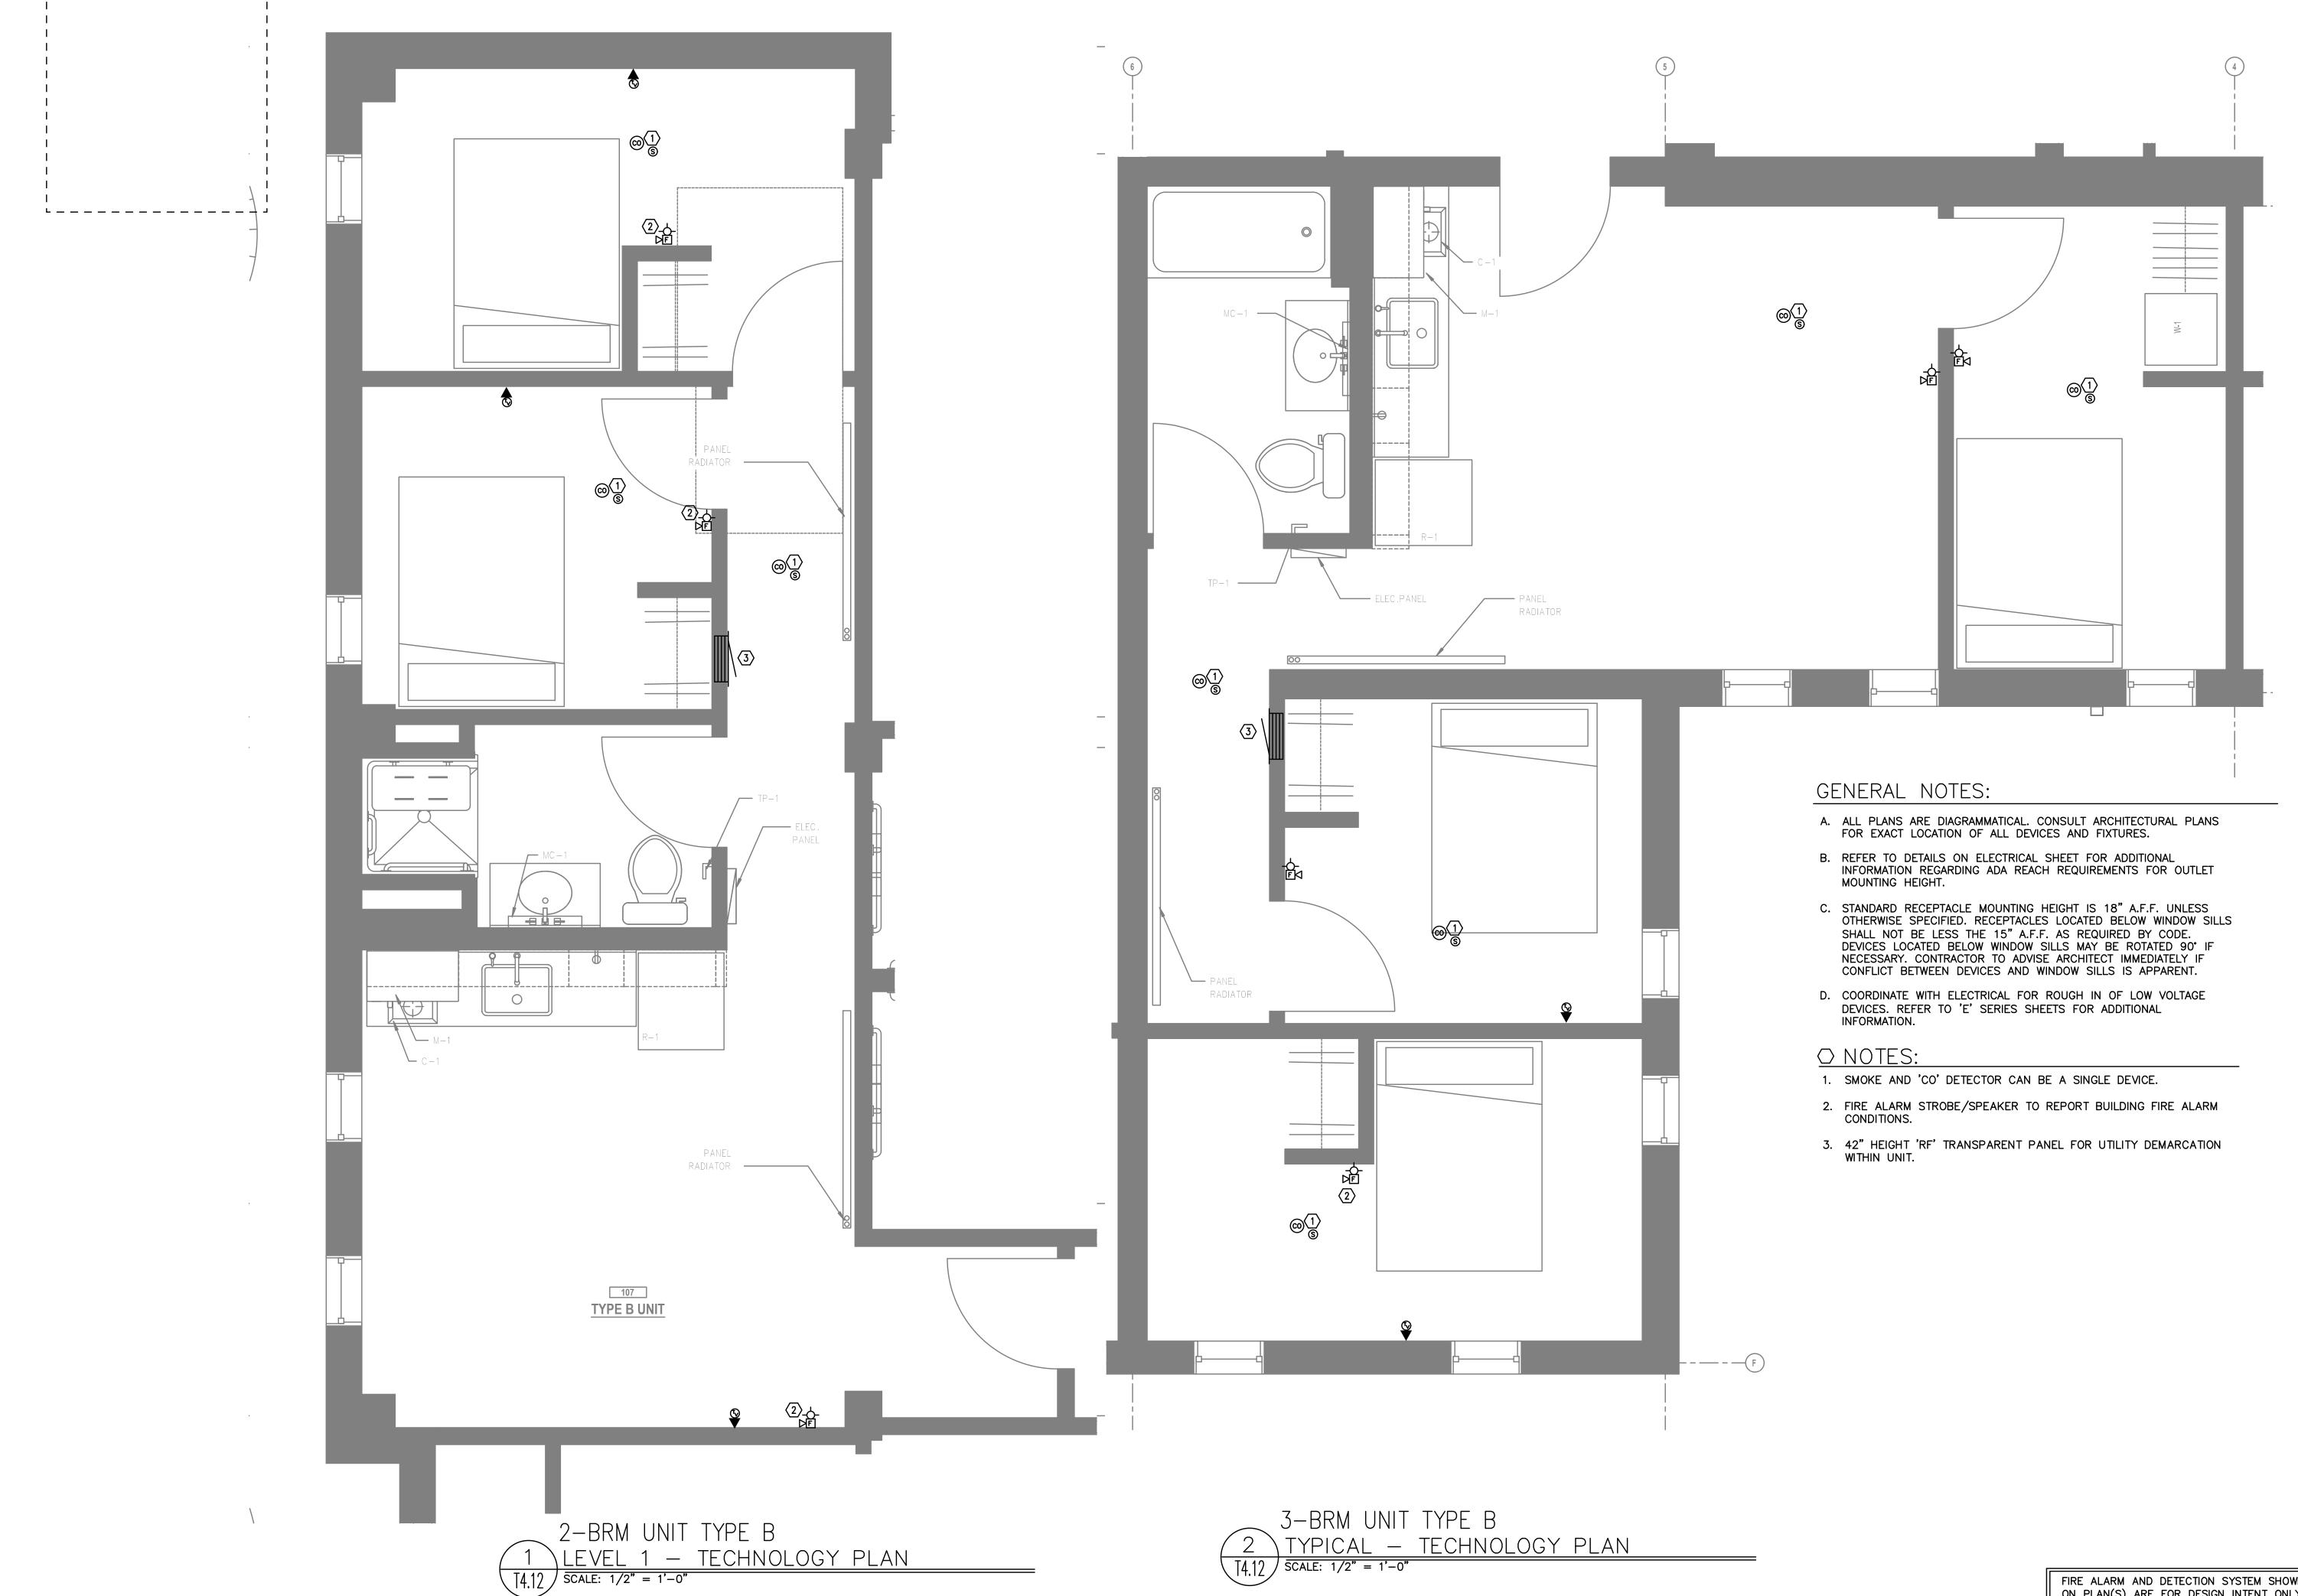

wright www.wright-architecture.com 2222 NE Oregon Street, Suite 213 Portland, Oregon 97232 john@wright-architecture.com 503.206.8380 PRELIMINARY



Project Name: MINNESOTA

PLACES


1208 N. JESSUP & 5627 N. MINNESOTA (R226159, R226160)

PERMIT SET


Issued:	
PERMIT SET	7.29.2021
Job #:	2020
ORIGINAL SHEET SIZE: 24 HALF SIZE: 12" x 18"	" x 36"

TYPICAL UNIT TECHNOLOGY PLANS


Drawing Number

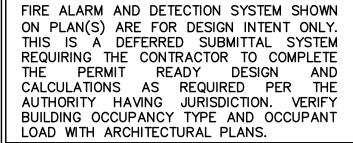

T4.12

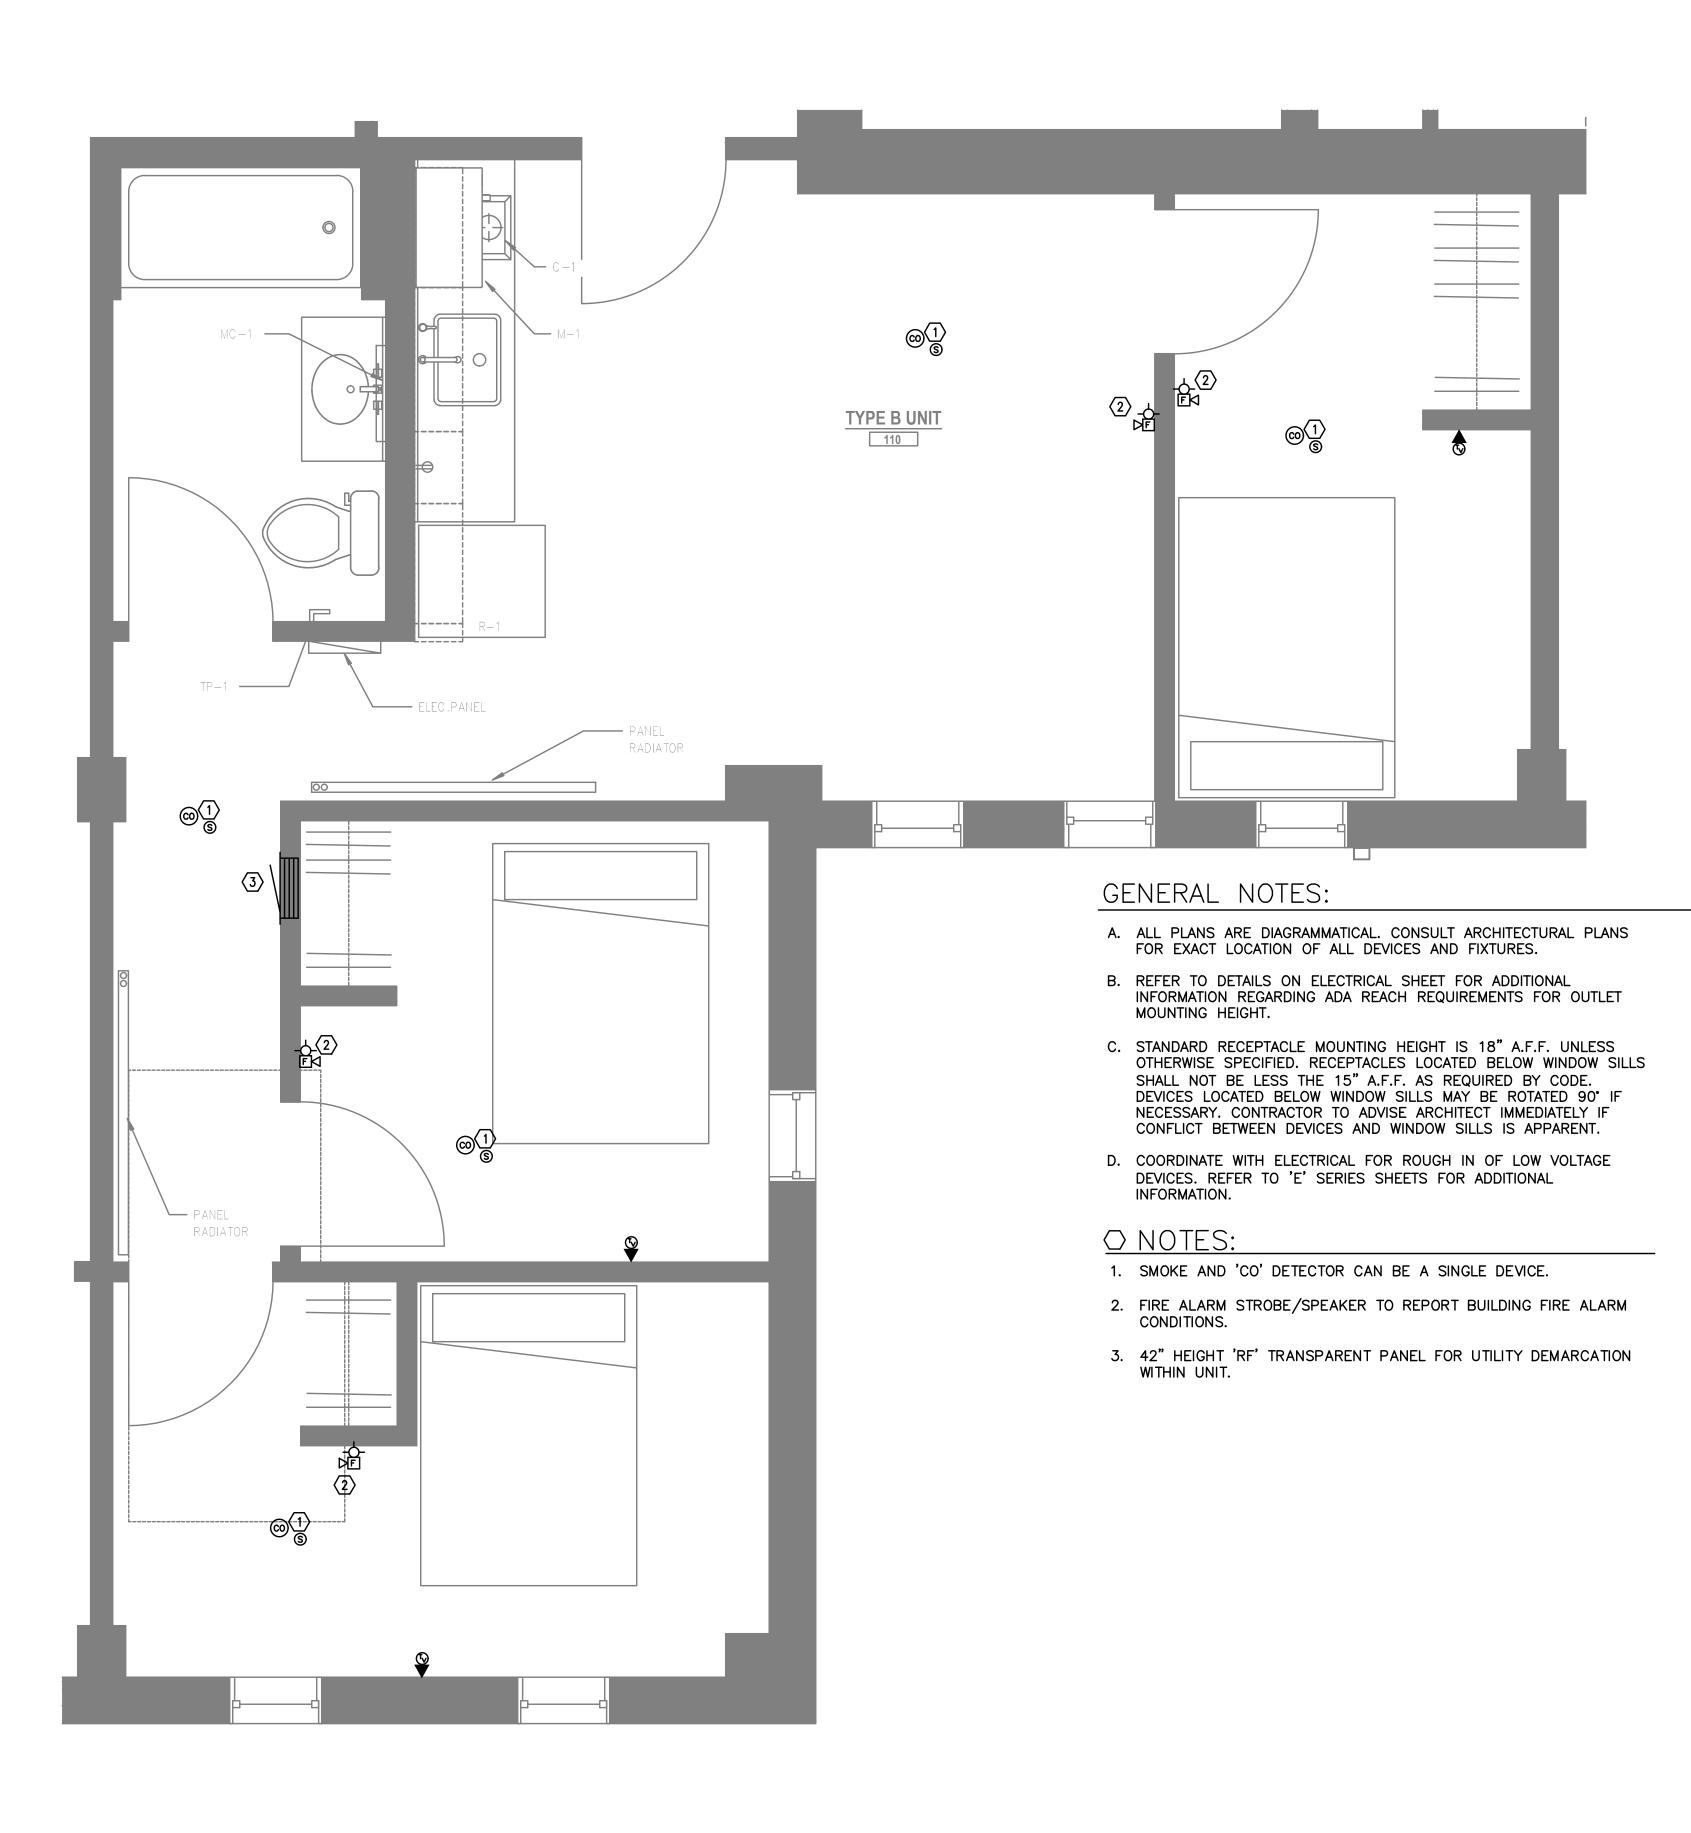


3-BRM UNIT TYPE B 1 <u>LEVEL 1 – TECHNOLOGY PLAN</u> [1,13] <u>SCALE: 1/2" = 1'-0"</u>

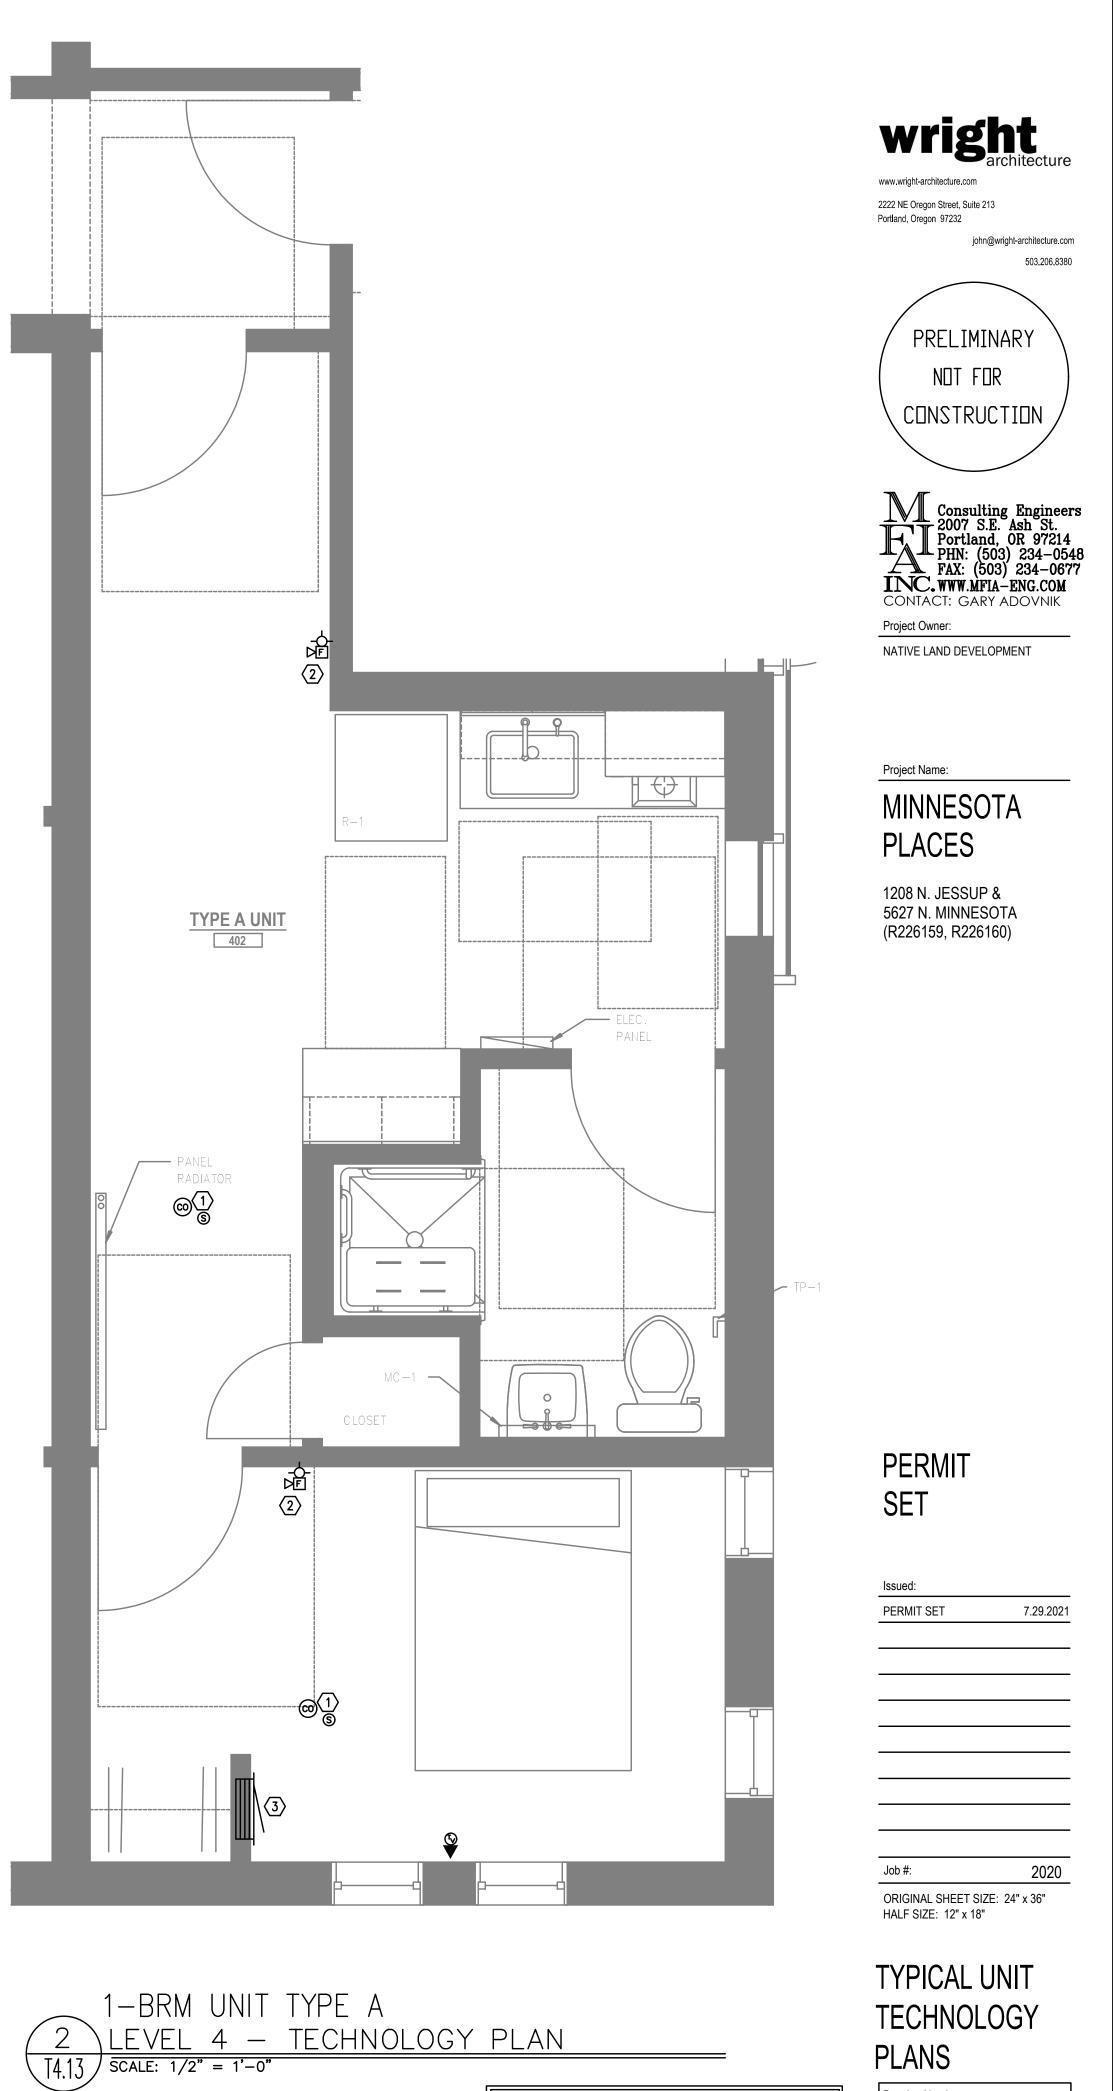


FIRE ALARM AND DETECTION SYSTEM SHOWN ON PLAN(S) ARE FOR DESIGN INTENT ONLY. THIS IS A DEFERRED SUBMITTAL SYSTEM REQUIRING THE CONTRACTOR TO COMPLETE THE PERMIT READY DESIGN AND CALCULATIONS AS REQUIRED PER THE AUTHORITY HAVING JURISDICTION. VERIFY BUILDING OCCUPANCY TYPE AND OCCUPANT LOAD WITH ARCHITECTURAL PLANS.

Drawing Number

T4.13

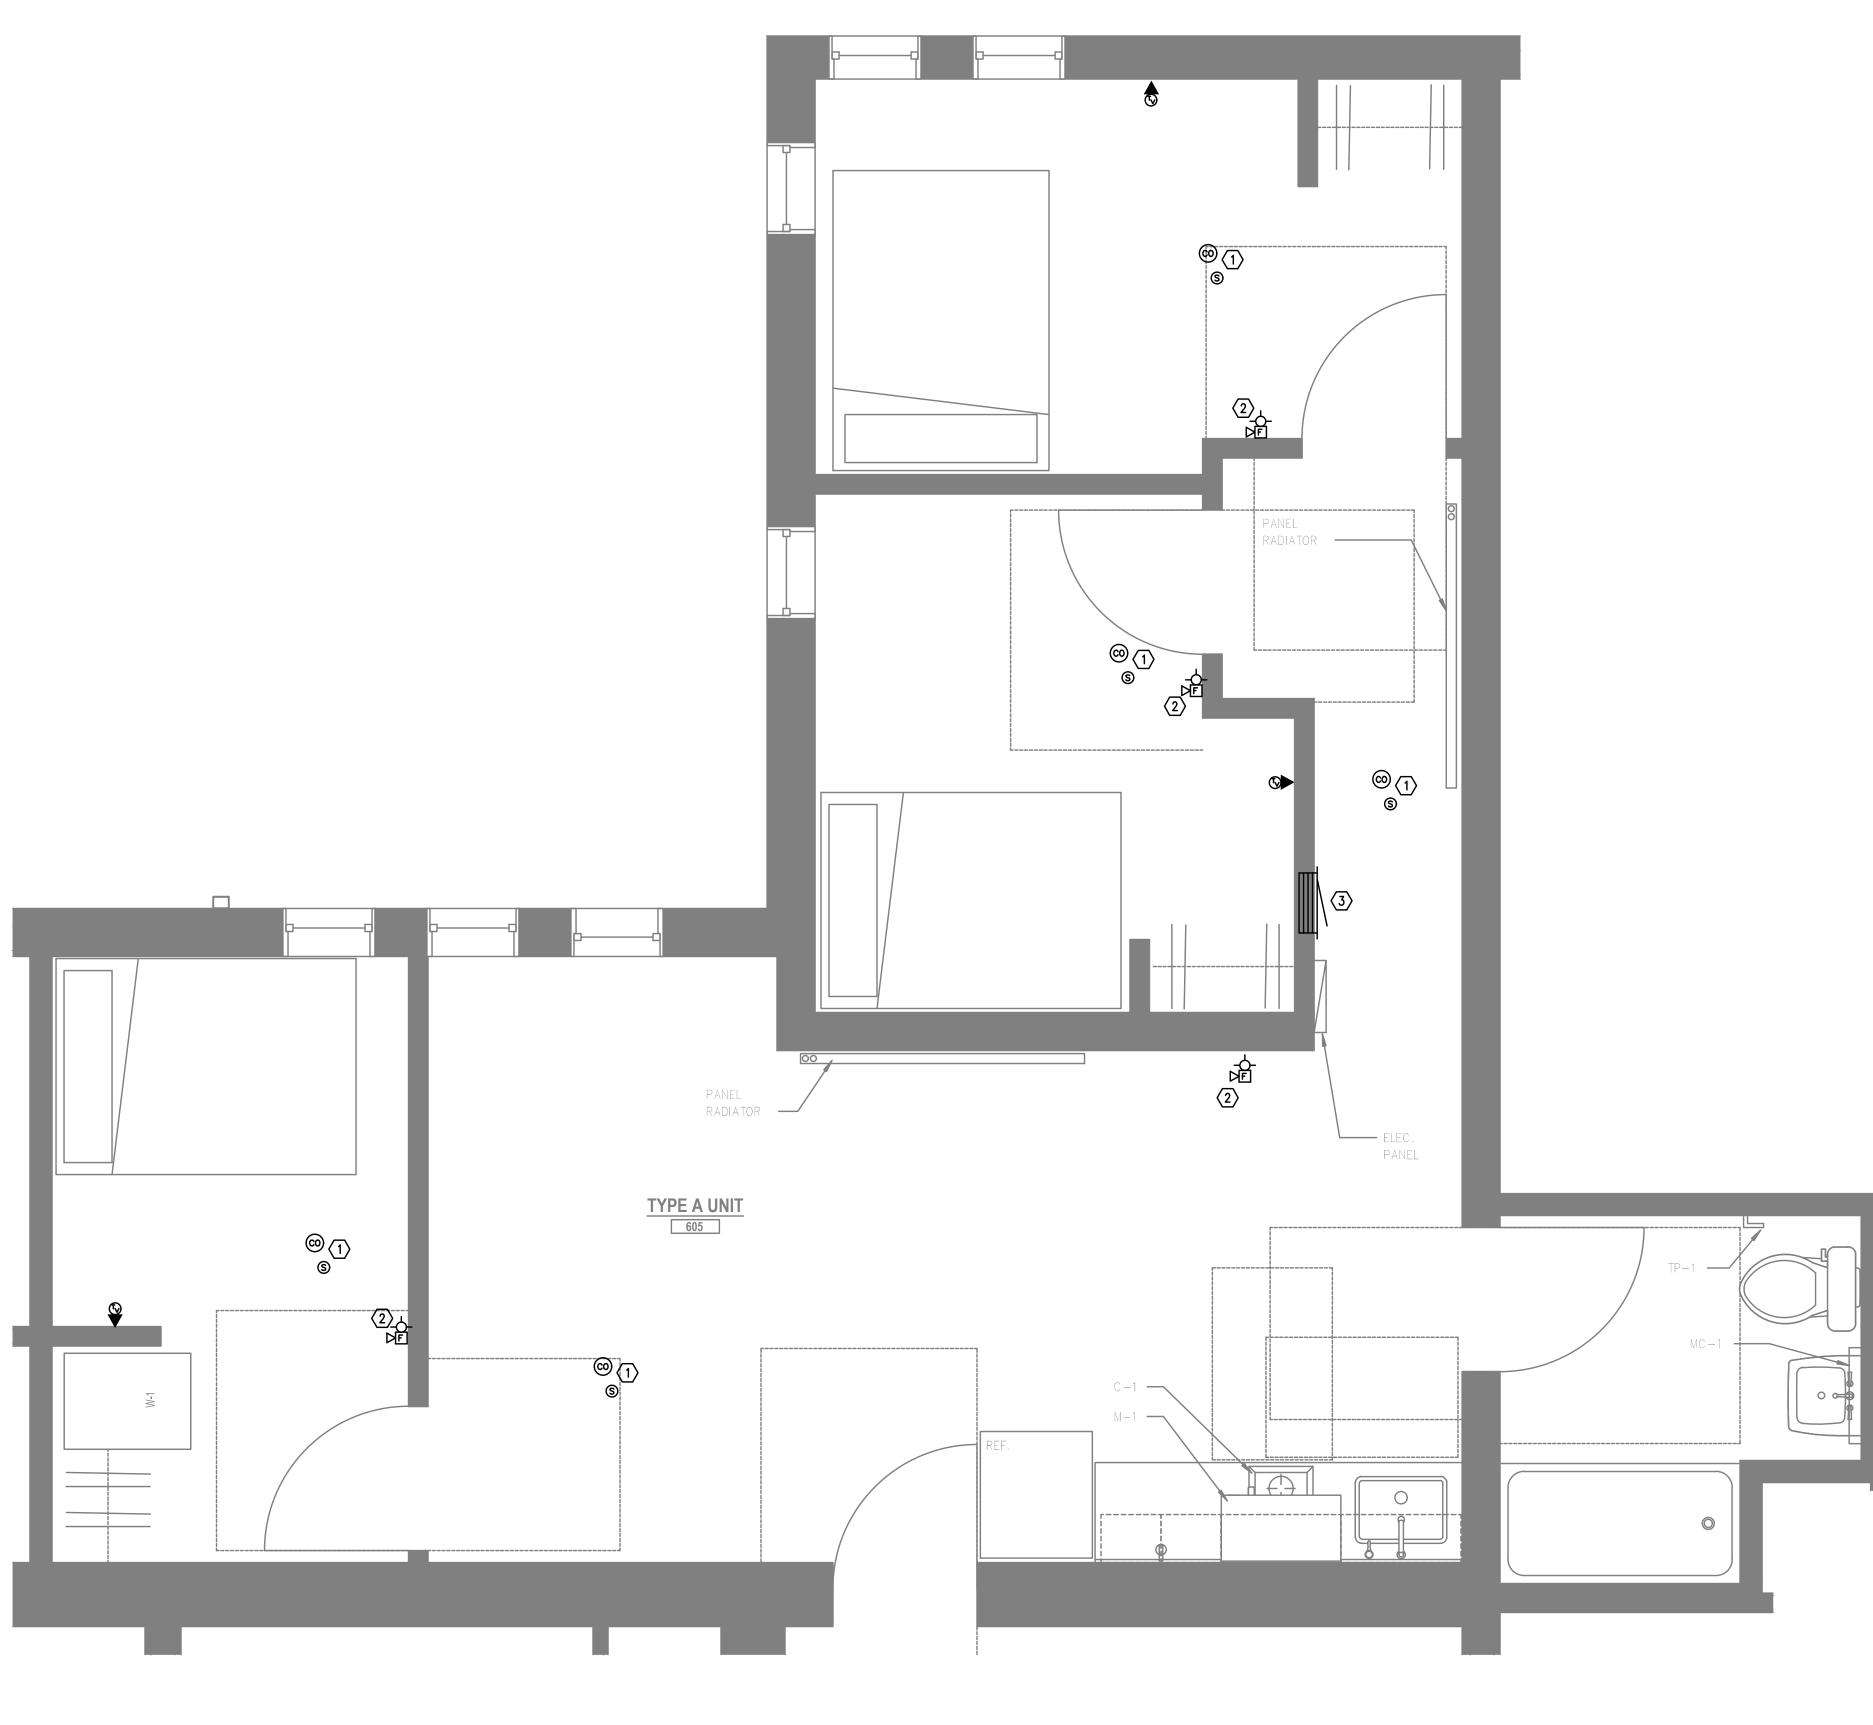

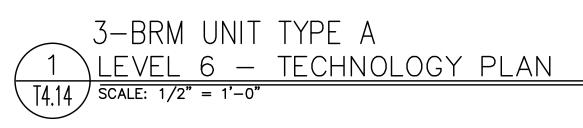

GENERAL NOTES:

- A. ALL PLANS ARE DIAGRAMMATICAL. CONSULT ARCHITECTURAL PLANS FOR EXACT LOCATION OF ALL DEVICES AND FIXTURES.
- B. REFER TO DETAILS ON ELECTRICAL SHEET FOR ADDITIONAL INFORMATION REGARDING ADA REACH REQUIREMENTS FOR OUTLET MOUNTING HEIGHT.
- C. STANDARD RECEPTACLE MOUNTING HEIGHT IS 18" A.F.F. UNLESS OTHERWISE SPECIFIED. RECEPTACLES LOCATED BELOW WINDOW SILLS SHALL NOT BE LESS THE 15" A.F.F. AS REQUIRED BY CODE. DEVICES LOCATED BELOW WINDOW SILLS MAY BE ROTATED 90° IF NECESSARY. CONTRACTOR TO ADVISE ARCHITECT IMMEDIATELY IF CONFLICT BETWEEN DEVICES AND WINDOW SILLS IS APPARENT.
- D. COORDINATE WITH ELECTRICAL FOR ROUGH IN OF LOW VOLTAGE DEVICES. REFER TO 'E' SERIES SHEETS FOR ADDITIONAL INFORMATION.

○ NOTES:

- 1. SMOKE AND 'CO' DETECTOR CAN BE A SINGLE DEVICE.
- 2. FIRE ALARM STROBE/SPEAKER TO REPORT BUILDING FIRE ALARM CONDITIONS.
- 3. 42" HEIGHT 'RF' TRANSPARENT PANEL FOR UTILITY DEMARCATION WITHIN UNIT.



wright

Project Name:


MINNESOTA PLACES

1208 N. JESSUP & 5627 N. MINNESOTA (R226159, R226160)


PERMIT SET

Issued:	
PERMIT SET	7.29.2021
Job #:	2020
ORIGINAL SHEET SIZE: HALF SIZE: 12" x 18"	24" x 36"

TYPICAL UNIT TECHNOLOGY PLANS

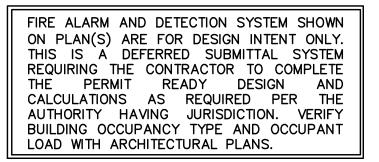

T4.14

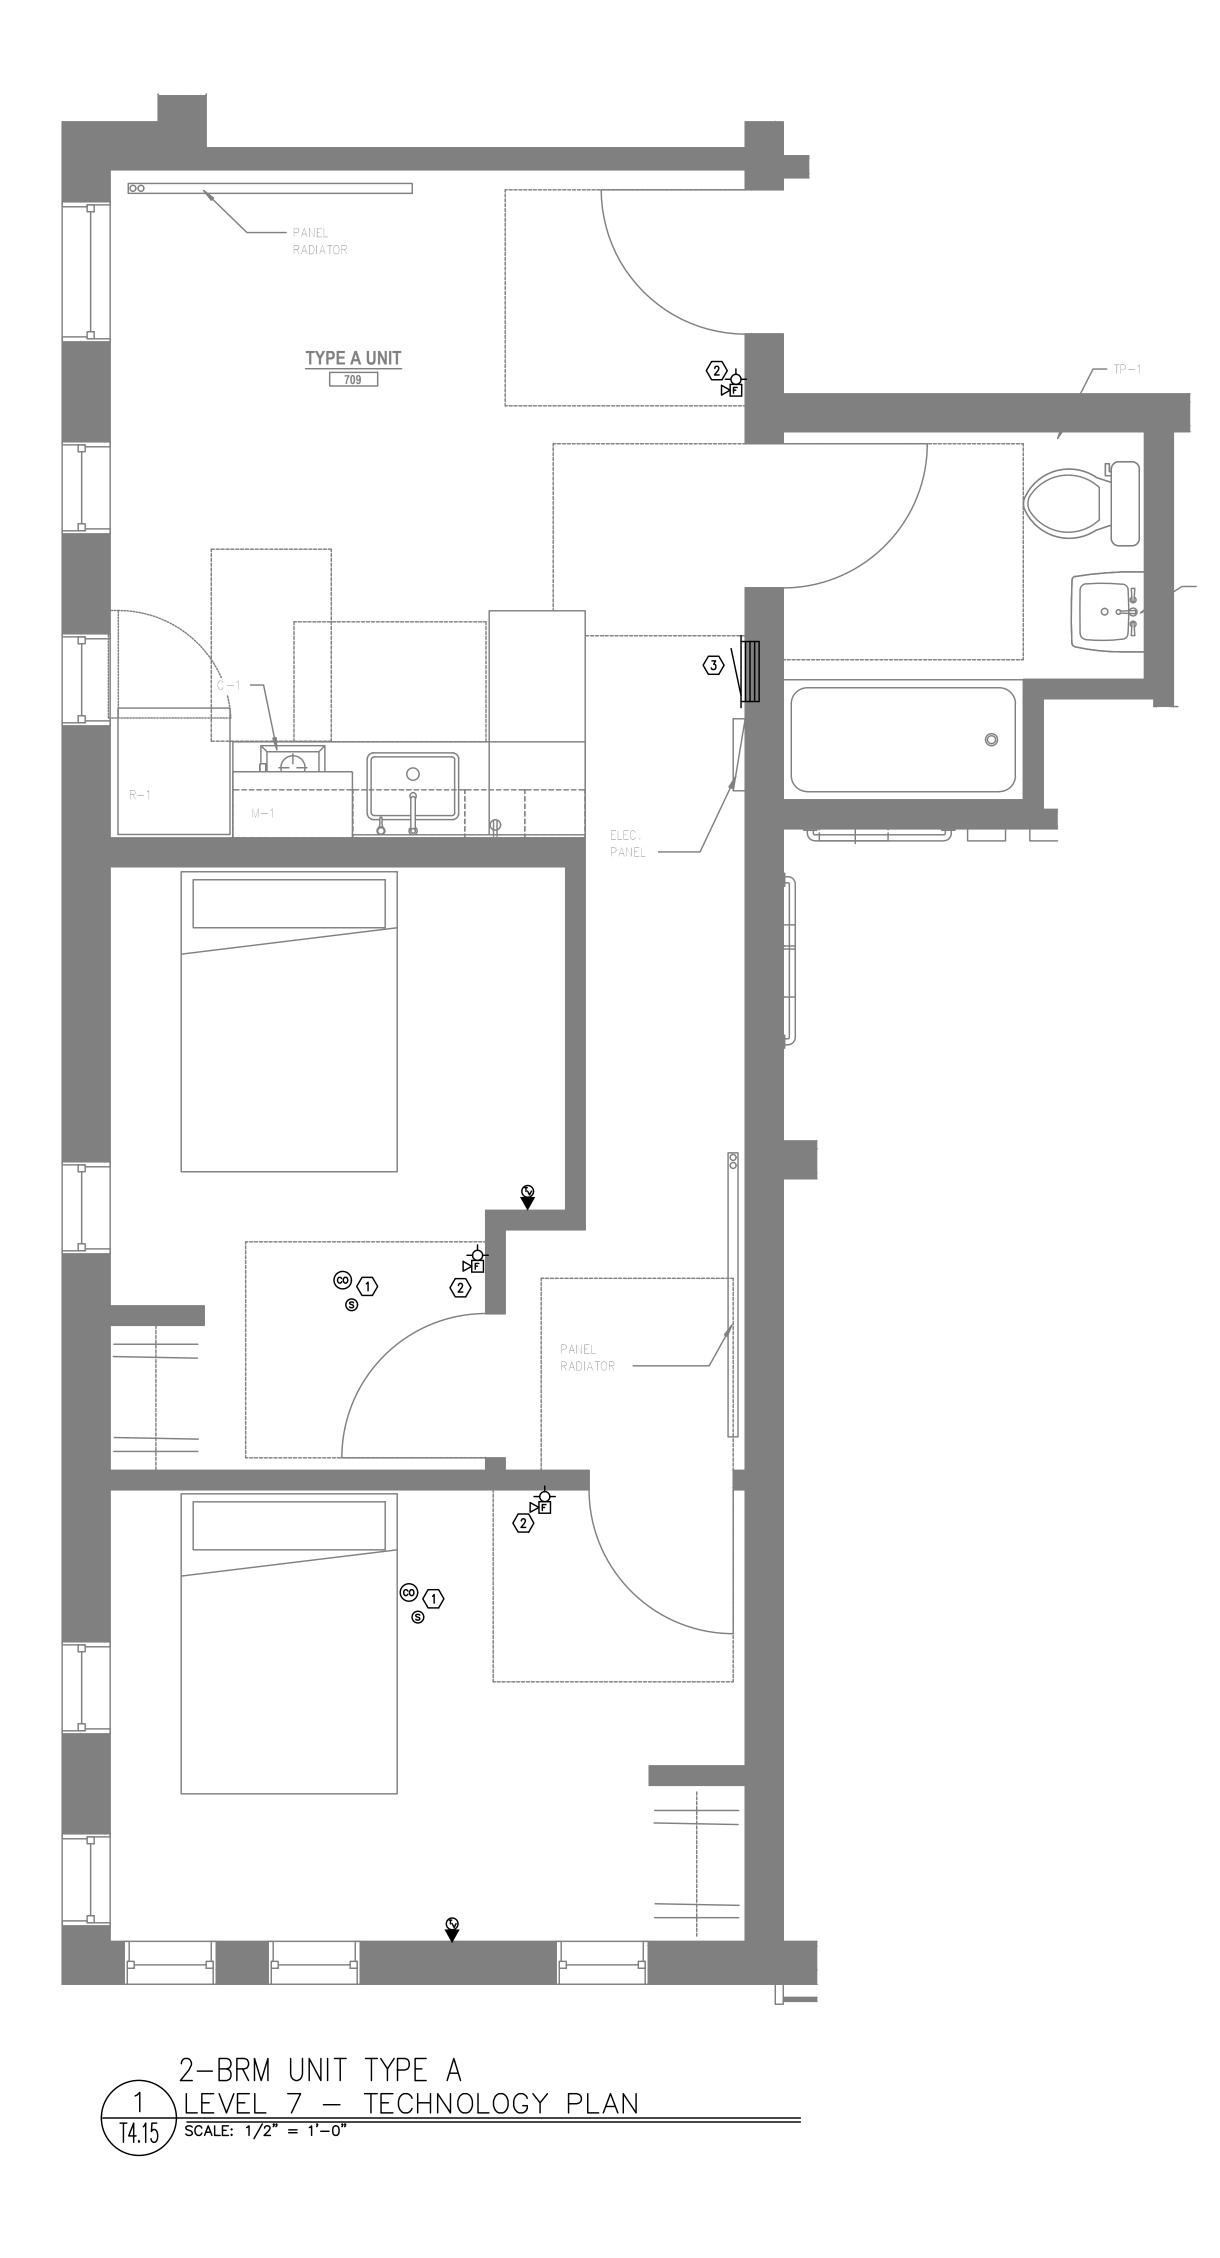


GENERAL NOTES:

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wright

Project Name:

MINNESOTA PLACES

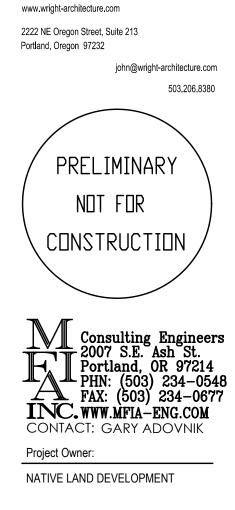1208 N. JESSUP & 5627 N. MINNESOTA (R226159, R226160)

PERMIT SET

7.29.2021
2020
" x 36"

TYPICAL UNIT TECHNOLOGY PLANS



