

GENERAL POWER NOTES:

- A. ALL PLANS ARE CONSIDERED DIAGRAMMATICAL. THEREFORE ALL EQUIPMENT SIZES AND DEVICE LOCATIONS ARE APPROXIMATE AND SUBJECT TO FIELD CONDITIONS AND PRODUCT APPROVAL.
- B. ELECTRICAL SERVICE ENTRANCE EQUIPMENT DESIGN IS BASED ON SIEMENS PRODUCTS. ACTUAL PRODUCTS USED MAY DIFFER IN SIZE AND CONFIGURATION AND SHALL BE NOTED IN FINAL PROJECT DOCUMENTS.
- C. COORDINATE WITH LOCAL UTILITY PROVIDER FOR EXACT SERVICE CONDUIT AND CONDUCTORS REQUIREMENTS.
- D. ALL UTILITY WORK SHALL BE DONE IN ACCORDANCE WITH PGE ELECTRICAL SERVICE REQUIREMENTS.
- E. U.G. PRIMARY FEEDER SHALL HAVE A MINIMUM 48 INCH BURY.
- F. U.G. SECONDARY FEEDER SHALL HAVE A MINIMUM 36 INCH BURY.
- G. REFER TO SHEET E1.11 FOR TYPICAL FEEDER SCHEDULE.
- H. SECONDARY CONDUIT SWEEPS SHALL BE MINIMUM 60 INCH RADIUS WITH A MINIMUM OR 7'-0" STRAIGHT CONDUIT RUN BETWEEN SWEEPS.
- I. LOCATION AND INSTALLATION OF THE PRIMARY AND SECONDARY CONDUITS, TRANSFORMER, ETC. SHALL BE PROVIDED PER PGE ELECTRICAL SERVICE REQUIREMENTS.
- J. REFER TO SHEET E3.01 FOR ELECTRICAL ROOM EQUIPMENT LAYOUT.

PGE REQUIREMENTS

- 1. CUSTOMER TO PROVIDE ALL TRENCHING AND BACKFILLING. TRENCH TO BE 36 INCHES DEEP AND 30 INCHES WIDE, MEASURED FROM FINAL GRADE.
- 2. ALL PGE CONDUCTORS TO BE INSTALLED IN GREY SCHEDULE 40, ELECTRICAL GRADE, PVC CONDUIT WITH NYLON PULL STRINGS (MIN 500 LBS. TEST). PGE TO DETERMINE THE SIZE AND NUMBER OF CONDUITS REQUIRED. ALL ELBOWS TO BE 36 INCH (MIN) RADIUS. ALL BENDS MAY BE FACTORY MADE. IF MORE THAN 270 DEGREES OF BENDS OR IF RUN IS LONGER THAN 150 FEET, BENDS MUST BE RIGID STEEL.
- 3. CONSULT WITH PGE REPRESENTATIVE 2 WEEKS BEFORE STARTING MAIN POWER TRENCHING FOR A PRECONSTRUCTION CONFERENCE. INCLUDED IN THIS CONFERENCE WILL BE EXCAVATOR, PGE, TELCO, CATV, AND GAS.
- 4. CONTRACTOR TO LOCATE ALL UNDERGROUND UTILITIES BEFORE TRENCHING. COORDINATE WITH CIVIL.



- A. ALL SHALL BE PERFORMED IN ACCORDANCE WITH ALL APPLICABLE LOCAL, STATE AND NATION CODES.
- B. ALL PLANS ARE CONSIDERED DIAGRAMMATICAL. THEREFORE ALL EQUIPMENT SIZES AND DEVICE LOCATIONS ARE APPROXIMATE AND SUBJECT TO FIELD CONDITIONS AND PRODUCT APPROVAL.
- C. REFER TO SHEETS E1.11 FOR ONE-LINE DIAGRAM, LOAD SUMMARY INFORMATION AND TYPICAL FEEDER SCHEDULE.
- D. REFER TO E2 SERIES SHEETS FOR EXTERIOR BUILDING MOUNTED LIGHT LOCATIONS.
- E. REFER TO SHEET E1.14 FOR LIGHT FIXTURE SCHEDULE.
- G. SITE AND LANDSCAPE LIGHTING SHALL BE PROVIDED WITH DUSK-TIL-DAWN LIGHTING CONTROL AND AUTOMATIC CONTROLS TO REDUCE LIGHT LEVELS BY 30% DURING PERIODS OF LOW ACTIVITY.

Project Name: _____


MINNESOTA
PLACES

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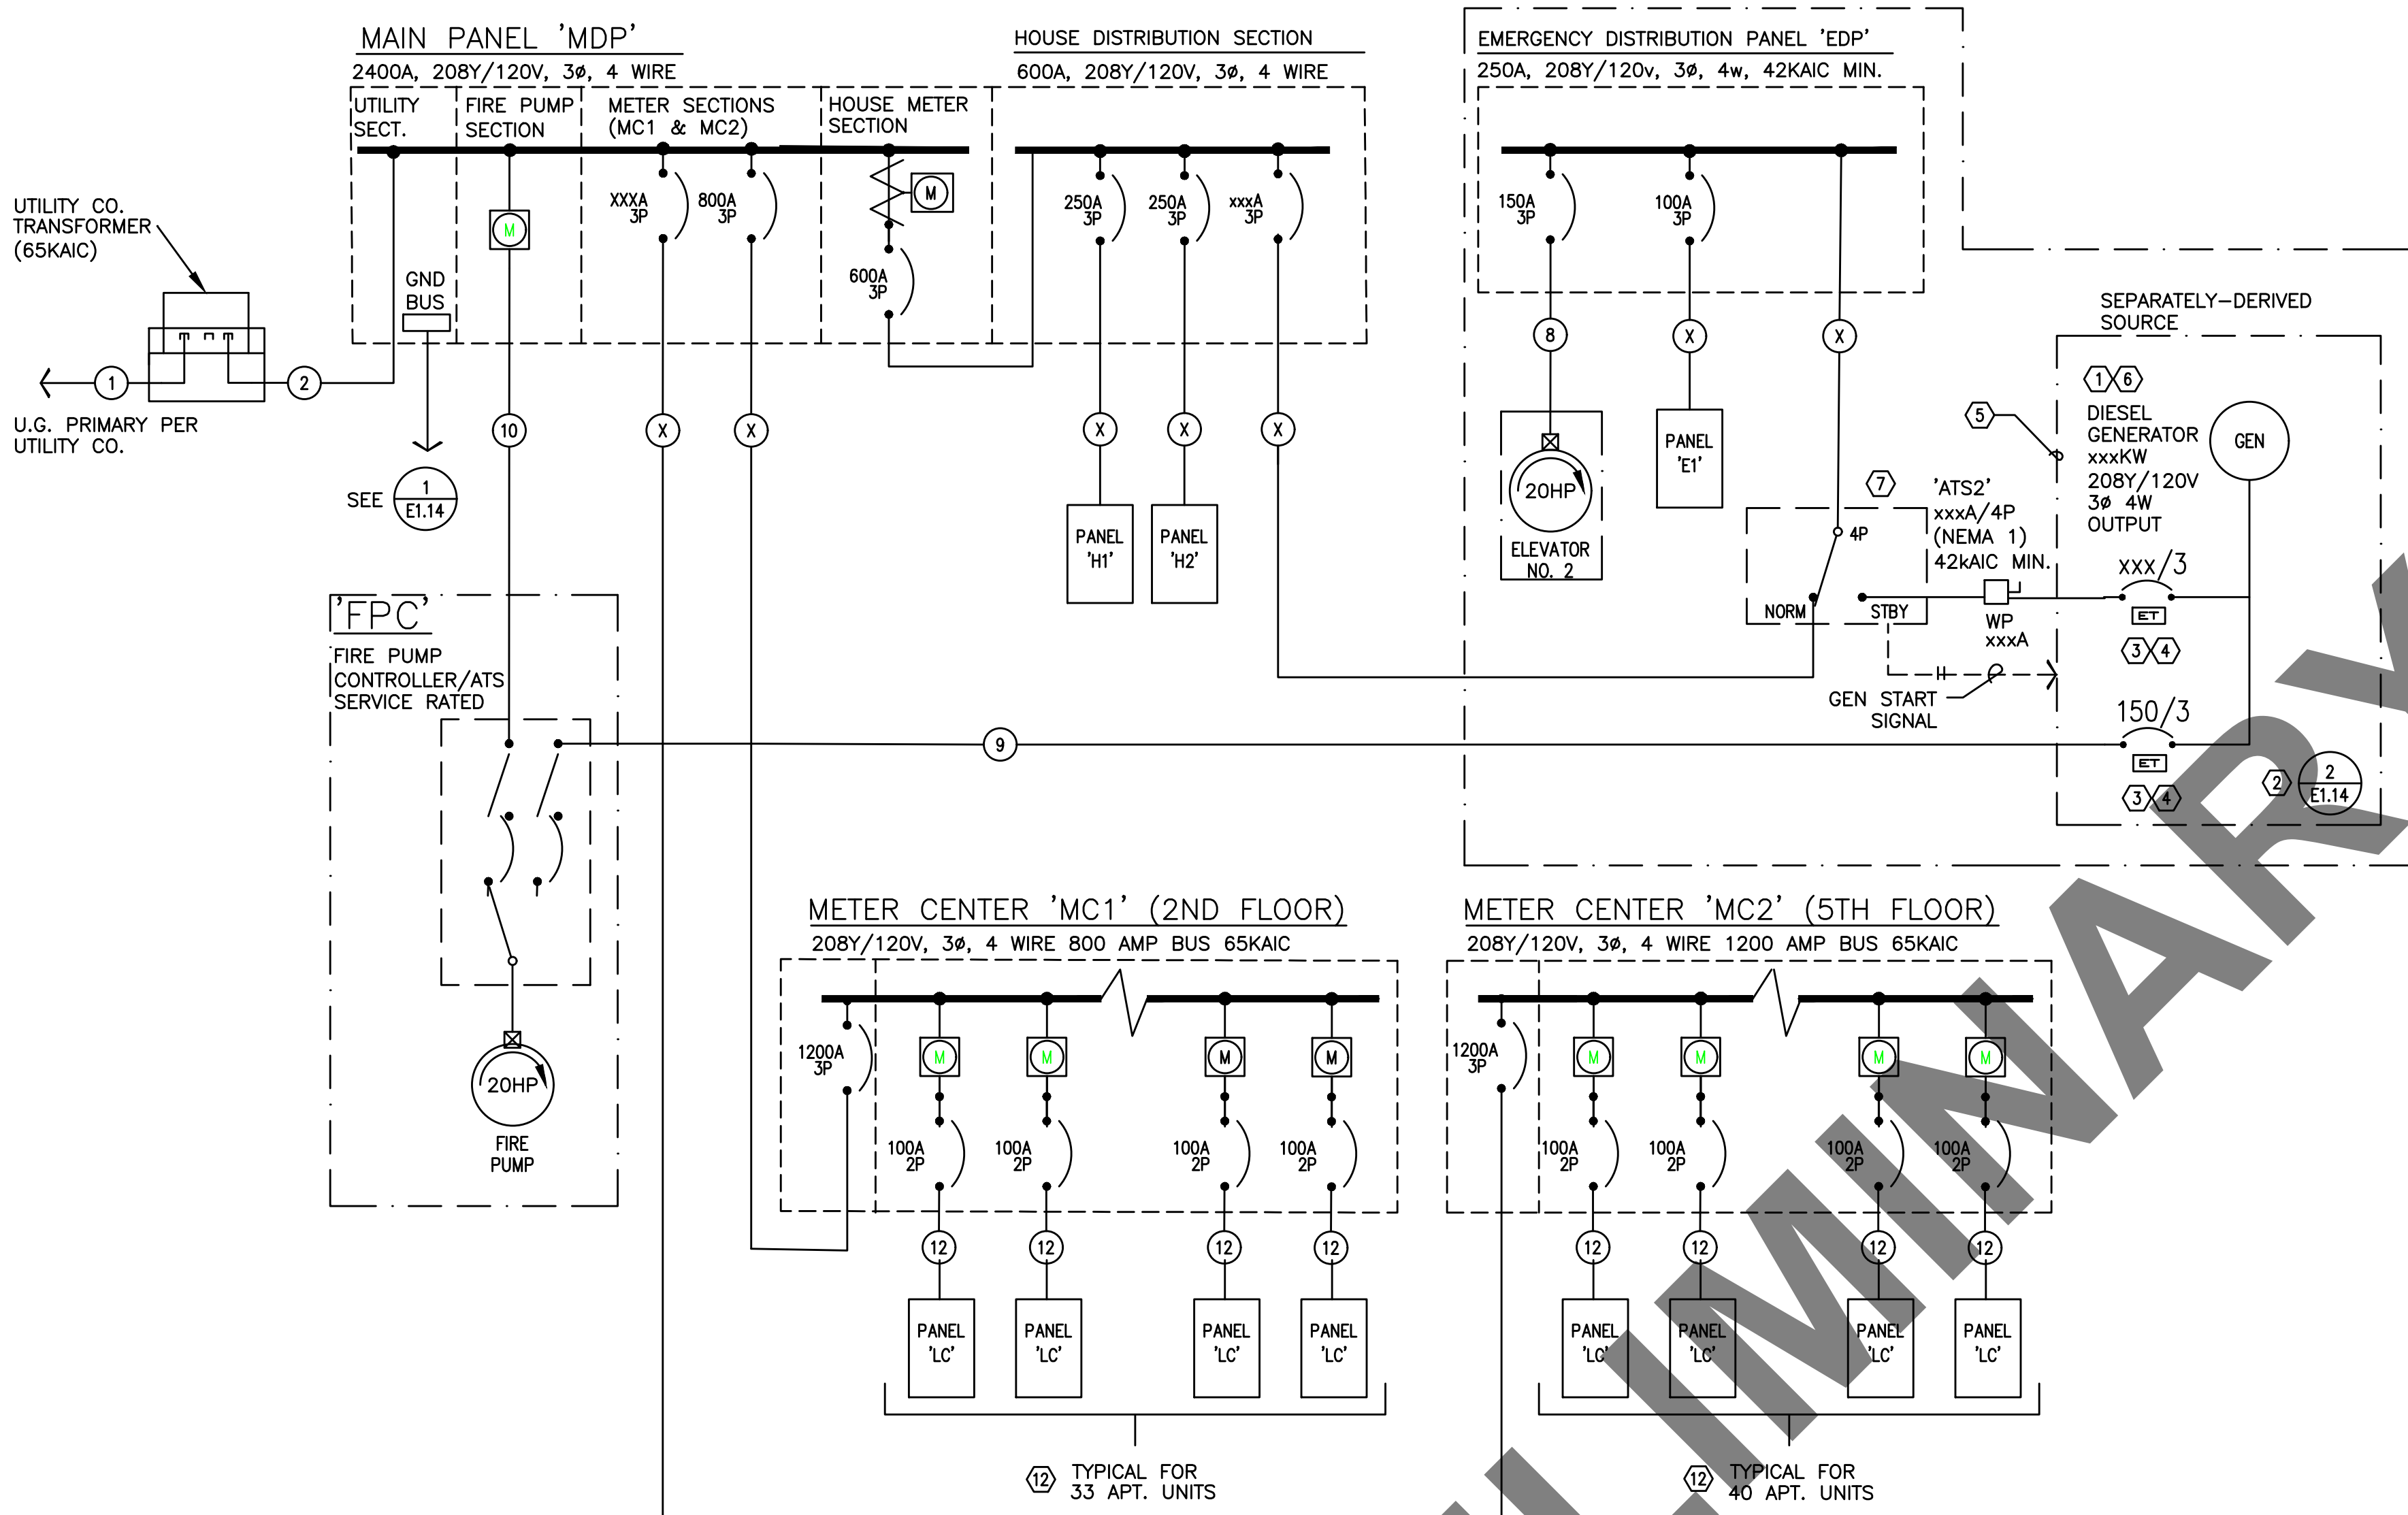
DESIGN
DEVELOPMENT
SET[illegible]

SITE LIGHTING PLAN

E1.02

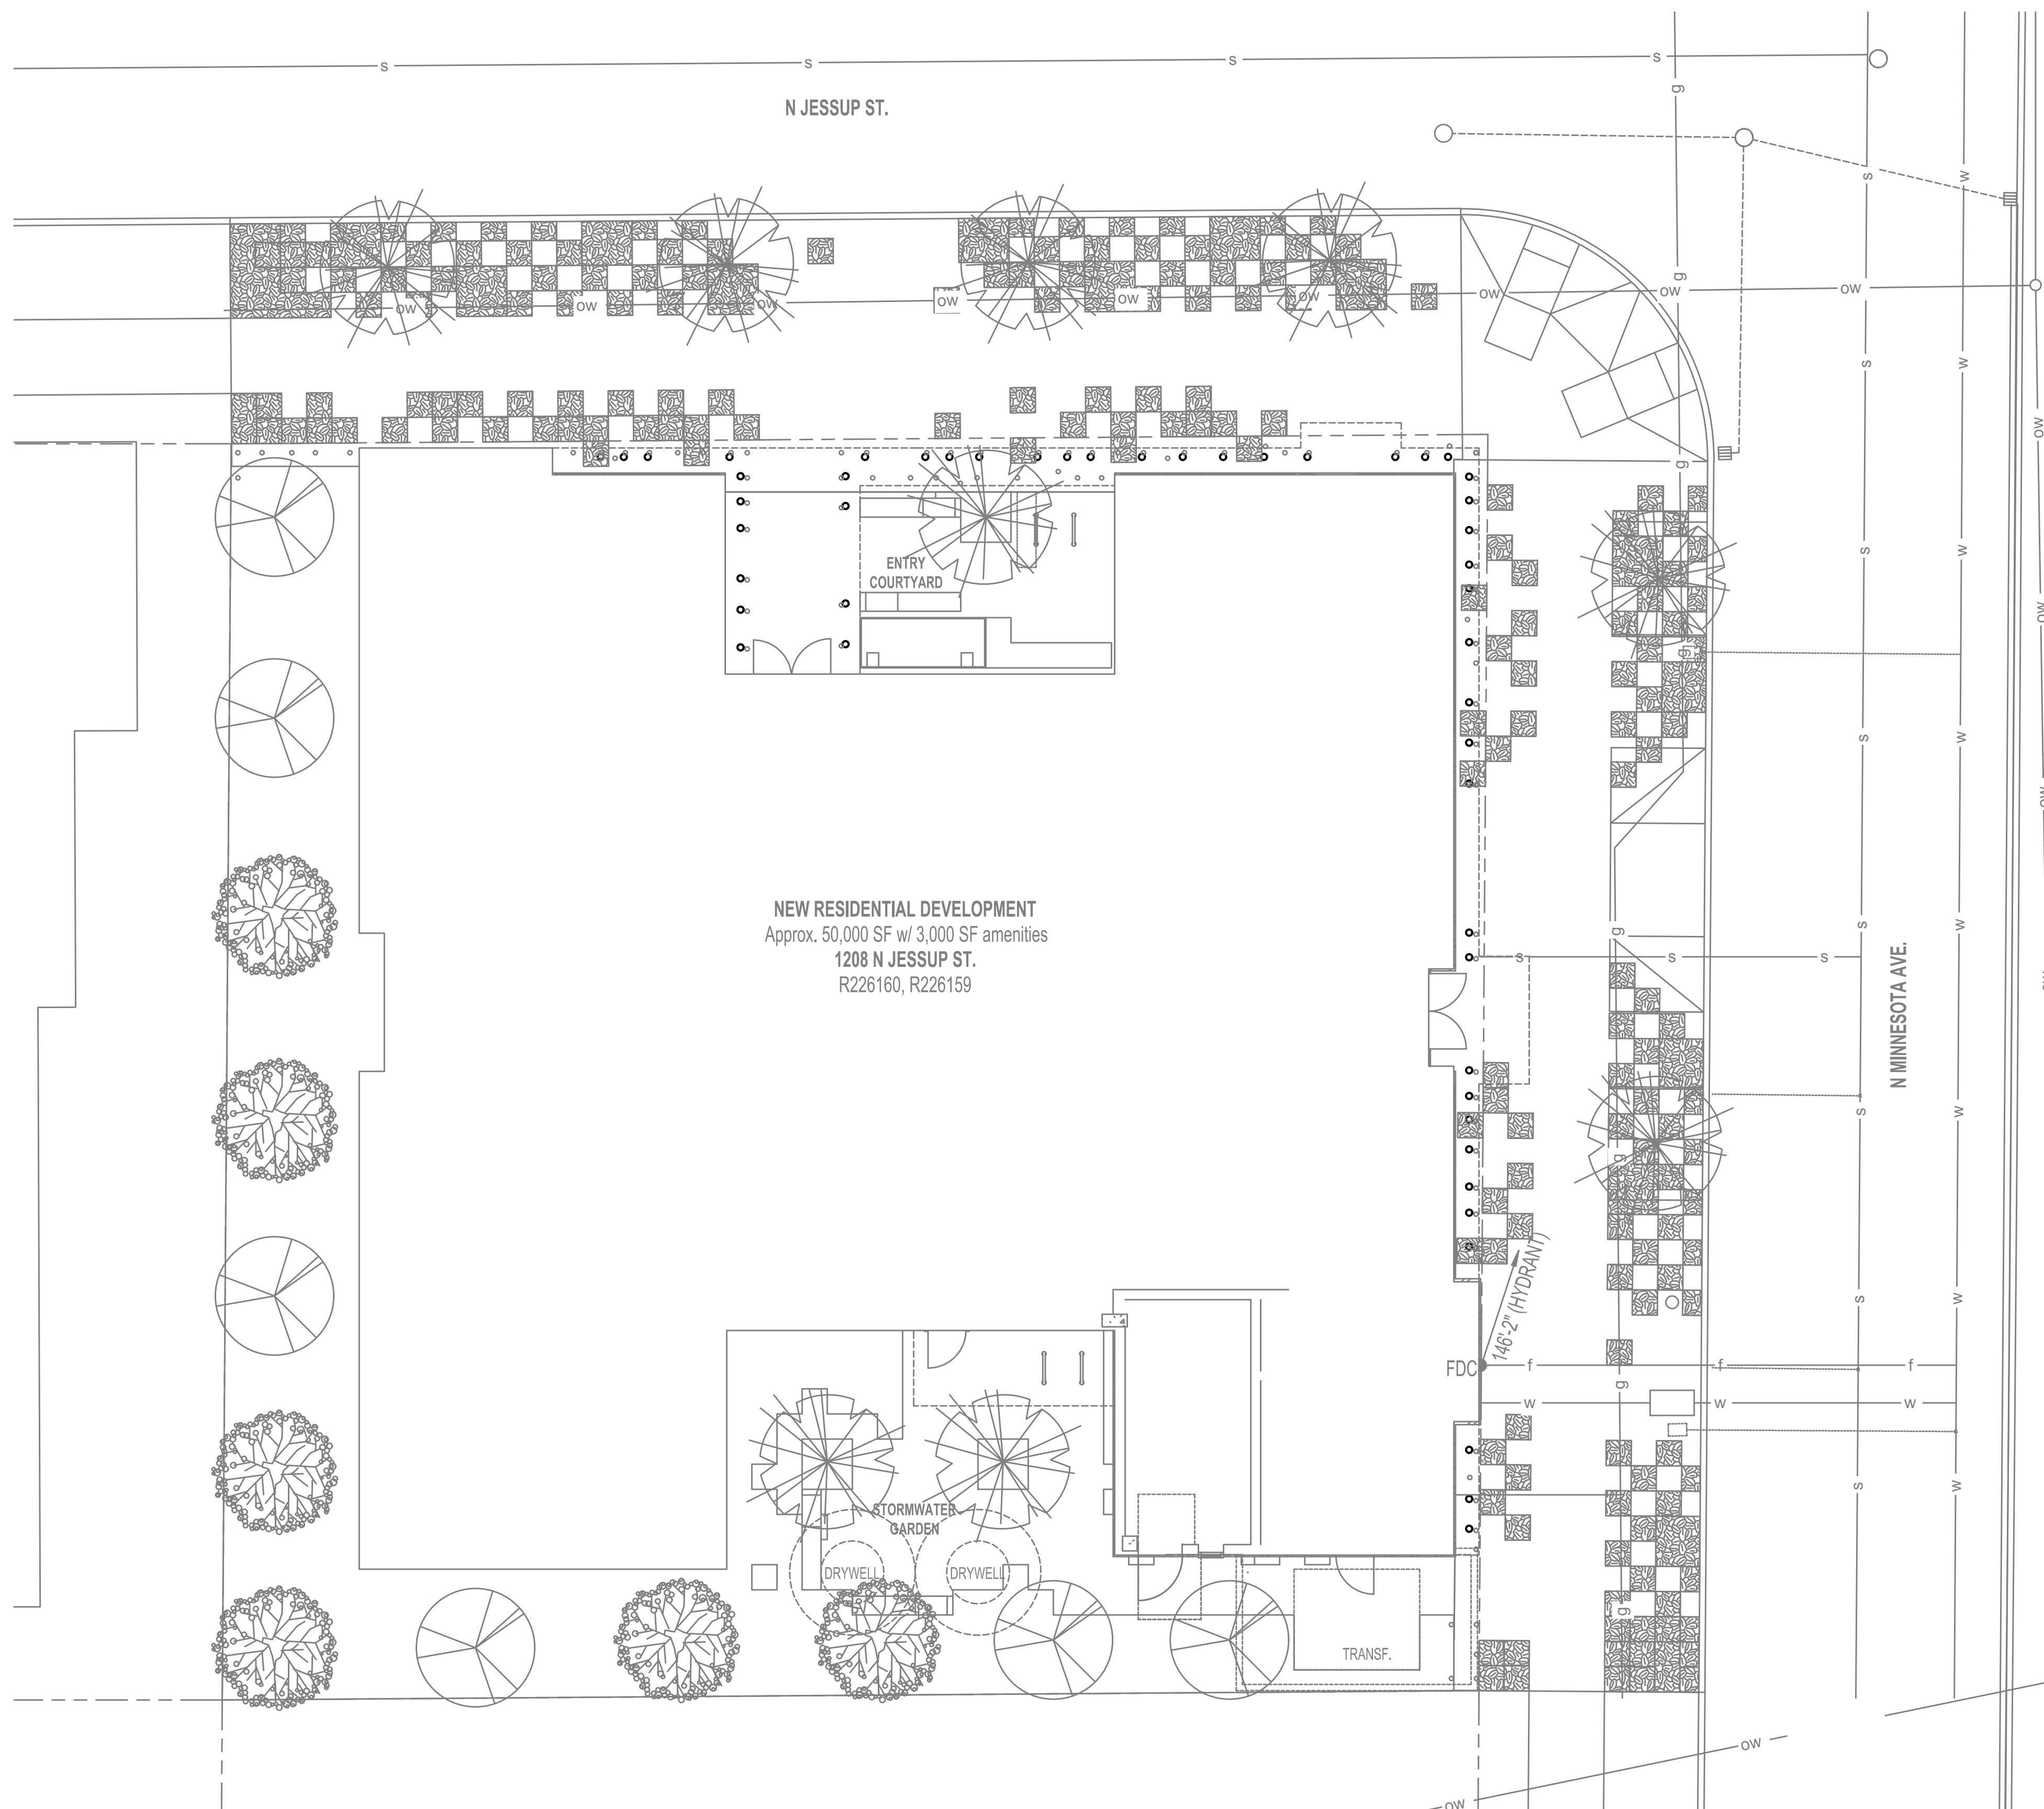

1 SITE LIGHTING PLAN



1 ELECTRIC ONE-LINE DIAGRAM
E1.11 208Y/120V, 3P, 4W

ONE-LINE GENERAL NOTES:

- COORDINATE ALL WORK ASSOCIATED WITH ELECTRIC SERVICE WITH LOCAL UTILITY. PROVIDE ALL CONDUIT & CONDUCTORS, GROUNDING, TRANSFORMER VAULT/PAD, ETC., IN ACCORDANCE WITH SERVING UTILITY REQUIREMENTS.
- COORDINATE METERING REQUIREMENTS WITH UTILITY.
- FOR LOAD CENTER FEEDER LENGTHS GREATER THAN 145'-0" FROM METER CENTER, INCREASE WIRE SIZE ONE SIZE UP FOR VOLTAGE DROP.

ONE-LINE NOTES:

- ESTIMATED GENERATOR STARTING LOAD IS BASED ON THE ELEVATOR & FIRE PUMP MOTORS BEING PROVIDED WITH REDUCED STARTING.
- PROVIDE GROUND FOR SEPARATELY DERIVED SYSTEM PER NEC.
- PROVIDE ELECTRONIC TRIP CIRCUIT BREAKER. EXACT BREAKER TYPE, SETTINGS, ETC. TO BE VERIFIED AND AS DETERMINED BY SELECTIVE COORDINATION STUDY AS PERFORMED BY THE ELECTRICAL DISTRIBUTION EQUIPMENT MANUFACTURER.
- COORDINATE INSTALLATION OF OUTPUT BREAKERS WITH GENERATOR MANUFACTURER TO SELECTIVELY COORDINATE WITH POWER STUDY RECOMMENDATIONS.
- "LIFE SAFETY" BRANCH TO MEET ALL REQUIREMENTS OF NEC 700. CONTRACTOR SHALL BE AWARE THAT MFIA HAS ATTEMPTED TO INDICATE EQUIPMENT AND SIZES THAT WILL SELECTIVELY COORDINATE, BUT WILL NOT BE KNOWN UNTIL ELECTRICAL EQUIPMENT MANUFACTURER PERFORMS THE REQUIRED POWER STUDIES AS SPECIFIED IN 26 05 73. CHANGES MAY BE NECESSARY AFTER THE BID.
- WHERE APPLICABLE, GENERATOR TO BE SIZED TO OPERATE ONLY ONE ELEVATOR AT A TIME. COORDINATE WITH ELEVATOR & GENERATOR PROVIDERS FOR AUTOMATIC SEQUENTIAL OPERATION AS REQUIRED UNDER ASME A17.1, SECTION 2.27.2.1 THROUGH 2.27.2.5.
- THE AUTOMATIC TRANSFER SWITCH FOR THE EMERGENCY PANEL "EDP" SHALL OPERATE SUCH THAT THE EGRESS LOADS ARE SWITCHED TO GENERATOR POWER WITHIN 10 SECONDS AND THE ELEVATOR(S) SWITCHED WITHIN 60 SECONDS OF A POWER FAILURE.

- CONSULT MECHANICAL, PLUMBING AND/OR FIRE ALARM PLANS AND VERIFY EXACT POWER REQUIREMENTS FOR THE FIRE PUMP.
- CONSULT ELEVATOR PROVIDER FOR INSTALLATION AND POWER REQUIREMENTS PRIOR TO ROUGH IN.

Minnesota Apartments Main distribution Center "MDP"							
LOAD:	LIGHTS	RECEPT	HEAT	MISC	EQUIP	MOTORS	LARGEST MOTOR
House Loads (14800sf @ 15w/sf)				222,000			
Elevator 1 (11.1hp/42A)						15,120	
Fire Pump (20hp)						22,350	22,350
Residential Meters				488,000			
SUBTOTAL	0	0	0	710,000	0	37,470	22,350
X-FACTOR	1.25	1 + .5	1	1	1	1	0.25
CODE LOAD:	0	0	0	710,000	0	37,470	5,588
CONN LOAD:	770	KVA					
VOLTS:	208	3ph					
TOTAL CALC:	753	KVA					
CALC AMPS:	2090	AMPS					

RESERVED FOR GENERATOR LOAD SUMMARY

FEEDER SCHEDULE (COPPER)					
NO.	AMPS	CONDUIT	CONDUCTOR		
1	1200	*(5) 4"	BY UTILITY CO.	& (1)	GND
2	1200A	*(3) 4"	ea w/ (4) #600Kcmil	& (1) #3/0	GND
3	225A	2 1/2"	(4) #4/0	& (1) #4	GND
4	100A	1 1/2"	(3) #1	& (1) #8	GND
5	60A	1"	(3) #4	& (1) #10	GND

* PARALLEL FEEDER

MINNESOTA APARTMENTS RESIDENTIAL LOAD SUMMARY- MC2																					
UNIT TYPE:	QTY PER FLOOR								TOTAL	AREA (SF)	LTG/RECEPT (3VA / SF)	SM APPL (1500VA X 2)	LAUNDRY (1500VA)	COOKING (CONNECTED)	MICROWAVE (CONNECTED)	DISHWASHER (CONNECTED)	ELECT DRYER (CONNECTED)	WATER HEATER (CONNECTED)	DISPOSAL (CONNECTED)	MOTORS (CONNECTED)	LARGEST OF: AC/HEATING (CONNECTED)
	LW 1	LW 2	LW 3	LW 4	LW 5	LW 6	LW 7	LW 8													
1 Bedroom					2	2	2	2	8	300	900	3000	1500	8000	1700	0	5400	0	900	0	0
2 Bedroom					4	4	4	4	16	578	1734	3000	1500	8000	1700	0	5400	0	900	0	0
3 Bedroom					4	4	4	4	16	700	2100	3000	1500	8000	1700	0	5400	0	900	0	0
TOTALS:	0	0	0	0	10	10	10	10	40	22848	68544	120000	60000	320000	68000	0	216000	0	36000	0	0
VOLTS:									208	3ph											
TOTAL CONNECTED:									889	KVA											
DEMAND FACTOR:									0.28	Based on Total Number of Electrical Units = 39 (see N.E.C. Article: 220.64)											
TOTAL CALCULATED:									249	KVA											
CALCULATED AMPS:									691	AMPS											
NOTE:																					

Dwelling Unit LOAD CALCULATION			
Project: Minnesota Apartments			
Type 2Bedroom			
Area: 578 square feet(average)			
Minimum Size Feeder (NEC 220.40):			
General lighting load at 3 VA / SF		1,734	VA
Small Appliance load (2 ckts at 1500VA each)		3,000	VA
Laundry Load (1 ckt at 1500VA)		0	VA
Range		8,000	VA
Other Cooking Appliance Load (Microwave Oven)		1,700	VA
Dishwasher Load		0	VA
Electric Dryer Load		0	VA
Electric Water Heater Load		0	VA
Disposal load		900	VA
Other motor loads		0	VA
Total "General Loads"		15,384	VA
First 10 kVA of "general loads" at 100%		10,000	VA
Remainder of "general loads" at 40%		2,134	VA
Net "general load"		12,134	VA
Largest of	5,000	VA of electric space heating (less than 4) at 65%	3,250
or-		VA of electric space heating (4 or more) at 40%	0
		VA of air conditioning/cooling/heat pumps at 100%	0
TOTAL LOAD		15,384	VA
For 120/208-volt, 4-wire, single-phase service or feeder, 15,384 VA / 208 volts =		74	Amps
Therefore, this dwelling unit shall be permitted to be served by a		100	amp service.

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MFA CIRCUIT DIRECTORY										04-May-21
Loader Name LC-2BR (TYPICAL)		mounting		location						
voltage 208/120		phase 1		bus & main (SCCR: 22K)						
service	a/p	no.	L1	L2	no.	a/p	service			
LIGHTS-KITCHEN/LIVING	201(A)	1	*	*	2	201(A)	APPLIANCE CIRCUIT			
LTS & RECEPT - BATH	201/1	3	*	*	4	201(A)	APPLIANCE CIRCUIT			
LTS & RECEPT - LIVING	201(A)	5	*	*	6	201	REFRIGERATOR			
LTS & RECEPT - LIVING (OPT)	201(A)	7	*	*	8	201/1	MICRO/HOOD			
LTS & RECEPT - BEDROOM	201(A)	9	*	*	10	30/2	RANGE (2-BURNER)			
LTS & RECEPT - BEDROOM	201(A)	11	*	*	12	*				
SPARE	201/1	13	*	*	14	201/1	DISPOSAL (OPTIONAL)			
SMART PANEL (OPTIONAL)	201/1	15	*	*	16	201/1	SPARE			
SPARE	201/1	17	*	*	18	201/1	SPARE			
SPARE	201/1	19	*	20	201/1	SPARE				
BLANK	----	21	*	*	22	----	BLANK			
BLANK	----	23	*	24	----	BLANK				
BLANK	----	25	*	*	26	----	BLANK			
BLANK	----	27	*	*	28	----	BLANK			
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NOTES:

1. (A) DENOTES: ARC-FAULT INTERRUPTER CIRCUIT BREAKER. INSTALL PER NEC 210.12

2. LOADS FOR THIS PANEL ARE INDICATED ON THE "DWELLING UNIT LOAD CALCULATION".

3. BREAKER & WIRE SHALL BE SIZED FOR EQUIPMENT INSTALLED.

4. (G) DENOTES GFCCI RATED BREAKER.

DESIGN DEVELOPMENT SET

ORIGINAL SHEET SIZE: 22" x 34"
HALF SIZE: 11" x 17"

E1.12

E1.12

LIGHTING FIXTURE LIST					
TYPE	LAMP	MANUFACTURER	CATALOG NUMBER	DESCRIPTION	OPTIONS
A1 A1E	LED 3000K 2300LM 20W	NEO RAY LIGHTING (OR APPROVED OTHER)	S124DWC575D SERIES	TYPE :4FT WALL BRACKET MOUNTING :SURFACE (+7"-0" MIN) HOUSING :STEEL LENS/REFL :ACRYLIC VOLTAGE :MVOLT BALLAST :LED DRIVER	FINISH PER ARCHITECT A1E SHALL HAVE BATTERY BACKUP STAIRWELLS
A2	LED 3000K 3000LM 31W	LITHONIA LIGHTING (OR APPROVED OTHER)	ZL1N-L46 SERIES	TYPE :4FT GENERAL PURPOSE STRIP MOUNTING :SURFACE HOUSING :STEEL LENS/REFL :ACRYLIC VOLTAGE :MVOLT BALLAST :LED DRIVER	 STORAGE SPACE
B1 B1E	LED 3000K 2300LM 20W	NEO RAY LIGHTING (OR APPROVED OTHER)	S124DSC575D SERIES	TYPE :4FT LINEAR DIRECT MOUNTING :SURFACE HOUSING :STEEL LENS/REFL :ACRYLIC VOLTAGE :MVOLT BALLAST :LED DRIVER	FINISH PER ARCHITECT B1E SHALL HAVE BATTERY BACKUP BIKE & EQUIPMENT ROOMS
C1 C1E	LED 3000K 1075LM 9W	USAI LIGHTING (OR APPROVED OTHER)	P4RDF SERIES	TYPE :4.5" DIA DOWNLIGHT MOUNTING :RECESSED HOUSING :STEEL LENS/REFL :NA VOLTAGE :MVOLT BALLAST :LED DRIVER	FINISH PER ARCHITECT C1E SHALL HAVE BATTERY BACKUP LOBBY, CORRIDORS
C2 C2E	LED 3000K 1175LM 9W	USAI LIGHTING (OR APPROVED OTHER)	P3RD SERIES	TYPE :3" DIA DOWNLIGHT MOUNTING :RECESSED HOUSING :STEEL LENS/REFL :NA VOLTAGE :MVOLT BALLAST :LED DRIVER	FINISH PER ARCHITECT C2E SHALL HAVE BATTERY BACKUP LOBBIES
D1	LED 3000K 1790LM 34W	QUOIZEL LIGHTING (OR APPROVED OTHER)	PCOH282401SERIES	TYPE :24" DIA PENDANT MOUNTING :SUSPENDED HOUSING :STEEL LENS/REFL :ACRYLIC VOLTAGE :MVOLT BALLAST :LED DRIVER	FINISH PER ARCHITECT VERIFY MOUNTING HEIGHT MAIN LOBBY
S1	LED 3000K 1000LM 14W	LIGHTOLIER LIGHTING (OR APPROVED OTHER)	S7R SERIES	TYPE :7" DIA. DOWNLIGHT MOUNTING :SURFACE HOUSING :STEEL LENS/REFL :ACRYLIC VOLTAGE :MVOLT BALLAST :LED DRIVER	FINISH PER ARCHITECT UL LISTED WET LOCATION BUILDING EXTERIOR
S2	LED 3000K 1000LM 15W	ALCON LIGHTING (OR APPROVED OTHER)	11235 DIR-15 SERIES	TYPE :5" DIA EXTERIOR CYLINDER MOUNTING :SURFACE HOUSING :ALUMINUM LENS/REFL :CLEAR TEMPERED GLASS VOLTAGE :MVOLT BALLAST :LED DRIVER	FINISH PER ARCHITECT 60 DEGREE WIDE FLOOD UL LISTED WET LOCATION ENTRY CANOPY
S3	LED 3000K 2130LM 20W	STONCO LIGHTING (OR APPROVED OTHER)	LPW16 SERIES	TYPE :EXTERIOR WALL PACK MOUNTING :SURFACE (ABOVE DOOR) HOUSING :ALUMINUM LENS/REFL :ACRYLIC VOLTAGE :MVOLT BALLAST :LED DRIVER	TYPE III DISTRIBUTION BUILDING SERVICE ENTRANCE
U1	LED 2700K 1000LM 15W	DESIGN CLASSICS (OR APPROVED OTHER)	DFR615-H-927-WH	TYPE :6" DIA CEILING LIGHT MOUNTING :SURFACE HOUSING :ALUMINUM LENS/REFL :ACRYLIC VOLTAGE :120V BALLAST :LED DRIVER (0-10 DIMMING)	 UL LISTED WET LOCATION UNIT KITCHEN, BATH
U2	LED 3000K 1600LM 20W	KUZCO LIGHTING (OR APPROVED OTHER)	FM3511 SERIES	TYPE :11" DIA CEILING LIGHT MOUNTING :SURFACE HOUSING :STEEL LENS/REFL :FROSTED GLASS VOLTAGE :120V BALLAST :LED DRIVER (0-10 DIMMING)	FINISH PER ARCHITECT UNIT BATHROOM
U3	LED 3000K 1600LM 20W	KUZCO LIGHTING (OR APPROVED OTHER)	VL62220 SERIES	TYPE :20" VANITY BAR MOUNTING :SURFACE (=6" ABOVE DOOR) HOUSING :STEEL LENS/REFL :ACRYLIC VOLTAGE :120V BALLAST :LED DRIVER (0-10 DIMMING)	FINISH PER ARCHITECT UNIT BATHROOM
U4	LED 3000K 800LM 12W	KUZCO LIGHTING (OR APPROVED OTHER)	EW3105 SERIES	TYPE :EXTENSION SCORCE MOUNTING :SURFACE (=5FT MIN) HOUSING :ALUMINUM LENS/REFL :TEMPERED GLASS VOLTAGE :120V BALLAST :LED DRIVER	FINISH PER ARCHITECT UNIT ENTRIES, PATIOS
X1 X2	LED (GREEN LETTERS) (1.5W)	LITHONIA DMF LIGHTING (OR APPROVED OTHER)	LE EL N SERIES DLED500EM-G	TYPE :EXIT SIGN MOUNTING :UNIVERSAL HOUSING :DIE-CAST ALUMINUM LENS/REFL :SINGLE FACE/DUAL FACE VOLTAGE :MVOLT BALLAST :NICKLE CADMIUM BATTERY	X1= SINGLE SIDE X2= DOUBLE SIDE


MECHANICAL EQUIPMENT SCHEDULE										
NO.	EQUIPMENT NAME	HP/KW	VOLTS	PH	AMPS	CONDUIT	WIRE	GND	CIRCUIT	
EF-1	EXHAUST FAN NO.1	11.0W	120	1		1/2"	#12	#12	SEE TYP. UNITS E3.02	
EF-2	EXHAUST FAN NO.2	11.0W	120	1		1/2"	#12	#12	HP-10 (PC)	
SF-1	SUPPLY FAN NO.1	16.0W	120	1		1/2"	#12	#12	SEE POWER PLANS	
EH-1	WALL HEATER NO.1	1.5KW	240	1		1/2"	#12	#12	SEE POWER PLANS	
EH-2	WALL HEATER NO.2	500W	120	1		1/2"	#12	#12	H1-8	
EH-3	WALL HEATER NO.3	1.5KW	240	1		1/2"	#12	#12	H1-35,37	
B-1	BOILER NO.1 (GAS)		120	1		1/2"	#12	#12	H1-20 (PC)	
B-2	BOILER NO.2 (GAS)		120	1		1/2"	#12	#12	H1-20 (PC)	
P-1	PUMP NO. 1	336W	120	1		1/2"	#12	#12	H1-20 (PC)	
RP-1	RECIRC PUMP NO.1	1/2HP	120	1		1/2"	#12	#12	H1-24	
RP-2	RECIRC PUMP NO.2	1/2HP	120	1		1/2"	#12	#12	H1-26	
SF-1	SUPPLY FAN NO.1		120	1		1/2"	#12	#12	SEE POWER PLANS	
SP-1	SUMP PUMP NO.1	2x 3/4HP	208	3		1/2"	#12	#12	H1-28,30,32	
WH-1	WATER HEATER NO.1 (GAS)		120	1		1/2"	#12	#12	H1-22 (PC)	
WH-2	WATER HEATER NO.2 (GAS)		120	1		1/2"	#12	#12	H1-22 (PC)	

GENERAL LIGHTING NOTES:


- A. WHEREVER POSSIBLE, SELECTED LIGHT FIXTURES SHALL HAVE ENERGY EFFICIENT LAMPS, BALLASTS DRIVERS AND/OR HAVE ENERGY COMPLIANT RATINGS SUCH AS DLC, ENERGY STAR, ETC.
- B. VERIFY ALL FIXTURE FINISHES WITH ARCHITECT PRIOR TO BID.
- C. VERIFY ALL FIXTURE LOCATIONS AND MOUNTING HEIGHTS WITH ARCHITECT PRIOR TO REVISIONS.
- D. ALL LIGHTING SHALL BE 3000 KELVIN UNLESS OTHERWISE NOTED.
- E. ALL PRODUCT SUBSTITUTIONS AND EQUIPMENT ENGINEERING SHALL BE SUBMITTED PRIOR TO CONSTRUCTION PHASE, SHALL MEET DESIGN INTENT AND ARE SUBJECT TO OWNER APPROVAL.
- F. EGRESS LIGHTING SHALL BE PROVIDED TO MEET MINIMUM LIGHT LEVELS AS DESCRIBED PER OREGON STRUCTURAL CODE SECTION 1003.3.
- G. BUILDING EXTERIOR LIGHTING SHALL BE CONTROLLED BY PHOTOCELL, EITHER INTEGRAL OR REMOTE, OR BY TIME CLOCK FOR DUSK-TILL-DAWN OPERATION.
- H. LIGHTING FIXTURES DESIGNATED AS NIGHT LIGHTS (N.L.) AND SMOKE DETECTOR LIGHTS SHALL BE ON 24/7.
- I. CORRIDOR LIGHTS SHALL BE PROVIDED WITH OCCUPANCY SENSOR(S), EITHER INTEGRAL OR REMOTE, TO PROVIDE 50% LIGHT REDUCTION DURING PERIODS OF INACTIVITY. ONCE ACTIVATED, LIGHTS ARE TO REMAIN AT 100% OUTPUT FOR A MINIMUM OF 20 MINUTES.
- K. DESIGN INTENT FOR CORRIDOR LIGHTING SHALL BE SUCH THAT LIGHTS INDICATED AS NIGHT LIGHTS (N.L.), SHALL BE ON 24/7. ALL OTHER LIGHT FIXTURES TO BE CIRCUITED VIA TIME CLOCK TO REDUCE CORRIDOR LIGHTING BY 50% DURING PERIODS OF LOW ACTIVITY (IE. 12AM - 4AM OR AS DIRECTED BY OWNER).

GENERAL EQUIPMENT NOTES:


- A. CONTRACTOR/DESIGNER SHALL VERIFY ALL MECHANICAL EQUIPMENT CONNECTION LOAD REQUIREMENTS WITH THE MECHANICAL EQUIPMENT PROVIDER PRIOR TO ROUGH IN.
- B. MECHANICAL EQUIPMENT SIZES SHOWN IN THE MECHANICAL SCHEDULE ABOVE ARE FOR REFERENCE ONLY AND MAY NOT REFLECT THE ACTUAL EQUIPMENT TO BE INSTALLED.
- C. INDOOR & OUTDOOR COMPONENTS OF THE MINI-SPLIT SYSTEMS ARE INTERCONNECTED. CONSULT WITH AND COORDINATE THE ELECTRICAL REQUIREMENTS AND EXACT LOCATIONS WITH THE HVAC EQUIPMENT INSTALLER PRIOR TO ROUGH IN.
- D. REFER TO TYPICAL UNIT PLAN LOAD CENTER SCHEDULES ON THIS SHEET FOR CIRCUITING INFORMATION.

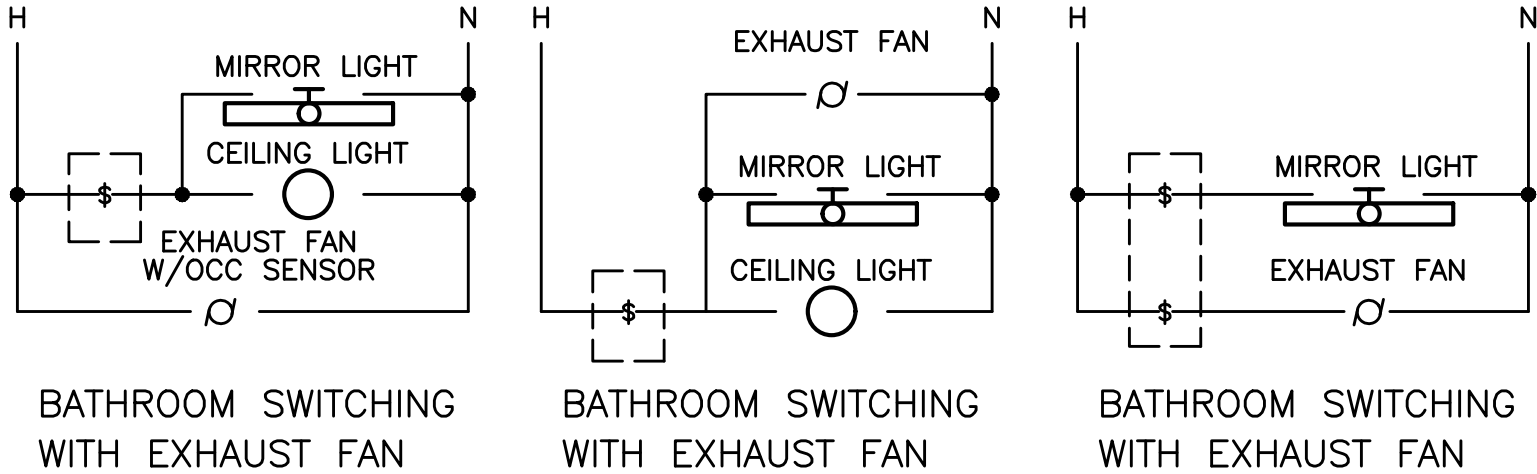


1 BATHROOM SWITCHING DIAGRAM - TYPICAL
E1.13 NO SCALE

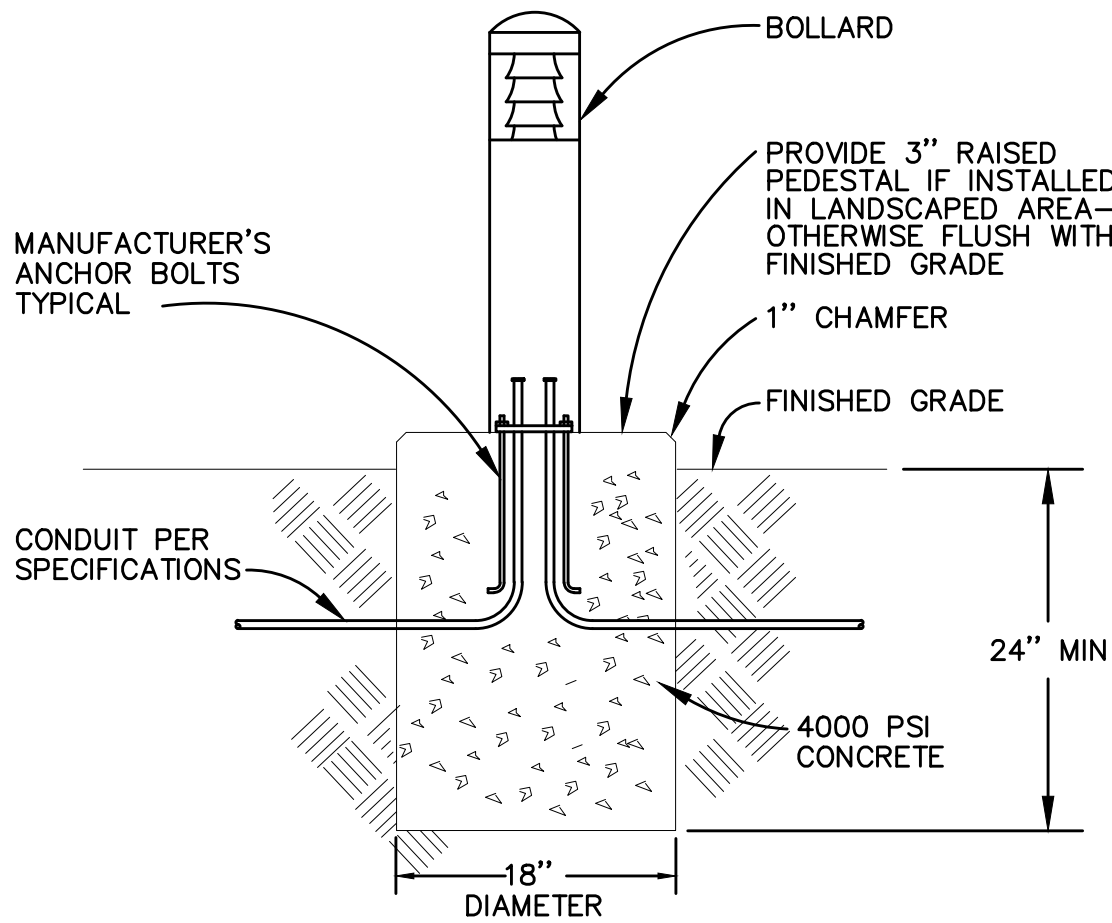


2 BOLLARD LIGHT DETAIL
E1.13 NO SCALE

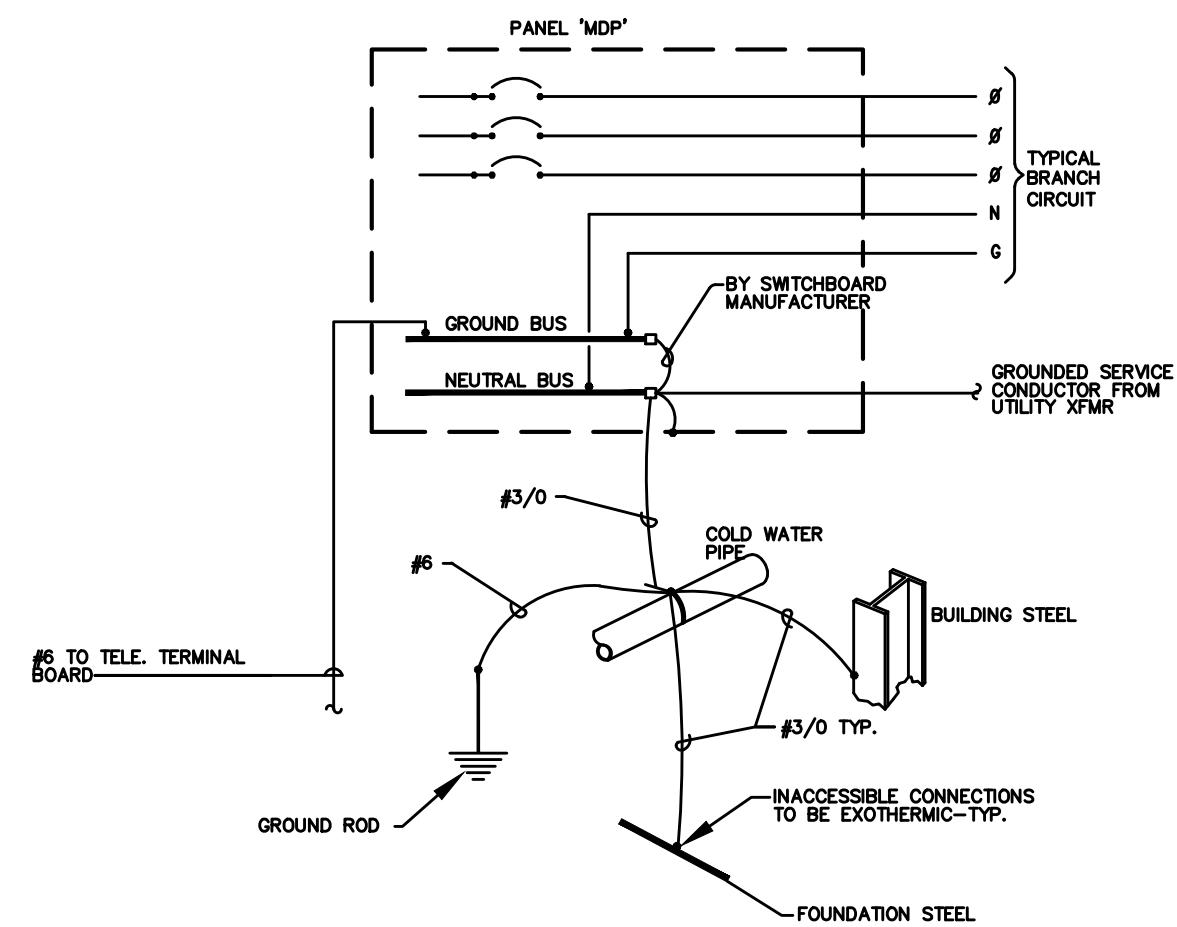

1 GROUNDING/BONDING DIAGRAM
E1.14 208Y/120V, 3Ø, 4 WIRE

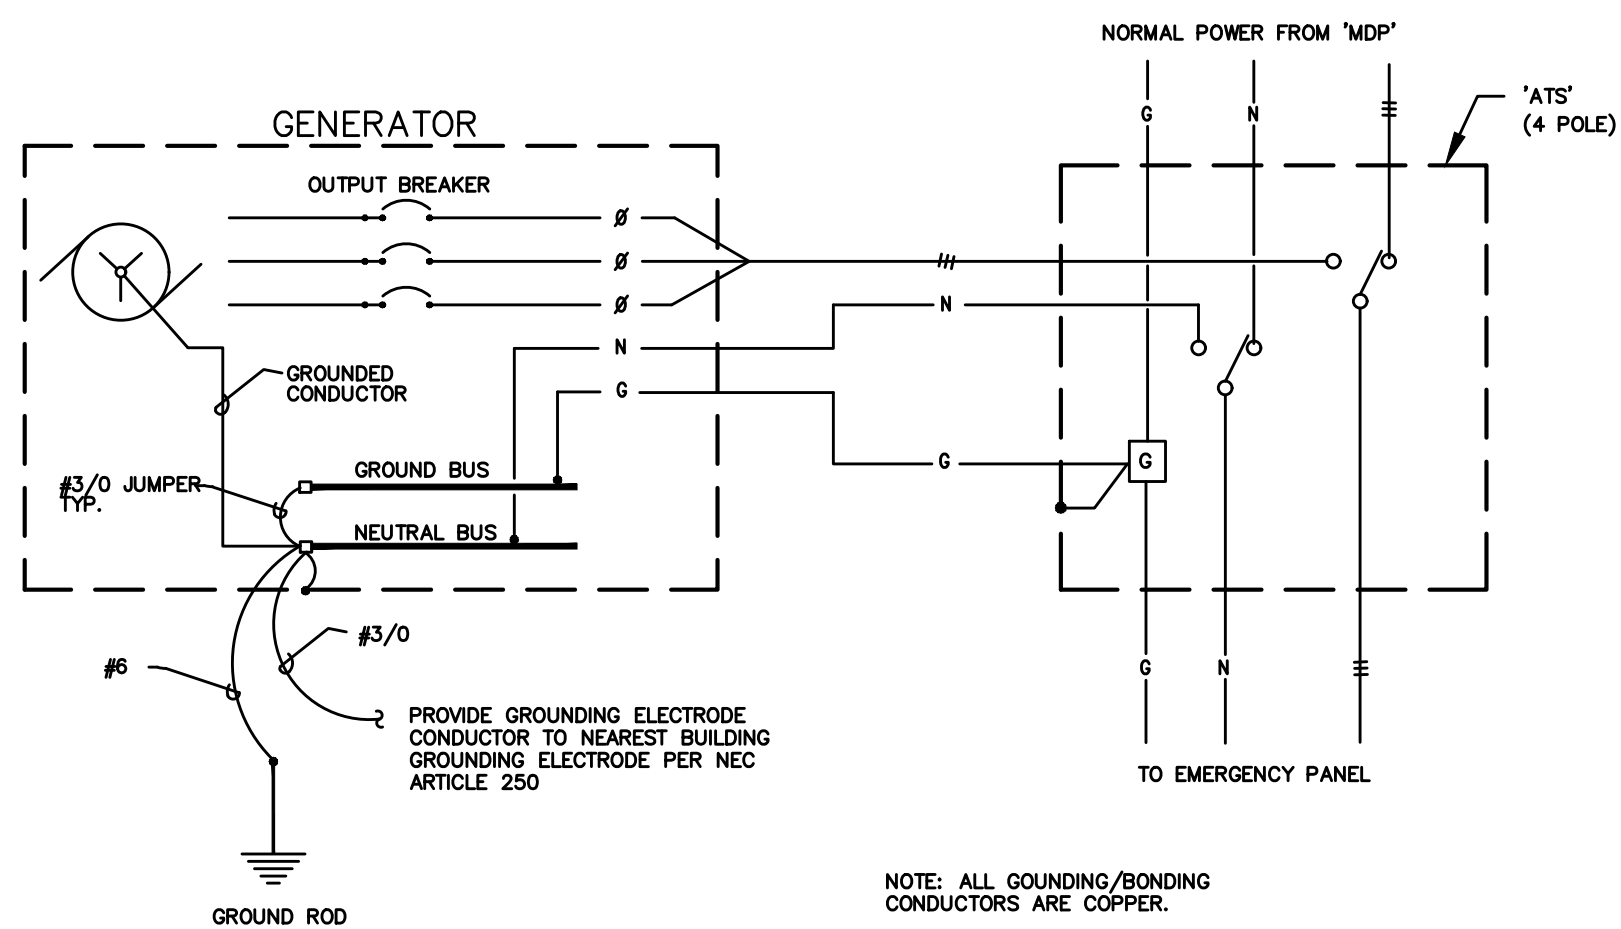


2 GENERATOR - ELECTRICAL GROUNDING/BONDING DETAIL
E1.14 NO SCALE

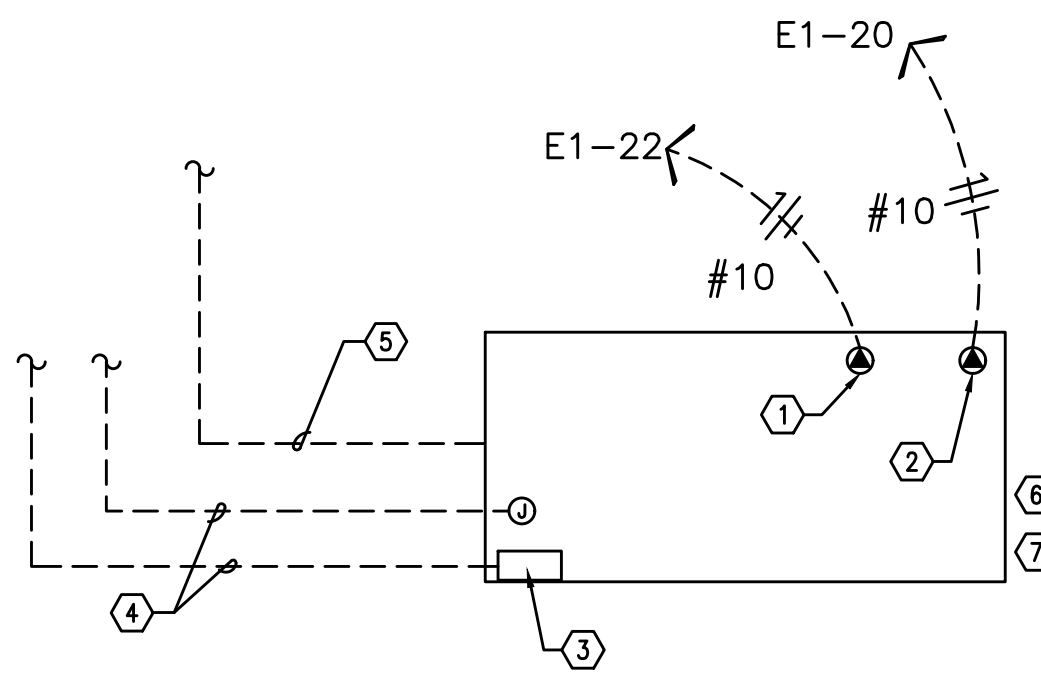


3 GENERATOR CIRCUITING DETAIL
E1.14 NO SCALE

NOTES:


- 120V GENERATOR BLOCK HEATER. SEE PANEL E1.
- 120V GENERATOR BATTERY CHARGER. SEE PANEL E1.
- GENERATOR OUTPUT BREAKER AND CONTROL SECTION. SEE PANEL E1.
- POWER AND CONTROL TO TRANSFER SWITCH AND REMOTE ANNUNCIATOR. SEE ONE-LINE DIAGRAM ON SHEET E1.10.
- TO AUTOMATIC TRANSFER SWITCH. SEE E1.10.
- DIESEL GENERATOR TO BE PROVIDED WITH DOUBLE-WALL FUEL TANK AND SPILL CONTAINMENT PER CITY OF PORTLAND REQUIREMENTS.
- DIESEL GENERATOR TANK SHALL DOUBLE WALLED AND BE EQUIPPED WITH OVERFILL PROTECTION (AUTO SHUTOFF), 5 GALLON INFILL SPILL BUCKET WITH DRAIN BACK, 12FT ABOVE GRADE TANK FUME VENTING AND ONSITE PRESSURE TESTING PER CITY REQUIREMENTS.

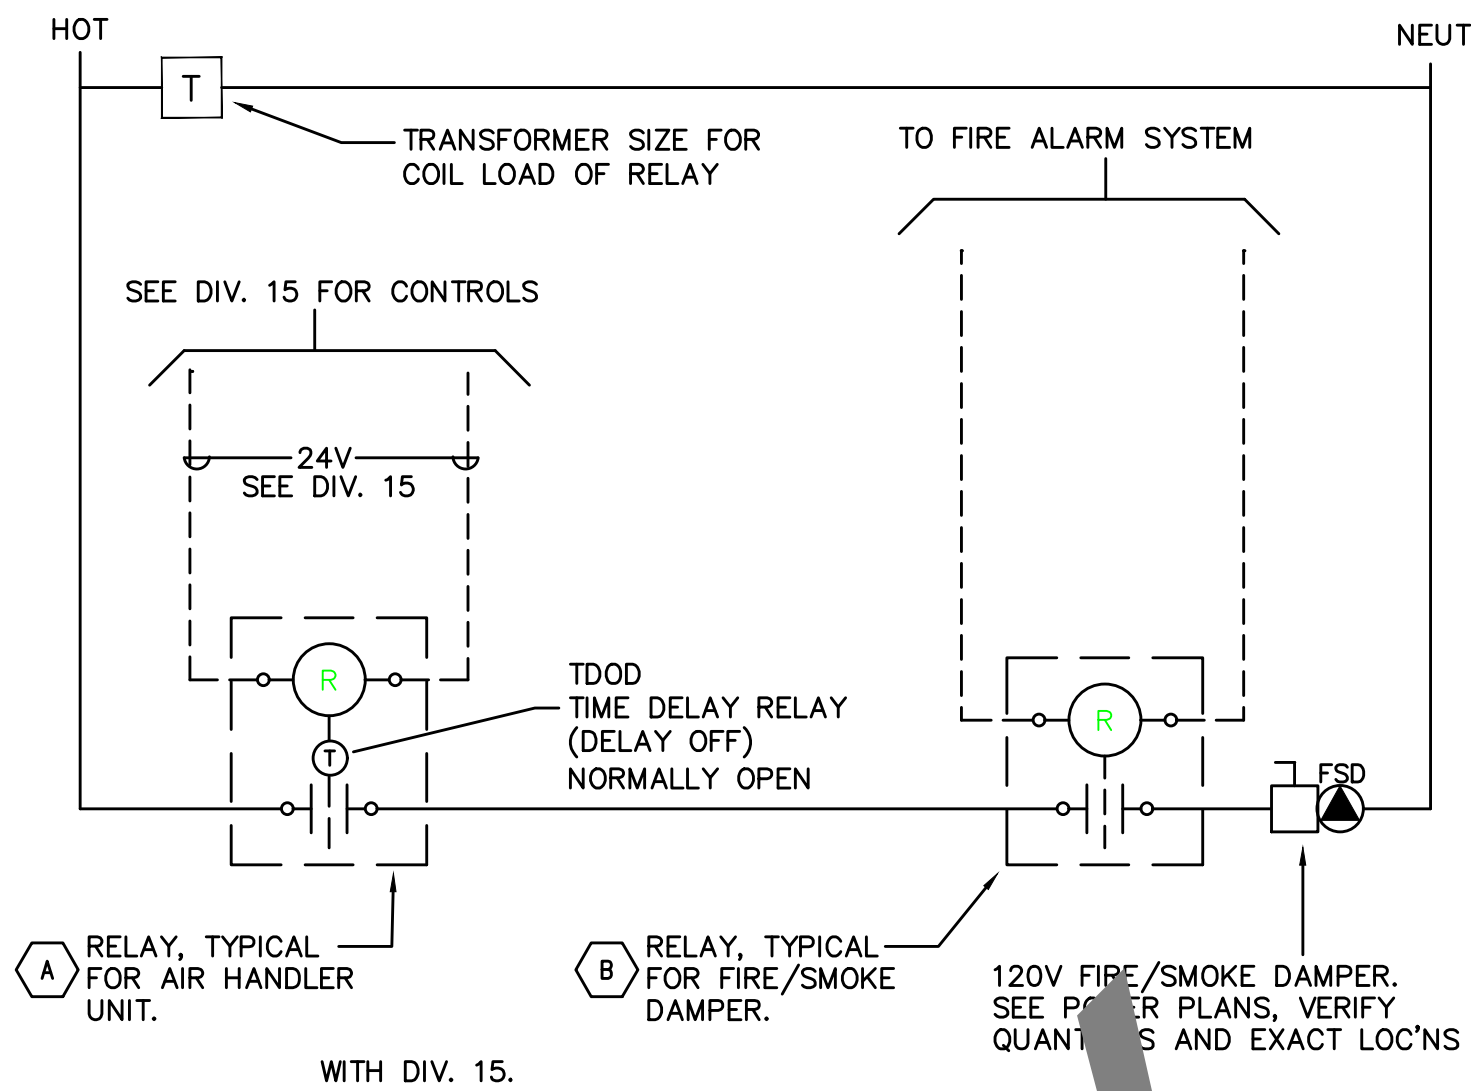

5 SMOKE/FIRE DAMPER CONTROL DIAGRAM
E1.14 NO SCALE

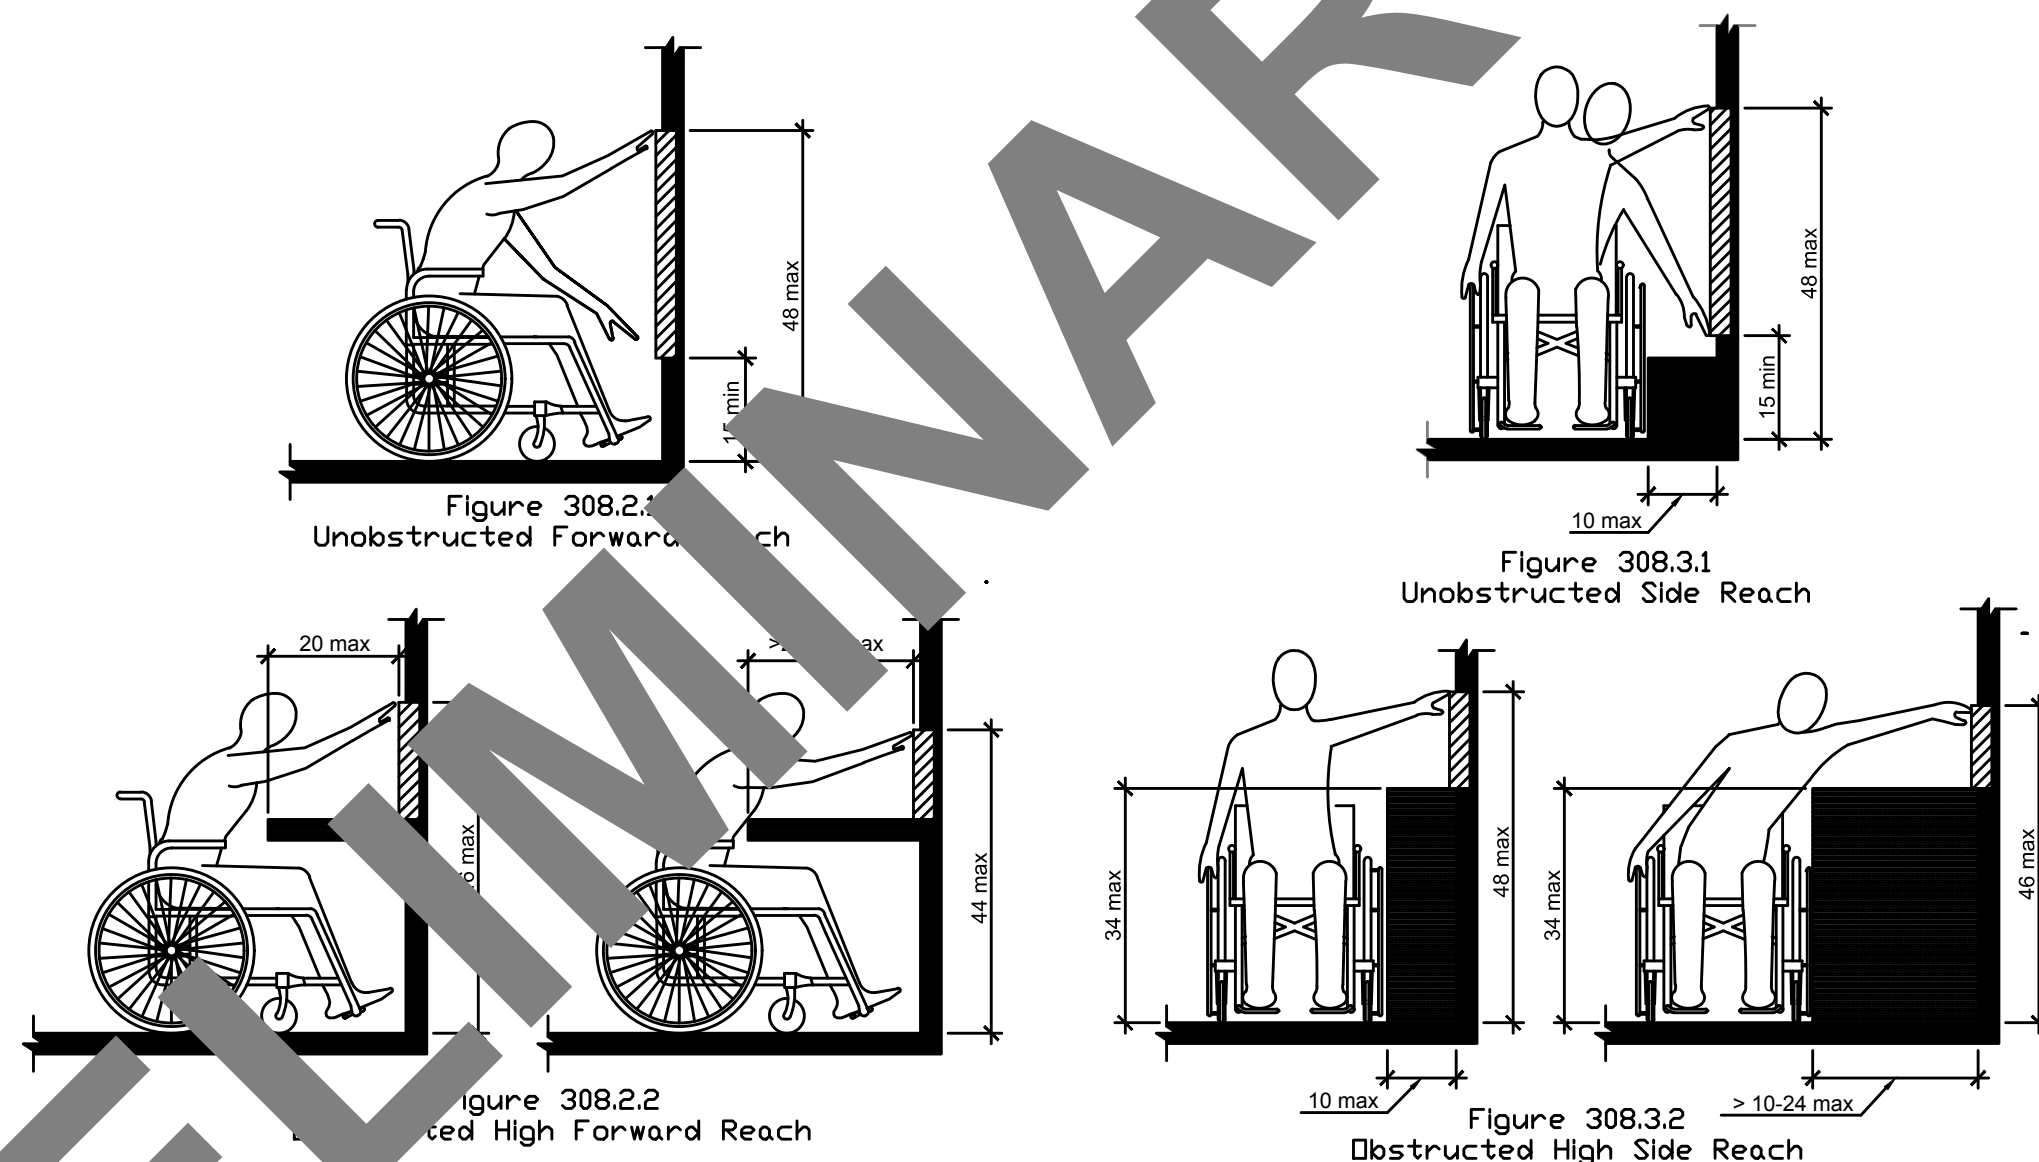

6 ADA REACH REQUIREMENTS
E1.14 N.T.S.

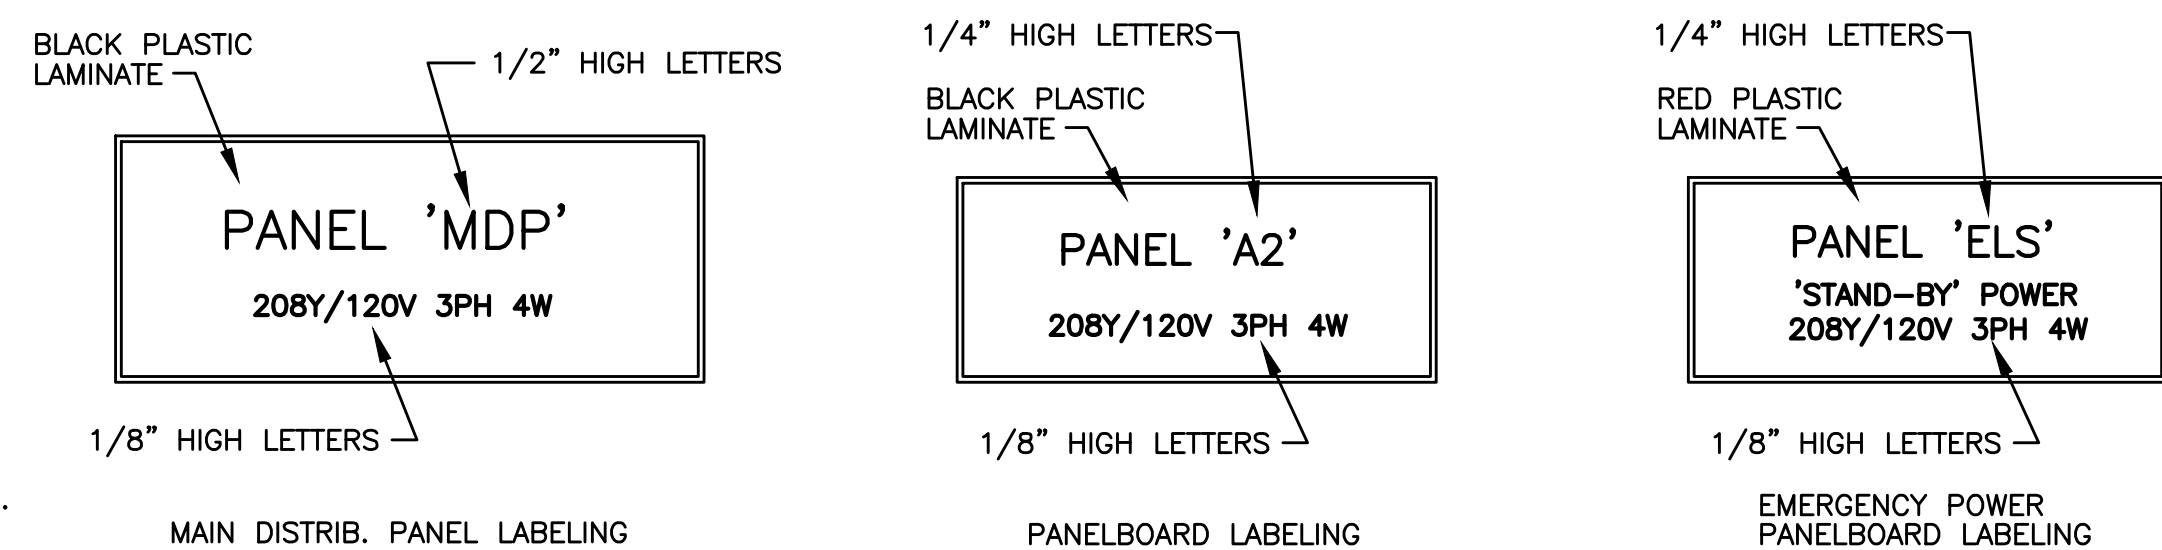

7 SWITCHBOARD/PANEL LABELING DETAIL
E1.14 NO SCALE

NOTE: ALL LETTERS ARE ENGRAVED WHITE

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Project Name:

MINNESOTA
PLACES

1208 N. JESSUP &
5627 N. MINNESOTA
(R226159, R226160)

PRELIMINARY
NOT FOR
CONSTRUCTION

DESIGN
DEVELOPMENT
SET

Issued:

PRELIMINARY 4.27.2021

Job #: 2020

ORIGINAL SHEET SIZE: 22" x 34"
HALF SIZE: 11" x 17"

BASEMENT
LEVEL
LIGHTING PLAN

Drawing Number


E2.00

GENERAL LIGHTING NOTES:


- ELECTRICAL DRAWINGS ARE DIAGRAMMATICAL AND MAY NOT ACCURATELY REFLECT ACTUAL CONSTRUCTION CONDITIONS. THE ELECTRICAL CONTRACTOR SHALL BE RESPONSIBLE FOR COORDINATING THE INSTALLATION OF ALL ELECTRICAL EQUIPMENT, WITH ALL TRADES PRIOR TO AND DURING CONSTRUCTION.
- THE ELECTRICAL CONTRACTOR SHALL REFER TO THE ARCHITECTURAL & INTERIOR DESIGN DRAWINGS FOR EXACT LOCATIONS, MOUNTING HEIGHTS AND FINISHES OF DEVICES AND FIXTURES.
- REFER TO ENLARGED TYPICAL UNIT PLANS (E4 SERIES SHEETS) FOR TYPICAL POWER & LIGHTING LAYOUTS FOR THE RESIDENTIAL UNITS.
- REFER TO SHEET E1.21 FOR LIGHT FIXTURE SCHEDULE.
- REFER TO AVAILABLE ARCHITECTURAL AND/OR INTERIOR DESIGN DOCUMENTS & DRAWINGS FOR ADDITIONAL INFORMATION.
- OCCUPANCY SENSORS SHALL BE FIELD ADJUSTED TO ENSURE PROPER COVERAGE AND CONTROL.
- PROVIDE DIGITAL LIGHTING CONTROLS FOR EACH ROOM/SPACE, CONSISTING OF MULTI-BUTTON SWITCH(ES), OCC SENSORS, POWER PACKS, DAYLIGHT SENSORS, DIMMERS, INTERCONNECTING WIRING, ETC.
- CORRIDOR LIGHTING TO BE CONSTANT "ON" AND PROVIDED WITH LOCAL MANUAL OVERRIDE SWITCHES FOR MAINTENANCE. REFER TO SHEET E1.22 FOR SWITCH WIRING DIAGRAMS.
- ALL EGRESS FIXTURES SHALL BE WIRED SUCH THAT IN THE EVENT OF A POWER FAILURE, ALL LIGHTS WILL AUTOMATICALLY RETURN TO FULL POWER. REFER TO SWITCHING DETAILS ON SHEET E1.22.
- REFER TO SHEET E1.23 FOR LIGHTING CONTROL DIAGRAMS AND DESIGN INTENT. VERIFY LIGHTING CONTROLLABILITY WITH ARCHITECT AND/OR OWNER'S REPRESENTATIVE TO DETERMINE EXACT NEEDS FOR ALL PUBLIC/COMMON AREAS SUCH AS LOBBIES, OFFICES, LOUNGE AREAS, ETC., PRIOR TO THE START OF ANY WORK.
- THERE SHALL BE NO SURFACE MOUNTED FIXTURES OR PATHWAYS (CONDUIT, ETC.) IN ANY PUBLICLY ACCESSIBLE SPACES, INCLUDING STAIRWELLS AND EXIT PASSAGEWAYS WITHOUT PRIOR APPROVAL BY OWNER AND ARCHITECT. ROUTE ALL PATHWAYS WITHIN STUD CAVITIES OR ABOVE FINISHED CEILINGS.

KEYED NOTES:

- CONTINUE CIRCUIT UP THROUGH THE STAIRWELL.
- EXTERIOR BUILDING LIGHTS TO BE CONTROLLED VIA INTEGRAL AND/OR REMOTE PHOTOCELL FOR DUSK-TIL-DAWN OPERATION. REFER TO LIGHT FIXTURE SCHEDULE ON SHEET E1.21-E1.22 FOR ADDITIONAL INFORMATION.
- LIGHT FIXTURES IN THIS SPACE CONTROLLED BY CEILING MOUNT OCCUPANCY SENSOR.
- PROVIDE PHOTOCELL FOR DAY-LIGHT REDUCTION OF LIGHT LEVELS.
- CONTRACTOR TO COORDINATE WITH LANDSCAPE LIGHTING INSTALLER AND PROVIDE ROUGH-IN AND POWER CONNECTION(S) AS REQUIRED.
- REFER TO SHEET E1.12 FOR TYPICAL DWELLING UNIT LOAD CENTER SCHEDULE FOR CIRCUITING INFORMATION.
- REFER TO THE E3 SERIES SHEETS FOR TYPICAL DWELLING UNIT POWER DEVICE LAYOUT.

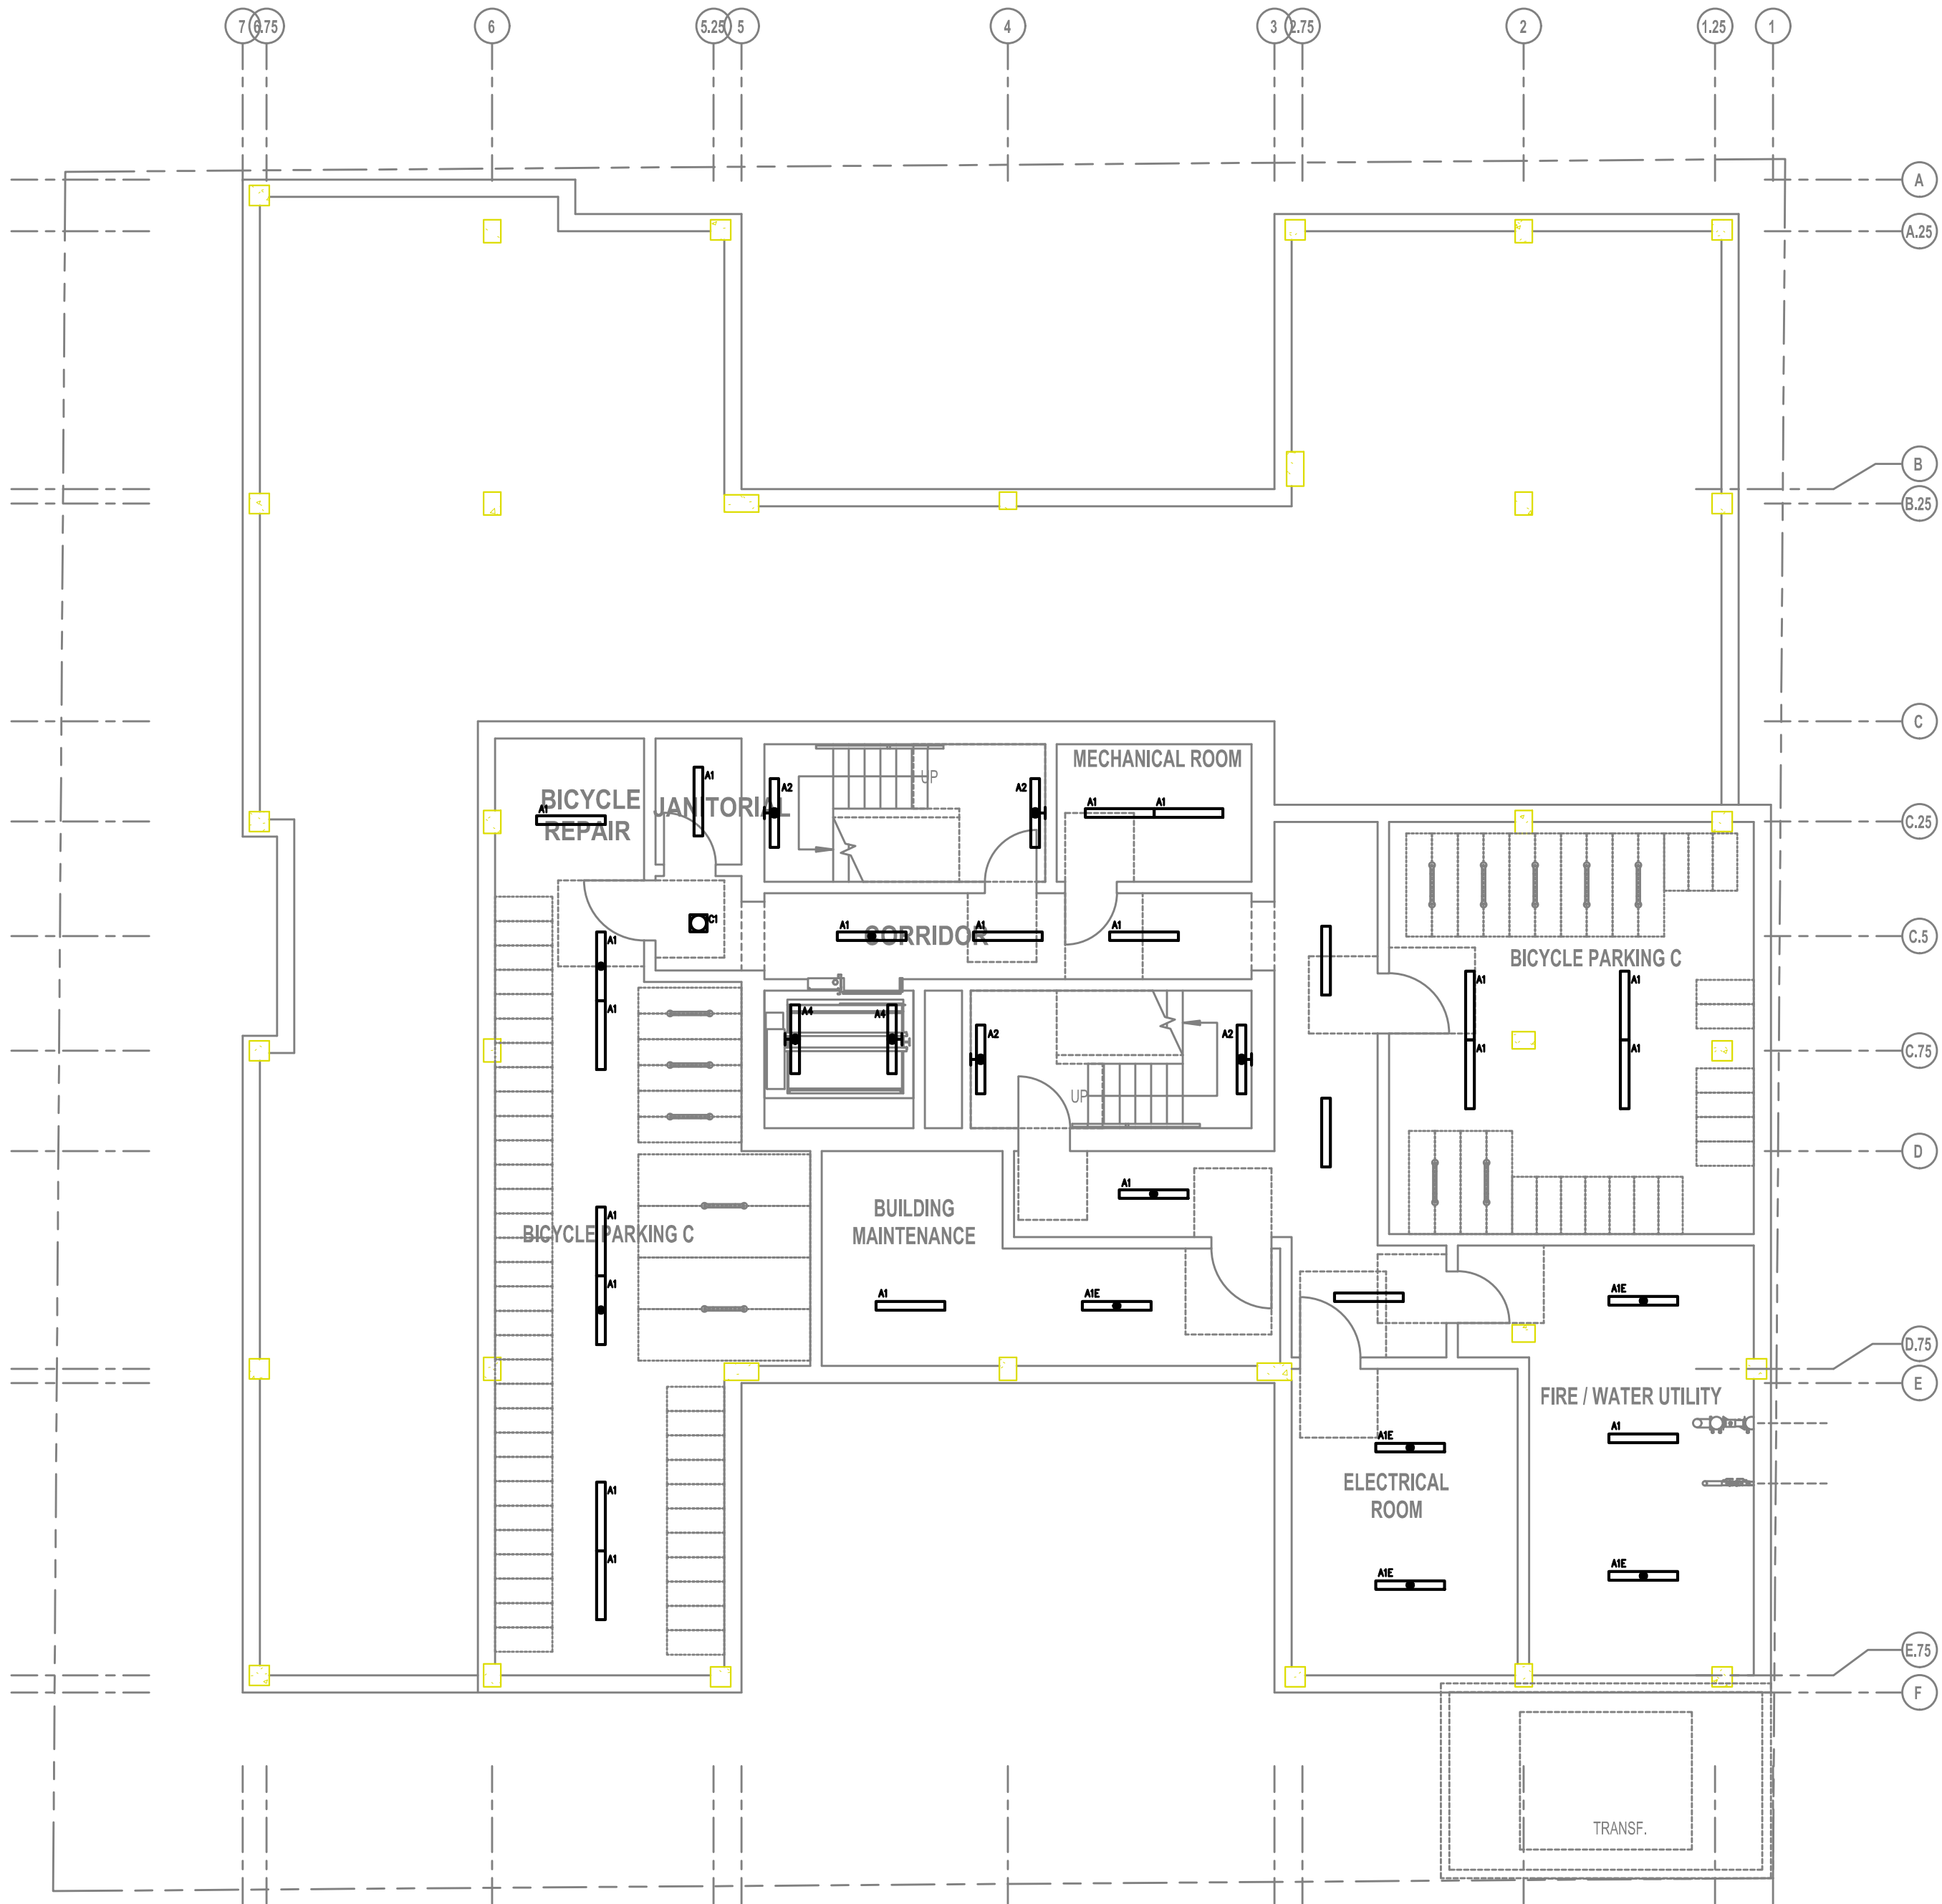

1 BASEMENT LEVEL LIGHTING PLAN
E2.00 SCALE: 1/8" = 1'-0"

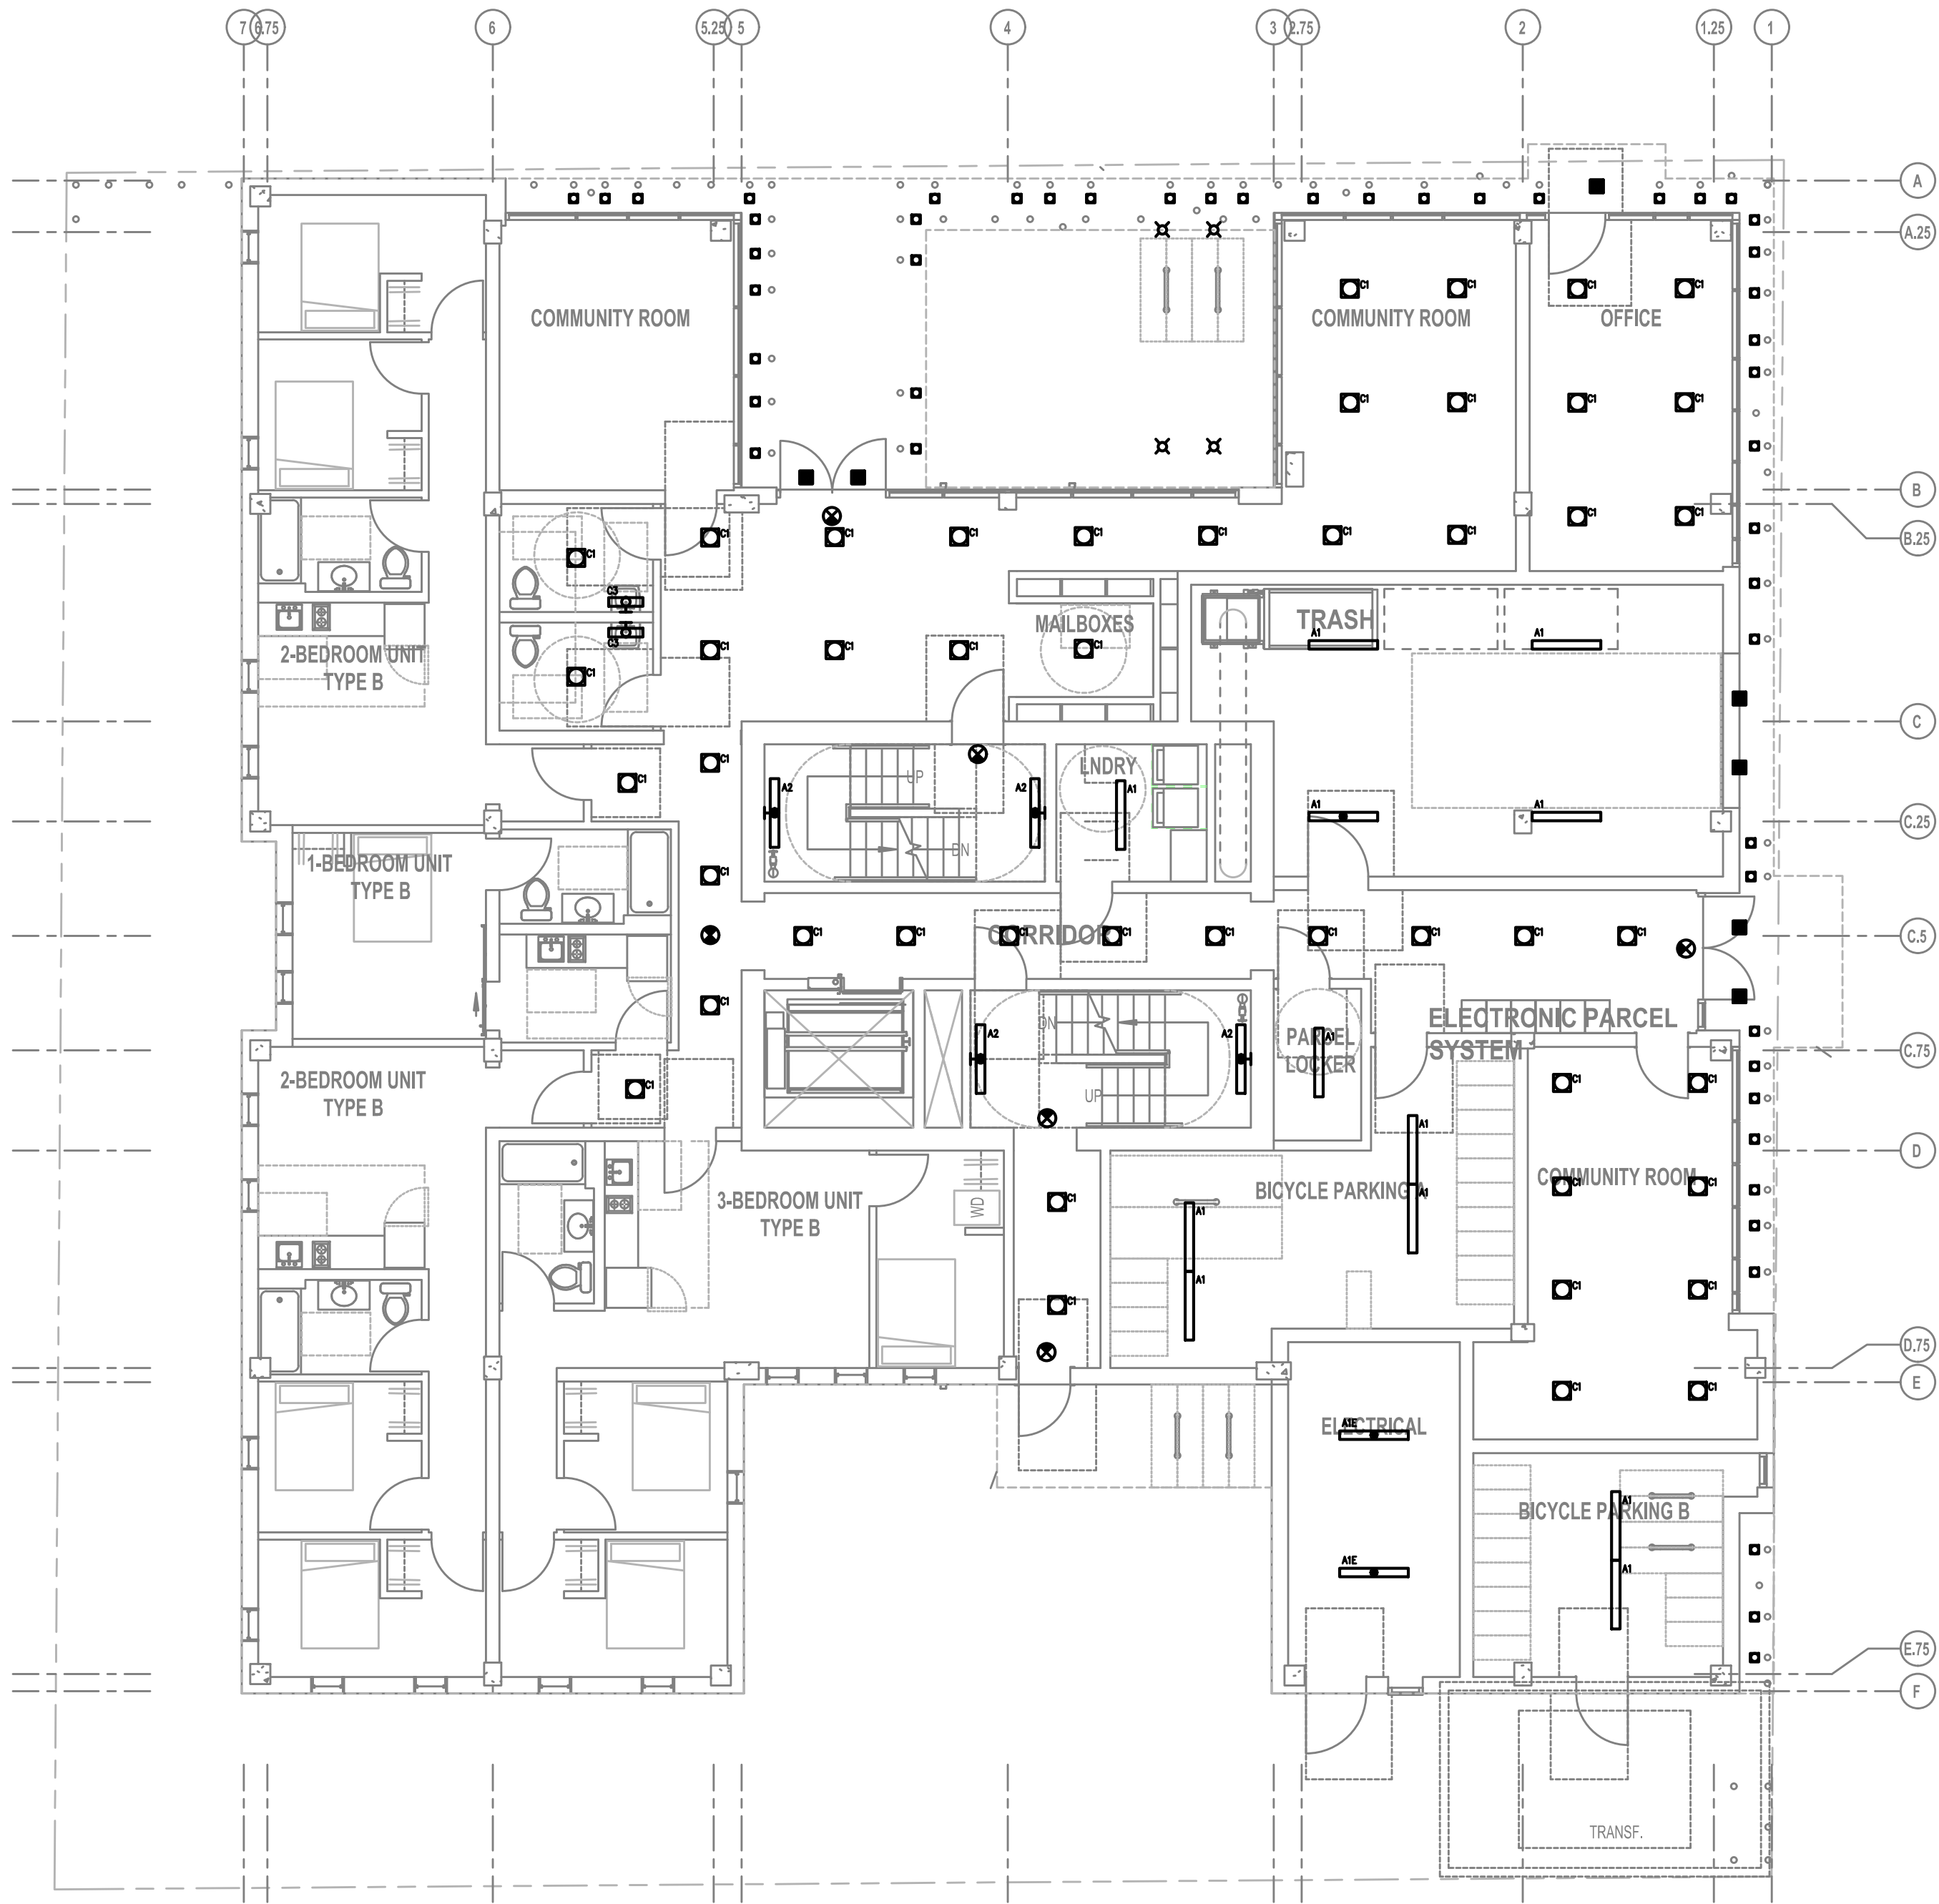

1 FIRST FLOOR LIGHTING PLAN
E2.01 SCALE: 1/8" = 1'-0"

GENERAL LIGHTING NOTES:

- A. ELECTRICAL DRAWINGS ARE DIAGRAMMATICAL AND MAY NOT ACCURATELY REFLECT ACTUAL CONSTRUCTION CONDITIONS. THE ELECTRICAL CONTRACTOR SHALL BE RESPONSIBLE FOR COORDINATING THE INSTALLATION OF ALL ELECTRICAL EQUIPMENT, WITH ALL TRADES PRIOR TO AND DURING CONSTRUCTION.
- B. THE ELECTRICAL CONTRACTOR SHALL REFER TO THE ARCHITECTURAL & INTERIOR DESIGN DRAWINGS FOR EXACT LOCATIONS, MOUNTING HEIGHTS AND FINISHES OF DEVICES AND FIXTURES.
- C. REFER TO ENLARGED TYPICAL UNIT PLANS (E4 SERIES SHEETS) FOR TYPICAL POWER & LIGHTING LAYOUTS FOR THE RESIDENTIAL UNITS.
- D. REFER TO SHEET E1.21 FOR LIGHT FIXTURE SCHEDULE.
- E. REFER TO AVAILABLE ARCHITECTURAL AND/OR INTERIOR DESIGN DOCUMENTS & DRAWINGS FOR ADDITIONAL INFORMATION.
- F. OCCUPANCY SENSORS SHALL BE FIELD ADJUSTED TO ENSURE PROPER COVERAGE AND CONTROL.
- G. PROVIDE DIGITAL LIGHTING CONTROLS FOR EACH ROOM/SPACE, CONSISTING OF MULTI-BUTTON SWITCH(ES), OCC SENSORS, POWER PACKS, DAYLIGHT SENSORS, DIMMERS, INTERCONNECTING WIRING, ETC.
- H. CORRIDOR LIGHTING TO BE CONSTANT "ON" AND PROVIDED WITH LOCAL MANUAL OVERRIDE SWITCHES FOR MAINTENANCE. REFER TO SHEET E1.22 FOR SWITCH WIRING DIAGRAMS.
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- J. REFER TO SHEET E1.23 FOR LIGHTING CONTROL DIAGRAMS AND DESIGN INTENT. VERIFY LIGHTING CONTROLLABILITY WITH ARCHITECT AND/OR OWNER'S REPRESENTATIVE TO DETERMINE EXACT NEEDS FOR ALL PUBLIC/Common AREAS SUCH AS LOBBIES, OFFICES, LOUNGE AREAS, ETC., PRIOR TO THE START OF ANY WORK.
- K. THERE SHALL BE NO SURFACE MOUNTED FIXTURES OR PATHWAYS (CONDUIT, ETC.) IN ANY PUBLICLY ACCESSIBLE SPACES, INCLUDING STAIRWELLS AND EXIT PASSAGEWAYS WITHOUT PRIOR APPROVAL BY OWNER AND ARCHITECT. ROUTE ALL PATHWAYS WITHIN STUD CAVITIES OR ABOVE FINISHED CEILINGS.

KEYED NOTES:

- 1. CONTINUE CIRCUIT UP THROUGH THE STAIRWELL.
- 2. EXTERIOR BUILDING LIGHTS TO BE CONTROLLED VIA INTEGRAL AND/OR REMOTE PHOTOCELL FOR DUSK-TILL-DAWN OPERATION. REFER TO LIGHT FIXTURE SCHEDULE ON SHEET E1.21-E1.22 FOR ADDITIONAL INFORMATION.
- 3. LIGHT FIXTURES IN THIS SPACE CONTROLLED BY CEILING MOUNT OCCUPANCY SENSOR.
- 4. PROVIDE PHOTOCELL FOR DAY-LIGHT REDUCTION OF LIGHT LEVELS.
- 5. CONTRACTOR TO COORDINATE WITH LANDSCAPE LIGHTING INSTALLER AND PROVIDE ROUGH-IN AND POWER CONNECTION(S) AS REQUIRED.
- 6. REFER TO SHEET E1.12 FOR TYPICAL DWELLING UNIT LOAD CENTER SCHEDULE FOR CIRCUITING INFORMATION.
- 7. REFER TO THE E3 SERIES SHEETS FOR TYPICAL DWELLING UNIT POWER DEVICE LAYOUT.

PRELIMINARY
NOT FOR
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M Consulting Engineers
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INC. WWW.MFIA-ENG.COM
CONTACT: DENISE TAYLOR
Project Owner:
NATIVE LAND DEVELOPMENT

Project Name:
MINNESOTA
PLACES

1208 N. JESSUP &
5627 N. MINNESOTA
(R226159, R226160)

PRELIMINARY
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DESIGN
DEVELOPMENT
SET

Issued:	
PRELIMINARY	4.27.2021
Job #:	2020
ORIGINAL SHEET SIZE: 22" x 34"	
HALF SIZE: 11" x 17"	

FIRST FLOOR
LIGHTING PLAN

Drawing Number
E2.01



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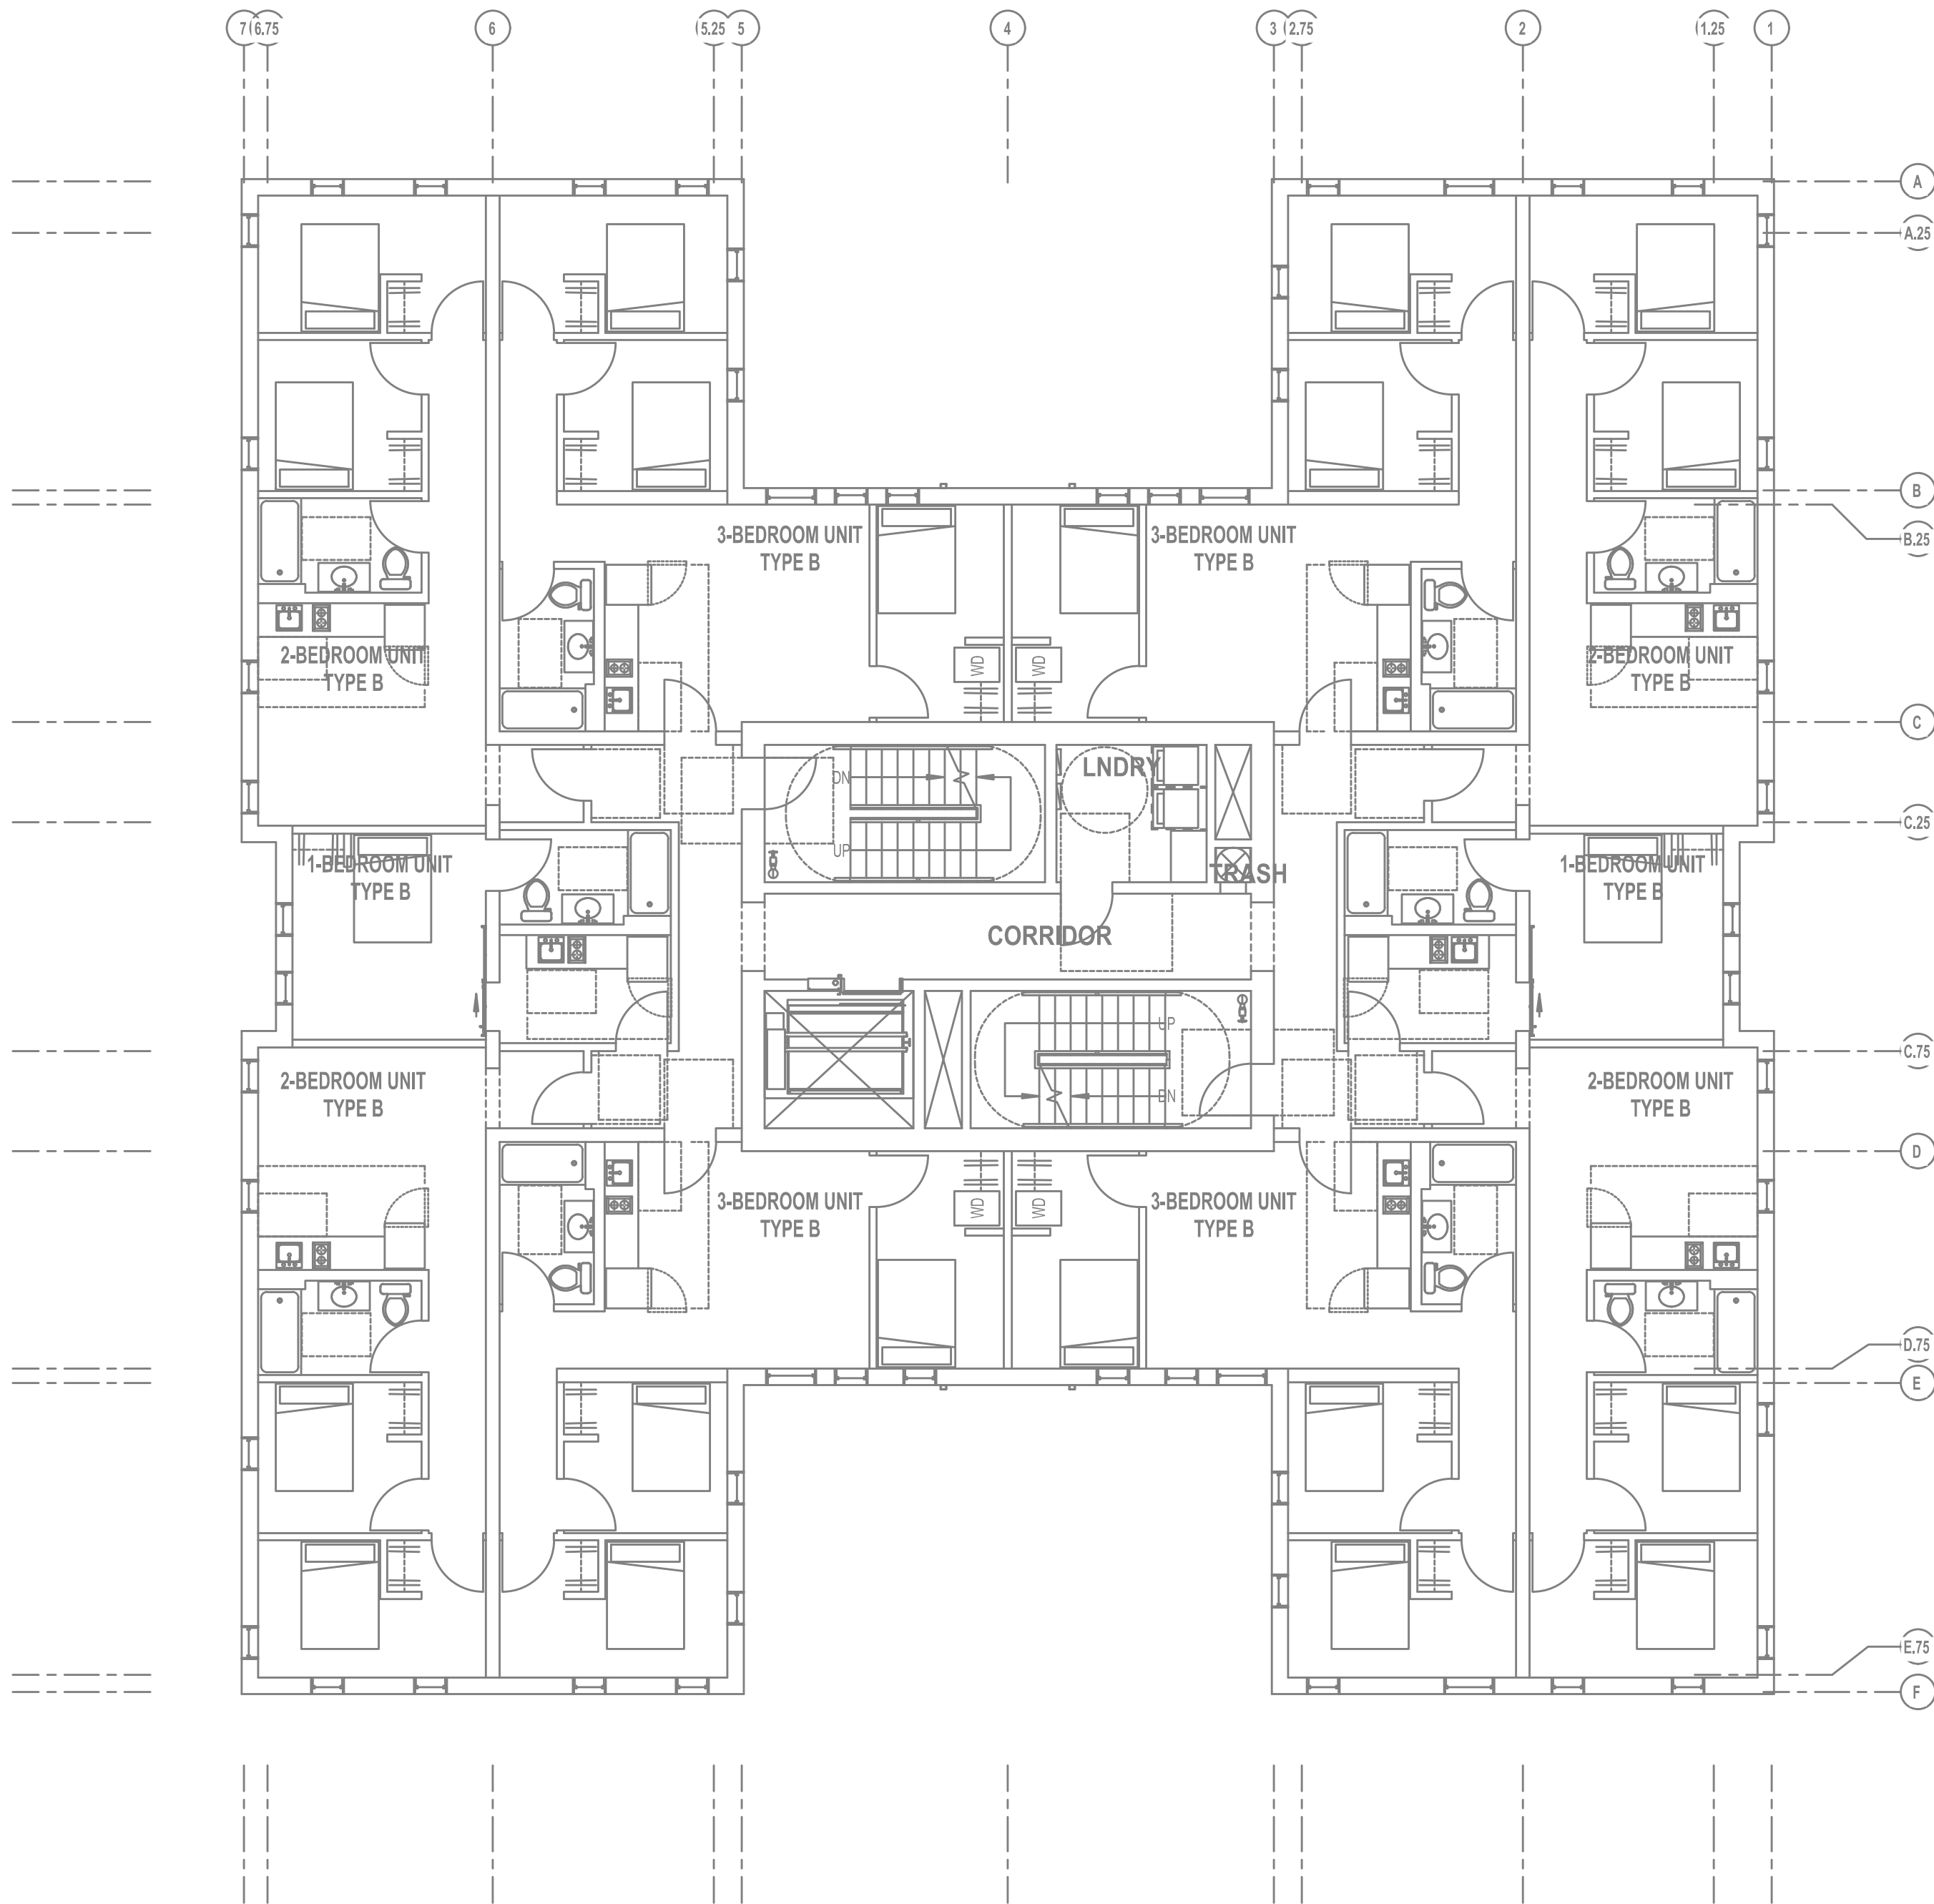
Job #: 2020

ORIGINAL SHEET SIZE: 22" x 34"
HALF SIZE: 11" x 17"

THIRD FLOOR
LIGHTING PLAN

Drawing Number

E2.03



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FOURTH FLOOR
LIGHTING PLAN

Drawing Number


E2.04

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FIFTH FLOOR
LIGHTING PLAN

Drawing Number


E2.05

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1 FIFTH FLOOR LIGHTING PLAN
E2.05 SCALE: 1/8" = 1'-0"
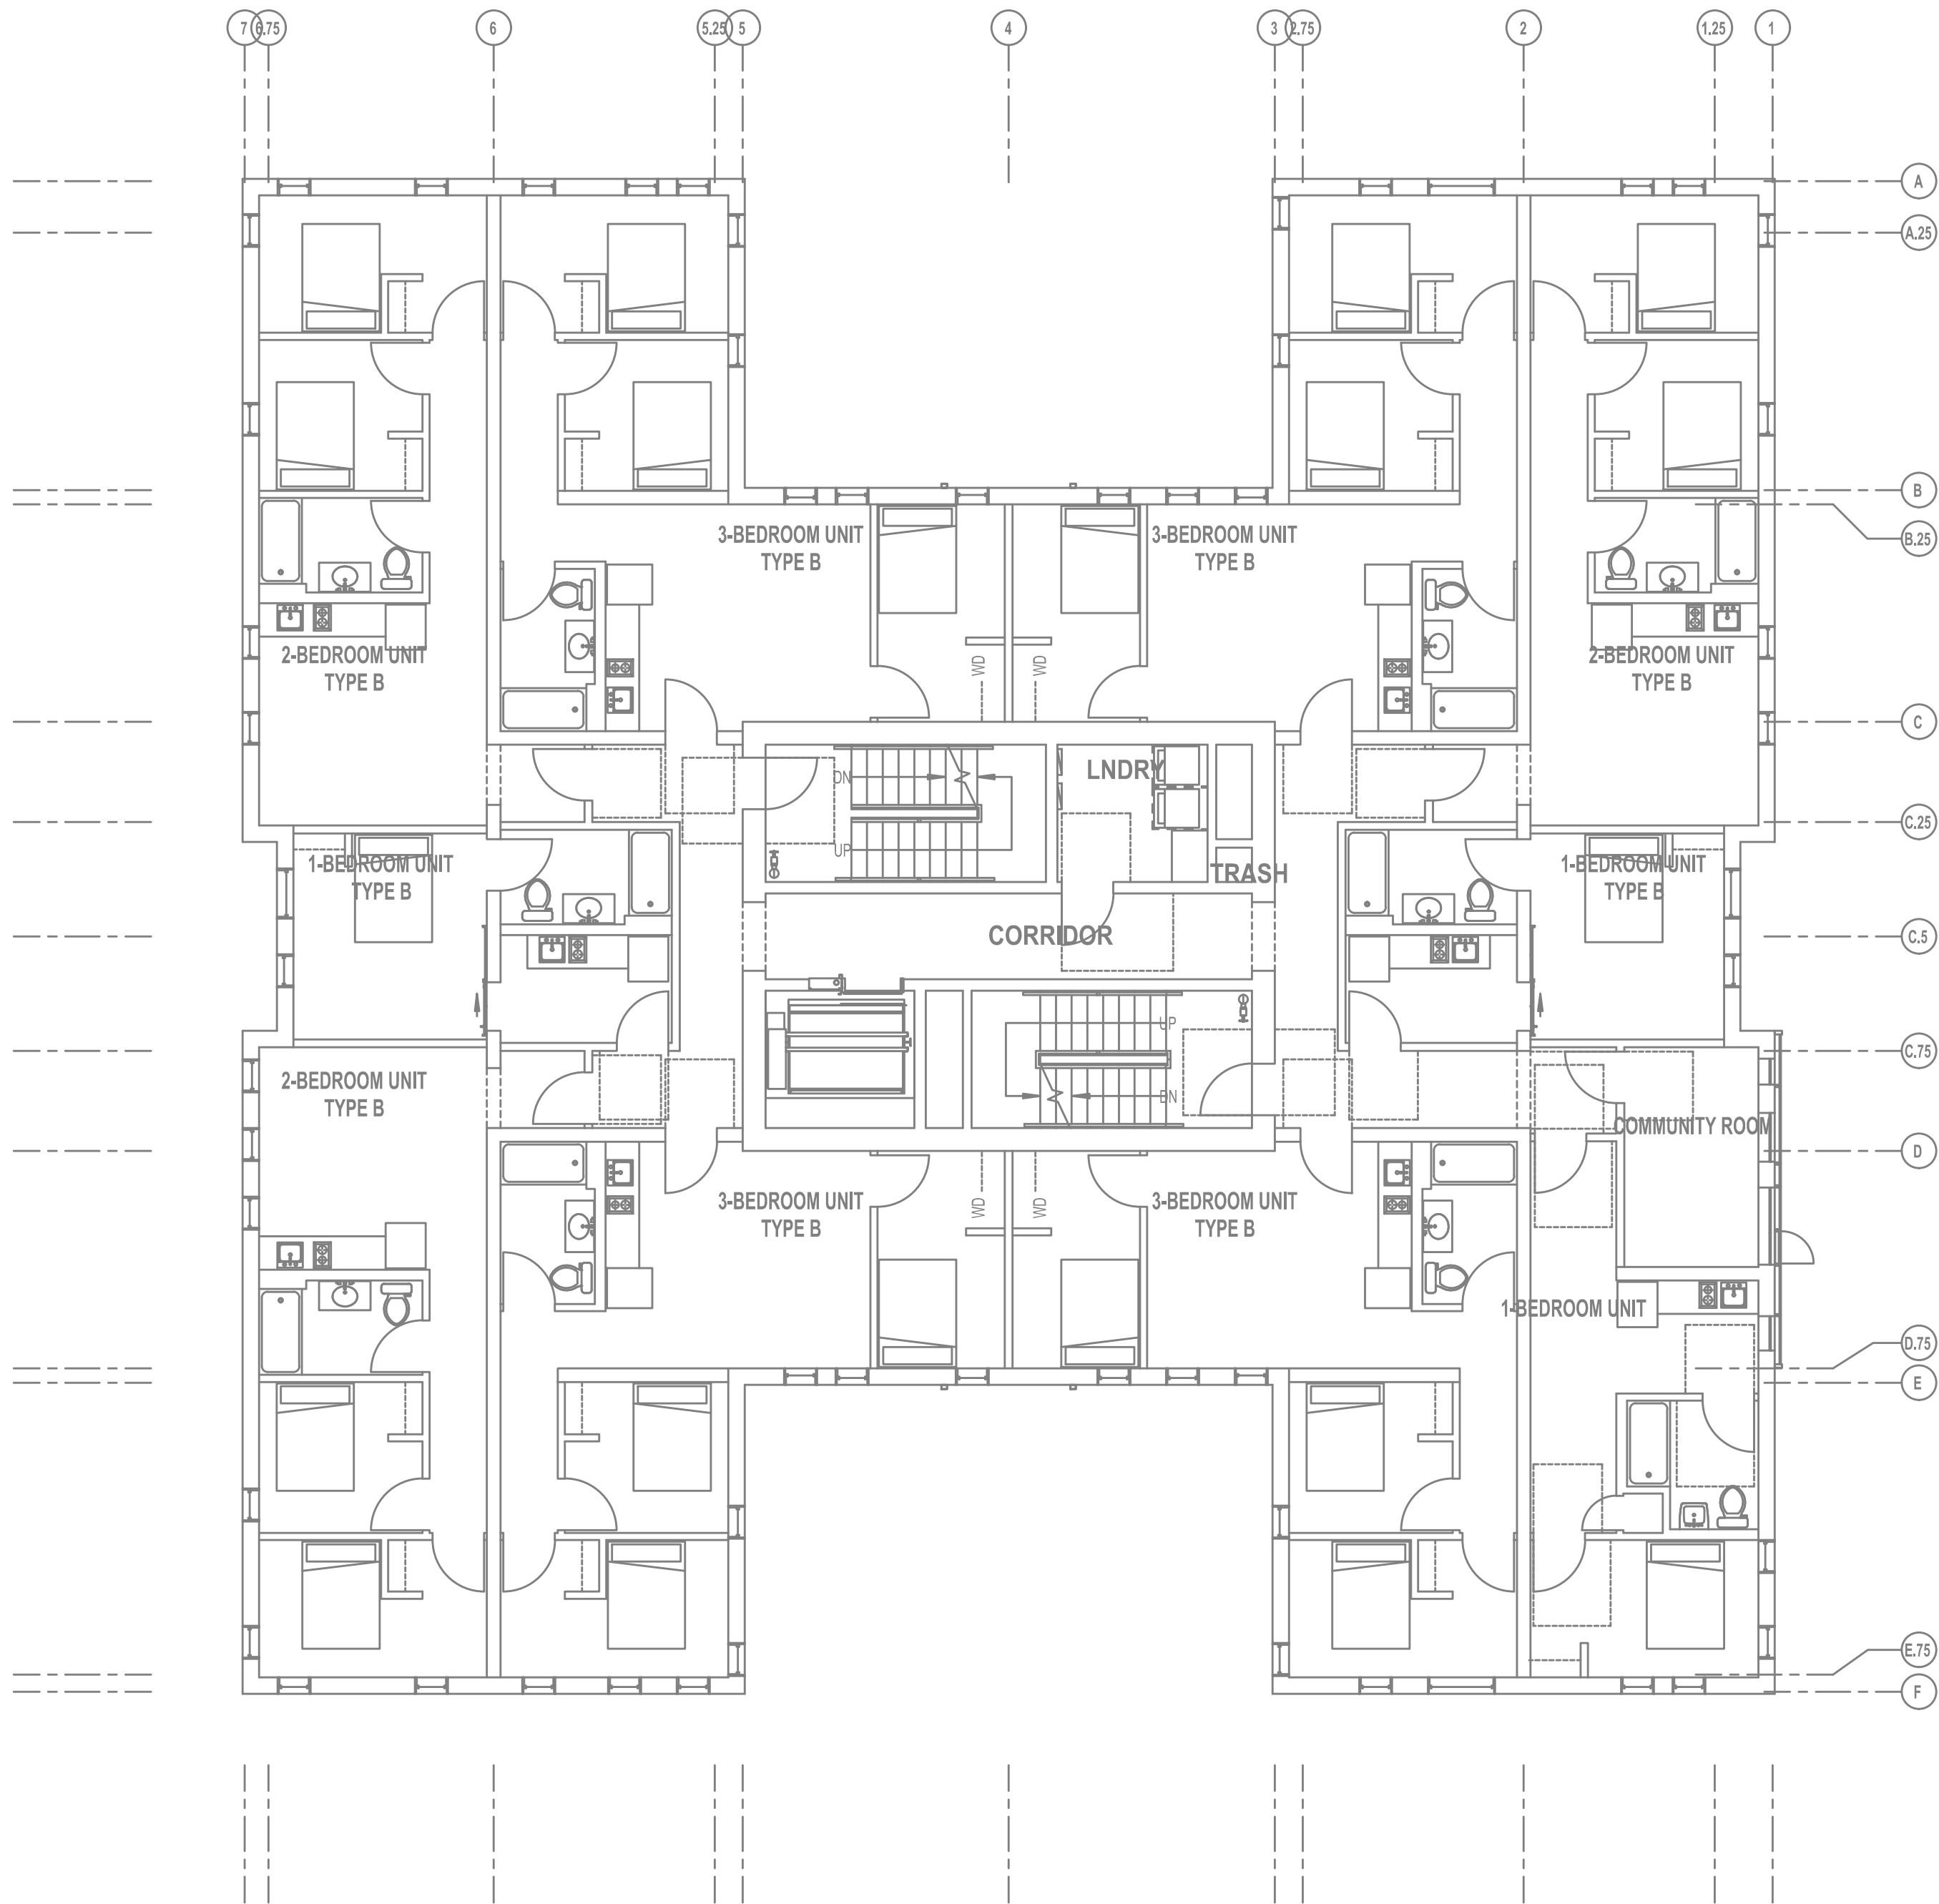
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Job #: 2020

ORIGINAL SHEET SIZE: 22" x 34"
HALF SIZE: 11" x 17"

SIXTH FLOOR
LIGHTING PLAN

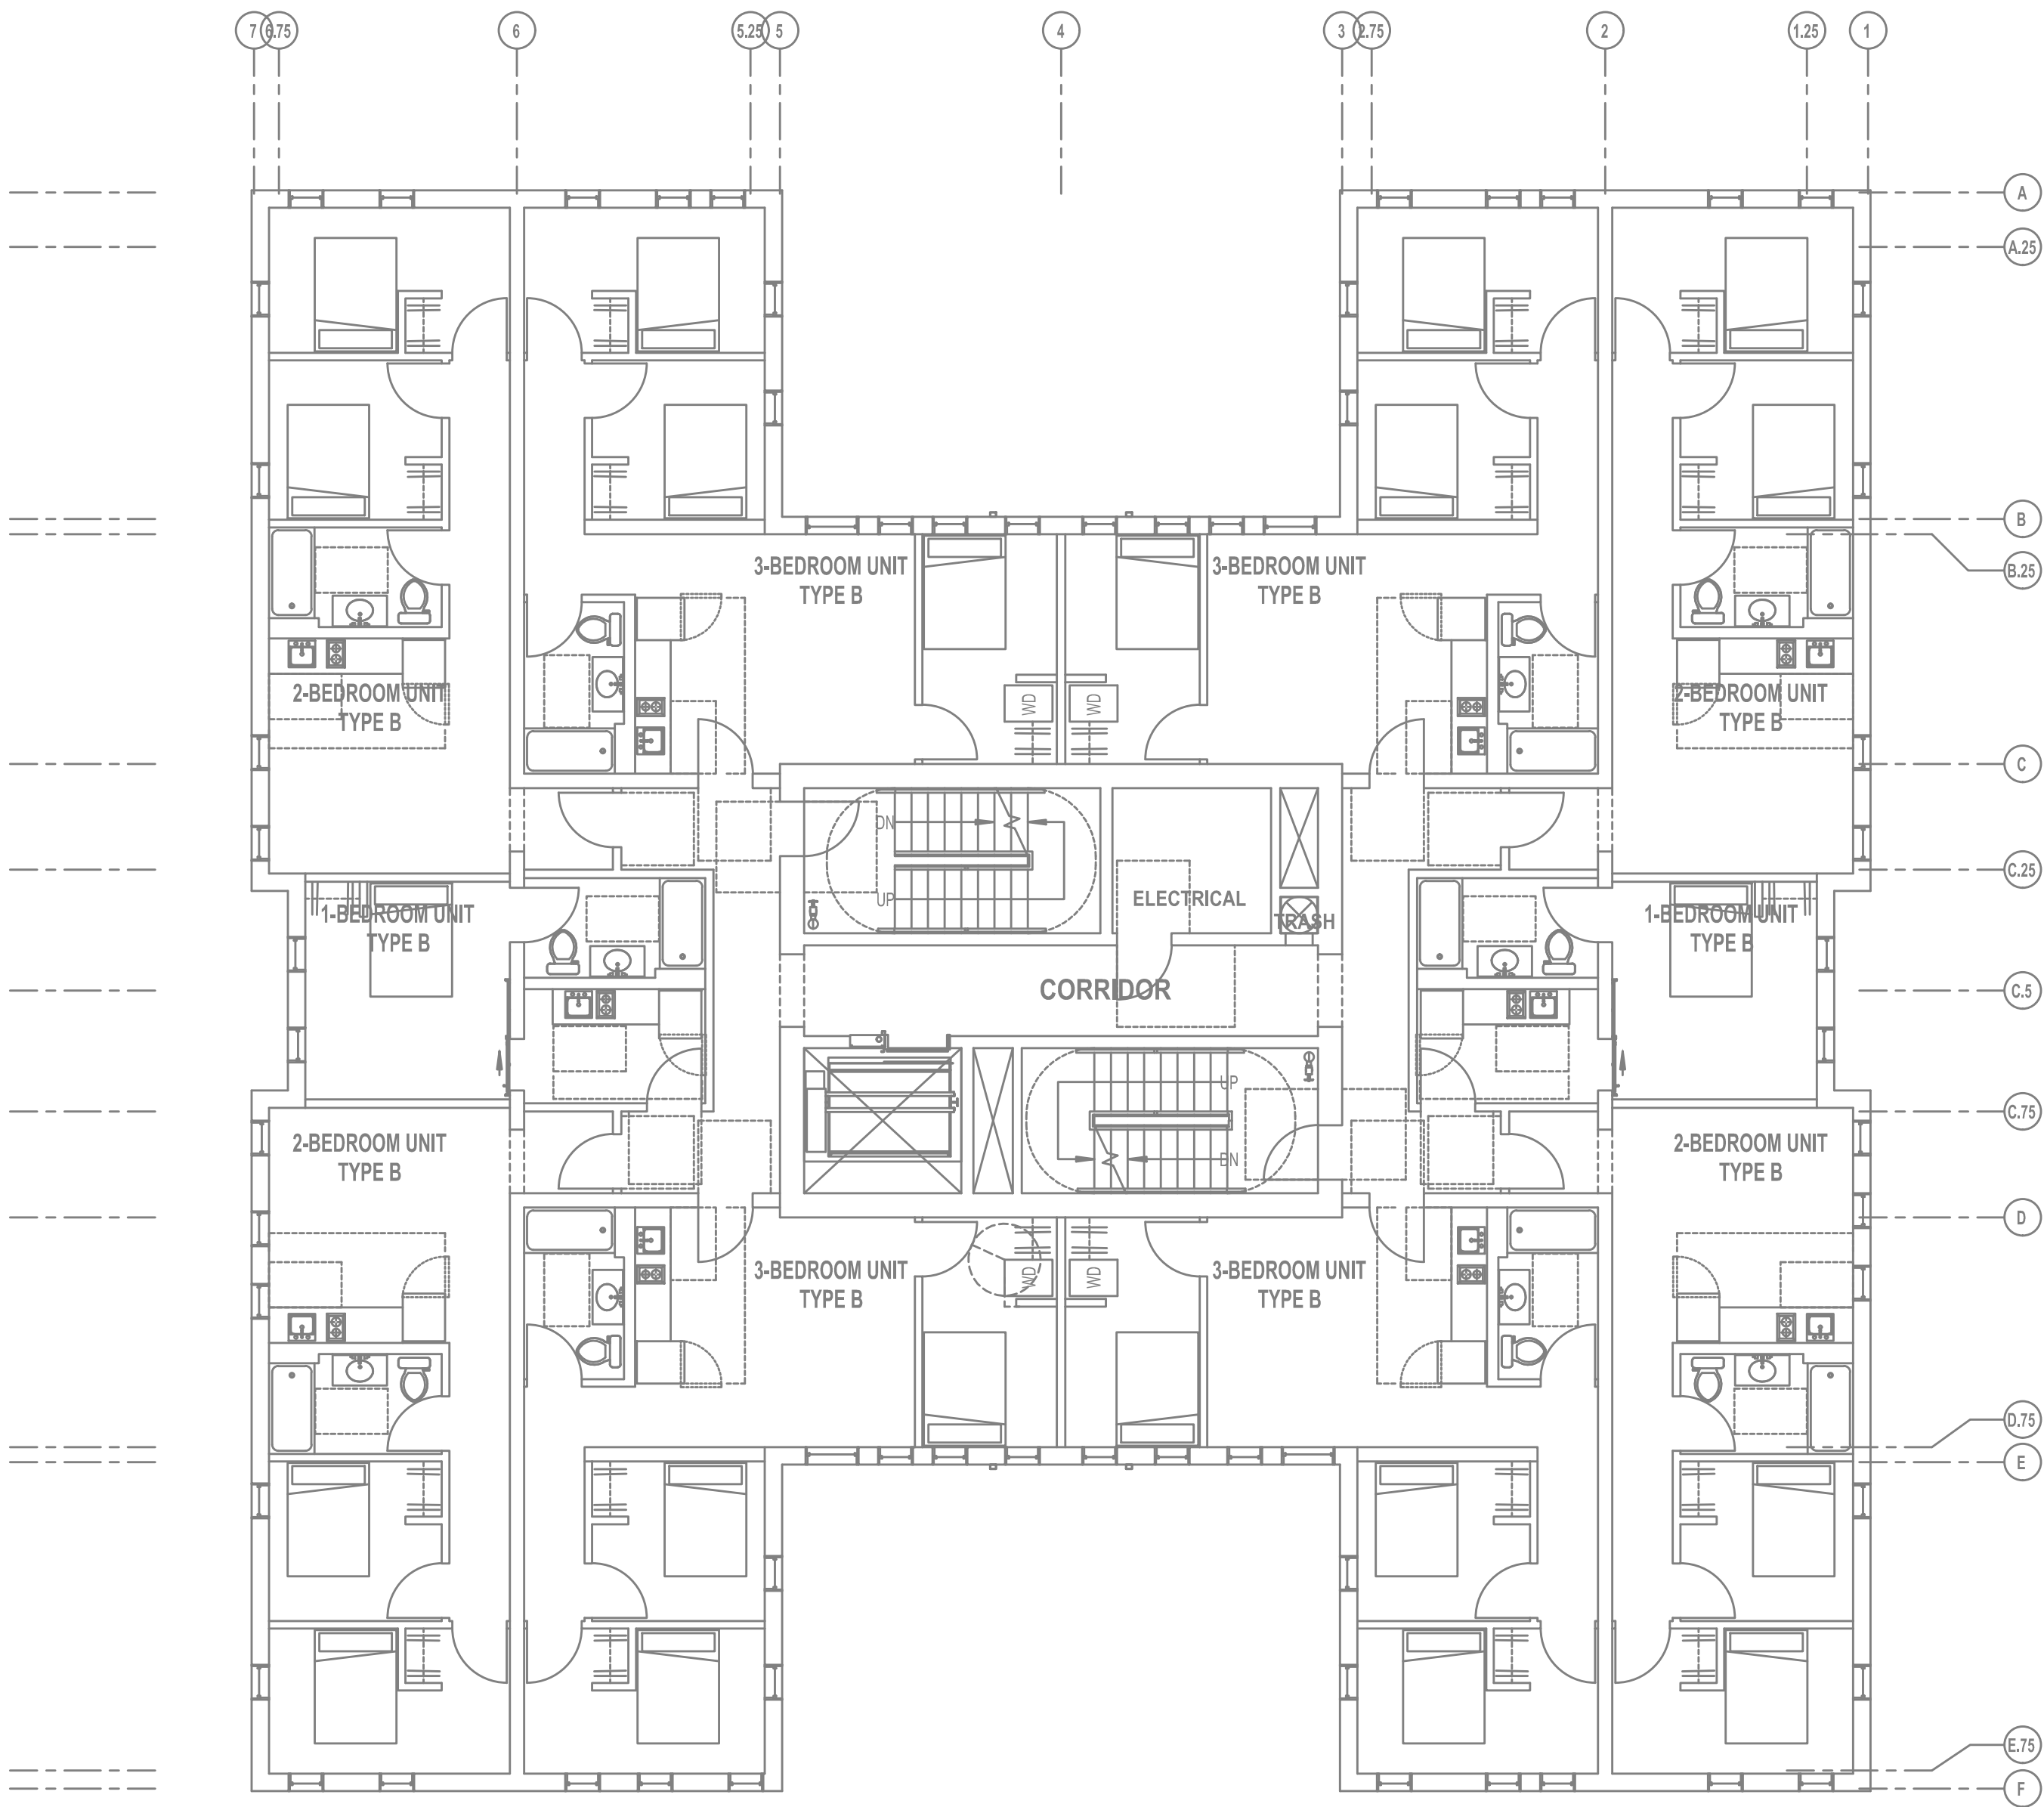Drawing Number


E2.06

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1 SIXTH FLOOR LIGHTING PLAN
E2.06 SCALE: 1/8" = 1'-0"

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SEVENTH FLOOR
LIGHTING PLAN

Drawing Number


E2.07
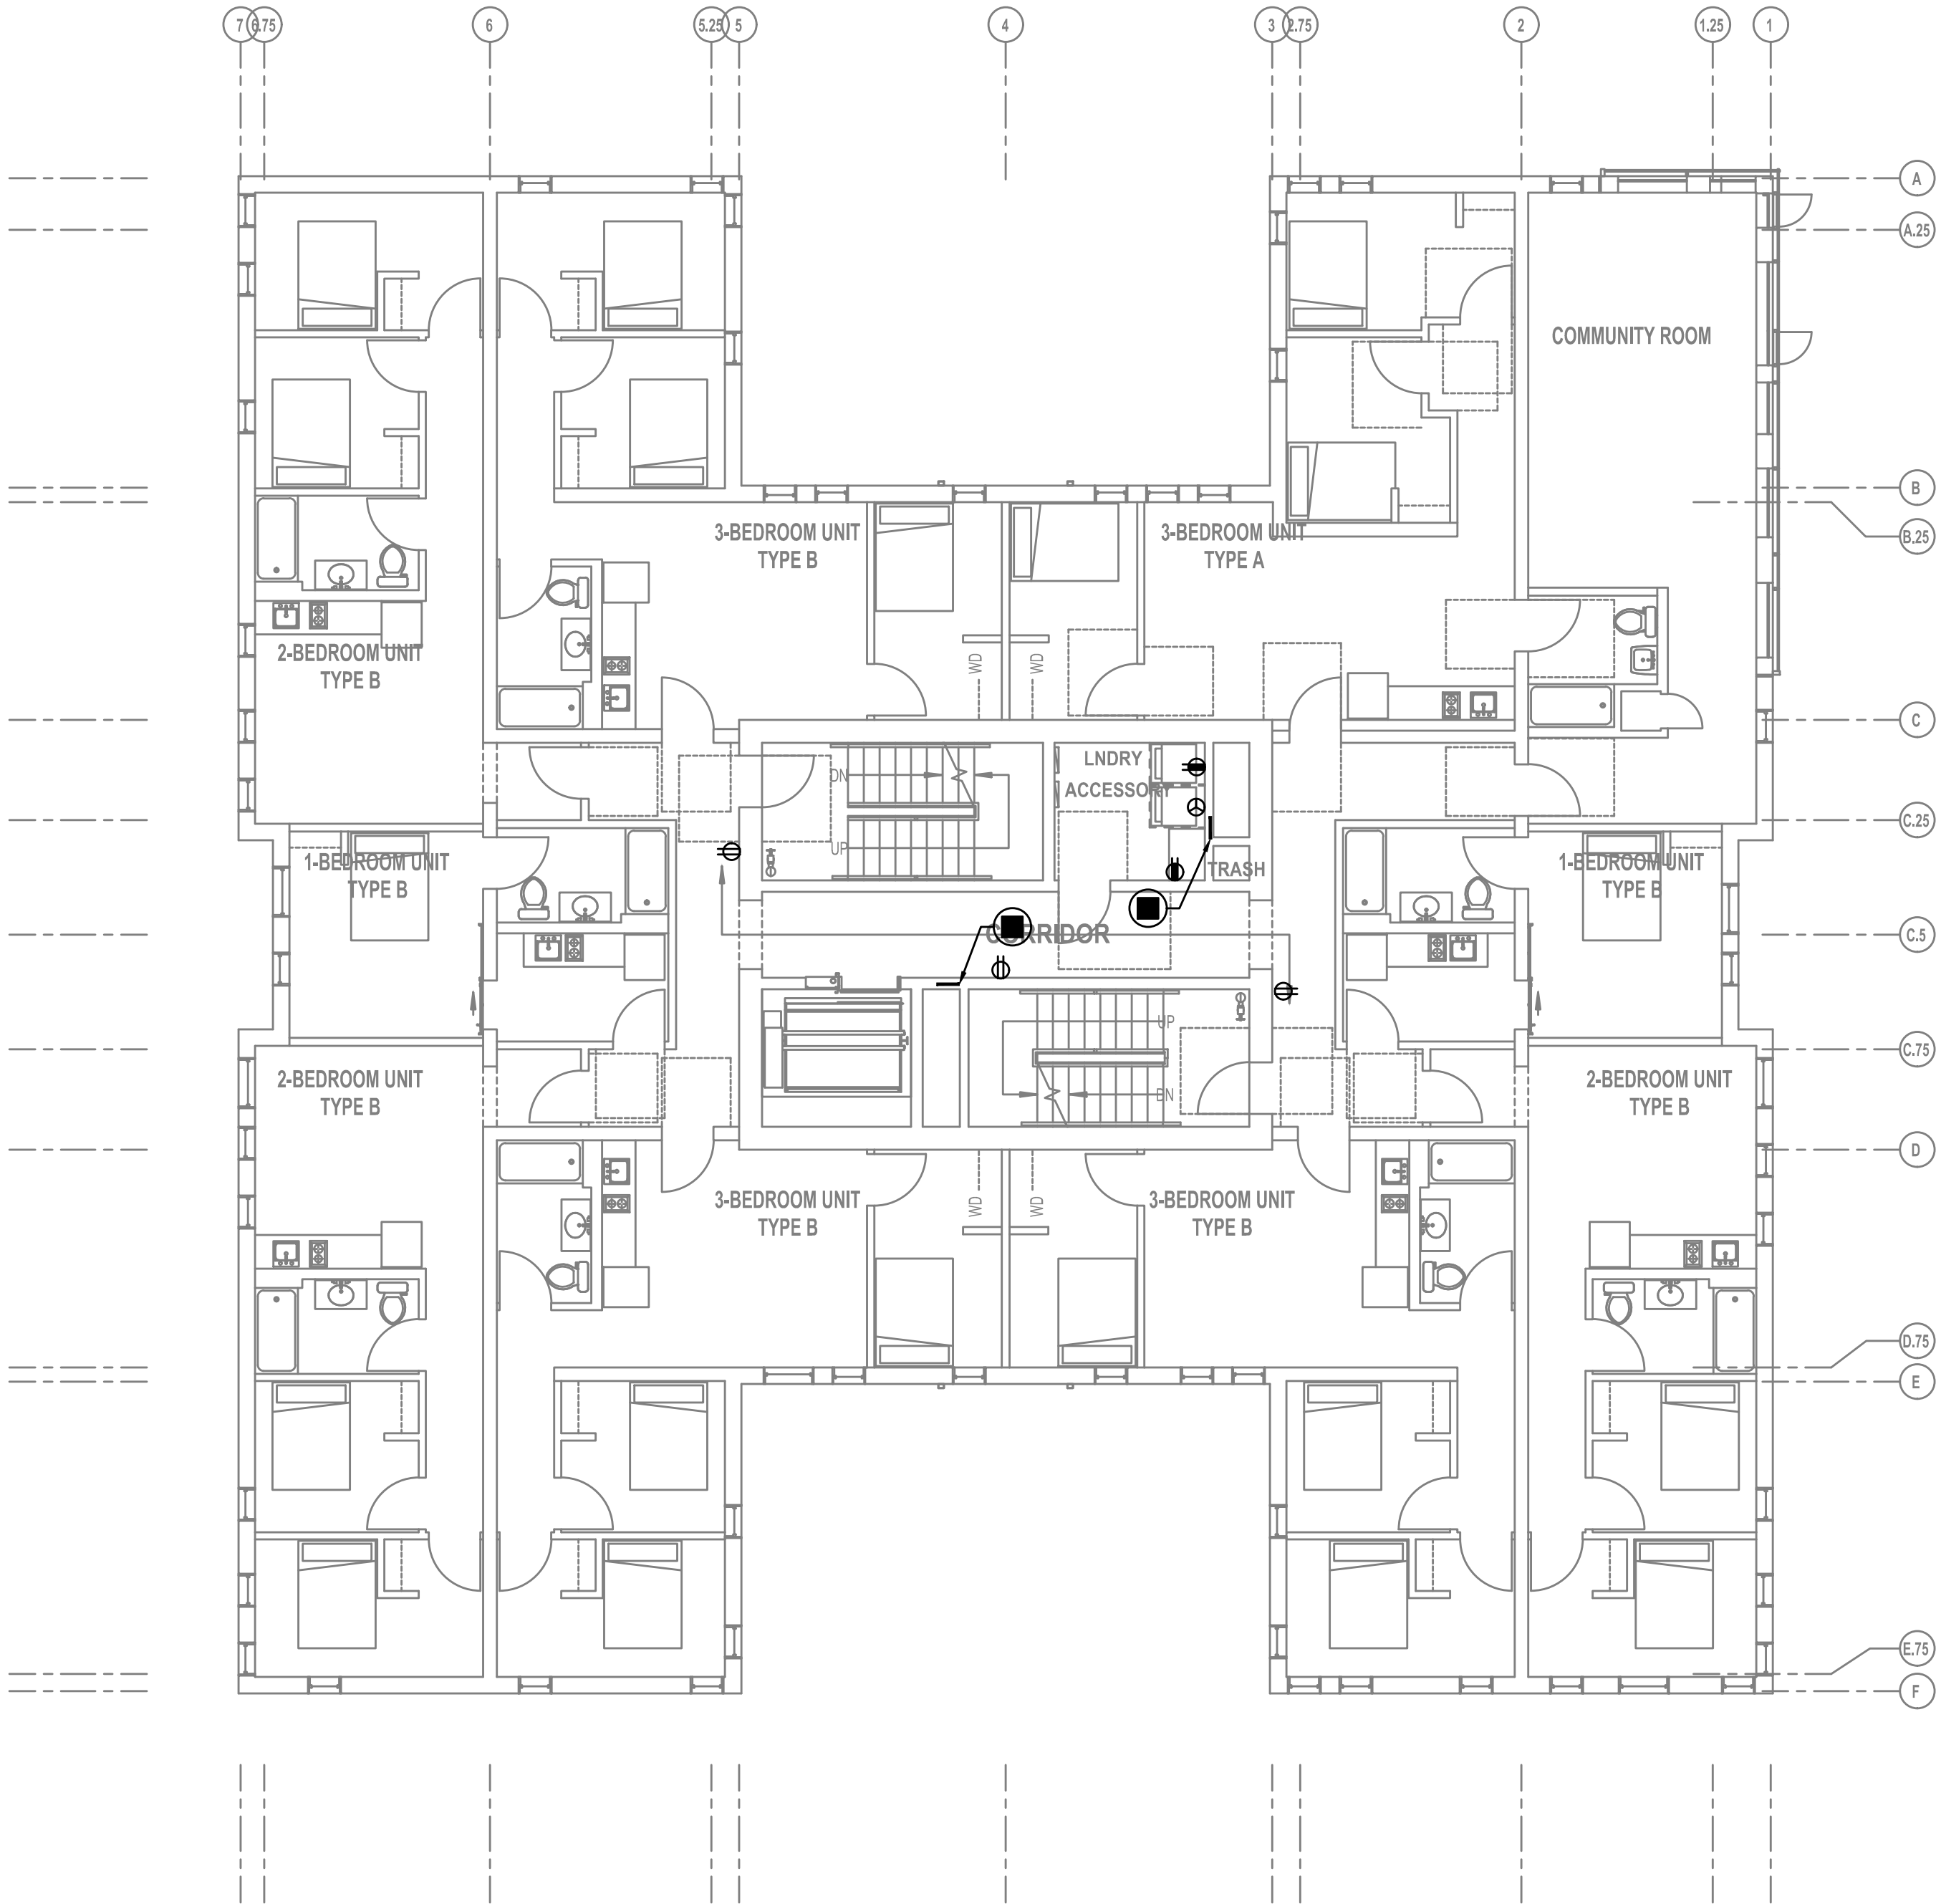
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- THE ELECTRICAL CONTRACTOR SHALL REFER TO THE ARCHITECTURAL & INTERIOR DESIGN DRAWINGS FOR EXACT LOCATIONS, MOUNTING HEIGHTS AND FINISHES OF DEVICES AND FIXTURES.
- REFER TO ENLARGED TYPICAL UNIT PLANS (E4 SERIES SHEETS) FOR TYPICAL POWER & LIGHTING LAYOUTS FOR THE RESIDENTIAL UNITS.
- REFER TO SHEET E1.21 FOR LIGHT FIXTURE SCHEDULE.
- REFER TO AVAILABLE ARCHITECTURAL AND/OR INTERIOR DESIGN DOCUMENTS & DRAWINGS FOR ADDITIONAL INFORMATION.
- OCCUPANCY SENSORS SHALL BE FIELD ADJUSTED TO ENSURE PROPER COVERAGE AND CONTROL.
- PROVIDE DIGITAL LIGHTING CONTROLS FOR EACH ROOM/SPACE, CONSISTING OF MULTI-BUTTON SWITCH(ES), OCC SENSORS, POWER PACKS, DAYLIGHT SENSORS, DIMMERS, INTERCONNECTING WIRING, ETC.
- CORRIDOR LIGHTING TO BE CONSTANT "ON" AND PROVIDED WITH LOCAL MANUAL OVERRIDE SWITCHES FOR MAINTENANCE. REFER TO SHEET E1.22 FOR SWITCH WIRING DIAGRAMS.
- ALL EGRESS FIXTURES SHALL BE WIRED SUCH THAT IN THE EVENT OF A POWER FAILURE, ALL LIGHTS WILL AUTOMATICALLY RETURN TO FULL POWER. REFER TO SWITCHING DETAILS ON SHEET E1.22.
- REFER TO SHEET E1.23 FOR LIGHTING CONTROL DIAGRAMS AND DESIGN INTENT. VERIFY LIGHTING CONTROLLABILITY WITH ARCHITECT AND/OR OWNER'S REPRESENTATIVE TO DETERMINE EXACT NEEDS FOR ALL PUBLIC/Common AREAS SUCH AS LOBBIES, OFFICES, LOUNGE AREAS, ETC., PRIOR TO THE START OF ANY WORK.
- THERE SHALL BE NO SURFACE MOUNTED FIXTURES OR PATHWAYS (CONDUIT, ETC.) IN ANY PUBLICLY ACCESSIBLE SPACES, INCLUDING STAIRWELLS AND EXIT PASSAGEWAYS WITHOUT PRIOR APPROVAL BY OWNER AND ARCHITECT. ROUTE ALL PATHWAYS WITHIN STUD CAVITIES OR ABOVE FINISHED CEILINGS.

KEYED NOTES:

- CONTINUE CIRCUIT UP THROUGH THE STAIRWELL.
- EXTERIOR BUILDING LIGHTS TO BE CONTROLLED VIA INTEGRAL AND/OR REMOTE PHOTOCELL FOR DUSK-TILL-DAWN OPERATION. REFER TO LIGHT FIXTURE SCHEDULE ON SHEET E1.21-E1.22 FOR ADDITIONAL INFORMATION.
- LIGHT FIXTURES IN THIS SPACE CONTROLLED BY CEILING MOUNT OCCUPANCY SENSOR.
- PROVIDE PHOTOCELL FOR DAY-LIGHT REDUCTION OF LIGHT LEVELS.
- CONTRACTOR TO COORDINATE WITH LANDSCAPE LIGHTING INSTALLER AND PROVIDE ROUGH-IN AND POWER CONNECTION(S) AS REQUIRED.
- REFER TO SHEET E1.12 FOR TYPICAL DWELLING UNIT LOAD CENTER SCHEDULE FOR CIRCUITING INFORMATION.
- REFER TO THE E3 SERIES SHEETS FOR TYPICAL DWELLING UNIT POWER DEVICE LAYOUT.

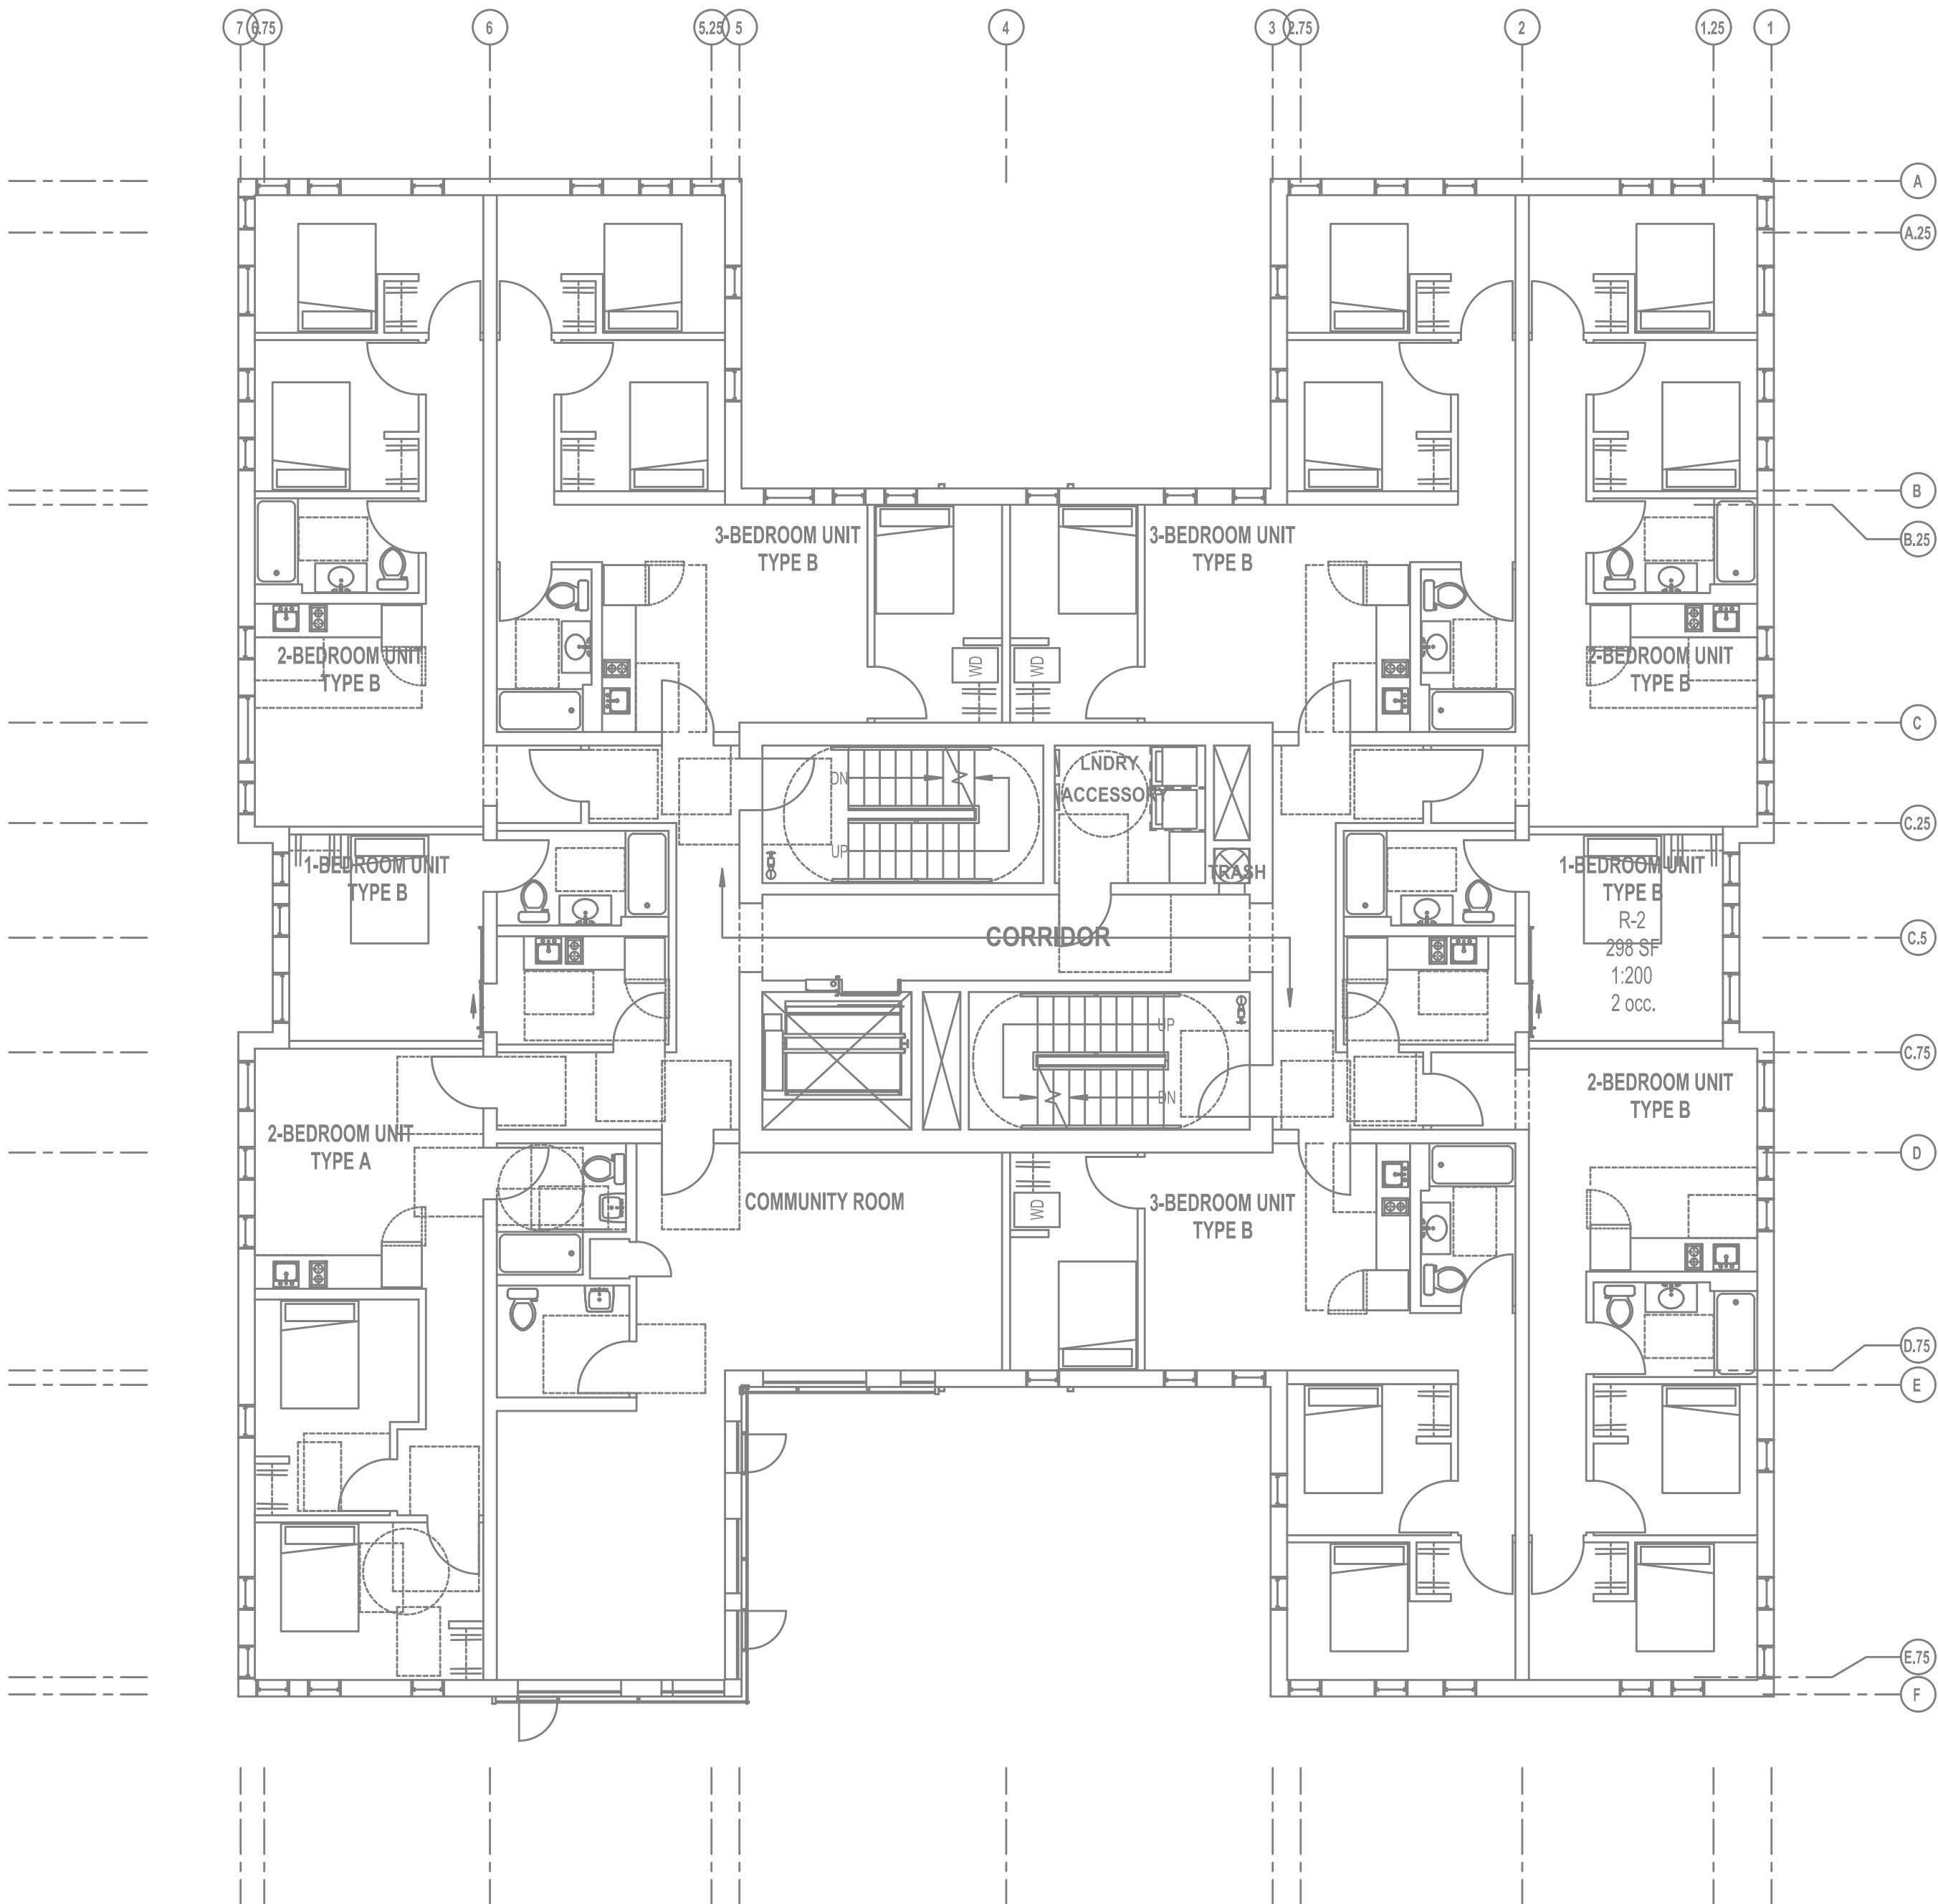

1 SEVENTH FLOOR LIGHTING PLAN
E2.07 SCALE: 1/8" = 1'-0"

PRELIMINARY
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Project Owner:

NATIVE LAND DEVELOPMENT

Project Name:

MINNESOTA
PLACES

1208 N. JESSUP &
5627 N. MINNESOTA
(R226159, R226160)

PRELIMINARY
NOT FOR
CONSTRUCTION

DESIGN
DEVELOPMENT
SET

Issued:
PRELIMINARY 4.27.2021

Job #: 2020

ORIGINAL SHEET SIZE: 22" x 34"
HALF SIZE: 11" x 17"

EIGHTH FLOOR
LIGHTING PLAN

Drawing Number


E2.08

GENERAL LIGHTING NOTES:

- ELECTRICAL DRAWINGS ARE DIAGRAMMATICAL AND MAY NOT ACCURATELY REFLECT ACTUAL CONSTRUCTION CONDITIONS. THE ELECTRICAL CONTRACTOR SHALL BE RESPONSIBLE FOR COORDINATING THE INSTALLATION OF ALL ELECTRICAL EQUIPMENT, WITH ALL TRADES PRIOR TO AND DURING CONSTRUCTION.
- THE ELECTRICAL CONTRACTOR SHALL REFER TO THE ARCHITECTURAL & INTERIOR DESIGN DRAWINGS FOR EXACT LOCATIONS, MOUNTING HEIGHTS AND FINISHES OF DEVICES AND FIXTURES.
- REFER TO ENLARGED TYPICAL UNIT PLANS (E4 SERIES SHEETS) FOR TYPICAL POWER & LIGHTING LAYOUTS FOR THE RESIDENTIAL UNITS.
- REFER TO SHEET E1.21 FOR LIGHT FIXTURE SCHEDULE.
- REFER TO AVAILABLE ARCHITECTURAL AND/OR INTERIOR DESIGN DOCUMENTS & DRAWINGS FOR ADDITIONAL INFORMATION.
- OCCUPANCY SENSORS SHALL BE FIELD ADJUSTED TO ENSURE PROPER COVERAGE AND CONTROL.
- PROVIDE DIGITAL LIGHTING CONTROLS FOR EACH ROOM/SPACE, CONSISTING OF MULTI-BUTTON SWITCH(ES), OCC SENSORS, POWER PACKS, DAYLIGHT SENSORS, DIMMERS, INTERCONNECTING WIRING, ETC.
- CORRIDOR LIGHTING TO BE CONSTANT "ON" AND PROVIDED WITH LOCAL MANUAL OVERRIDE SWITCHES FOR MAINTENANCE. REFER TO SHEET E1.22 FOR SWITCH WIRING DIAGRAMS.
- ALL EGRESS FIXTURES SHALL BE WIRED SUCH THAT IN THE EVENT OF A POWER FAILURE, ALL LIGHTS WILL AUTOMATICALLY RETURN TO FULL POWER. REFER TO SWITCHING DETAILS ON SHEET E1.22.
- REFER TO SHEET E1.23 FOR LIGHTING CONTROL DIAGRAMS AND DESIGN INTENT. VERIFY LIGHTING CONTROLLABILITY WITH ARCHITECT AND/OR OWNER'S REPRESENTATIVE TO DETERMINE EXACT NEEDS FOR ALL PUBLIC/Common AREAS SUCH AS LOBBIES, OFFICES, LOUNGE AREAS, ETC., PRIOR TO THE START OF ANY WORK.
- THERE SHALL BE NO SURFACE MOUNTED FIXTURES OR PATHWAYS (CONDUIT, ETC.) IN ANY PUBLICLY ACCESSIBLE SPACES, INCLUDING STAIRWELLS AND EXIT PASSAGEWAYS WITHOUT PRIOR APPROVAL BY OWNER AND ARCHITECT. ROUTE ALL PATHWAYS WITHIN STUD CAVITIES OR ABOVE FINISHED CEILINGS.

KEYED NOTES:

- CONTINUE CIRCUIT UP THROUGH THE STAIRWELL.
- EXTERIOR BUILDING LIGHTS TO BE CONTROLLED VIA INTEGRAL AND/OR REMOTE PHOTOCELL FOR DUSK-TILL-DAWN OPERATION. REFER TO LIGHT FIXTURE SCHEDULE ON SHEET E1.21-E1.22 FOR ADDITIONAL INFORMATION.
- LIGHT FIXTURES IN THIS SPACE CONTROLLED BY CEILING MOUNT OCCUPANCY SENSOR.
- PROVIDE PHOTOCELL FOR DAY-LIGHT REDUCTION OF LIGHT LEVELS.
- CONTRACTOR TO COORDINATE WITH LANDSCAPE LIGHTING INSTALLER AND PROVIDE ROUGH-IN AND POWER CONNECTION(S) AS REQUIRED.
- REFER TO SHEET E1.12 FOR TYPICAL DWELLING UNIT LOAD CENTER SCHEDULE FOR CIRCUITING INFORMATION.
- REFER TO THE E3 SERIES SHEETS FOR TYPICAL DWELLING UNIT POWER DEVICE LAYOUT.

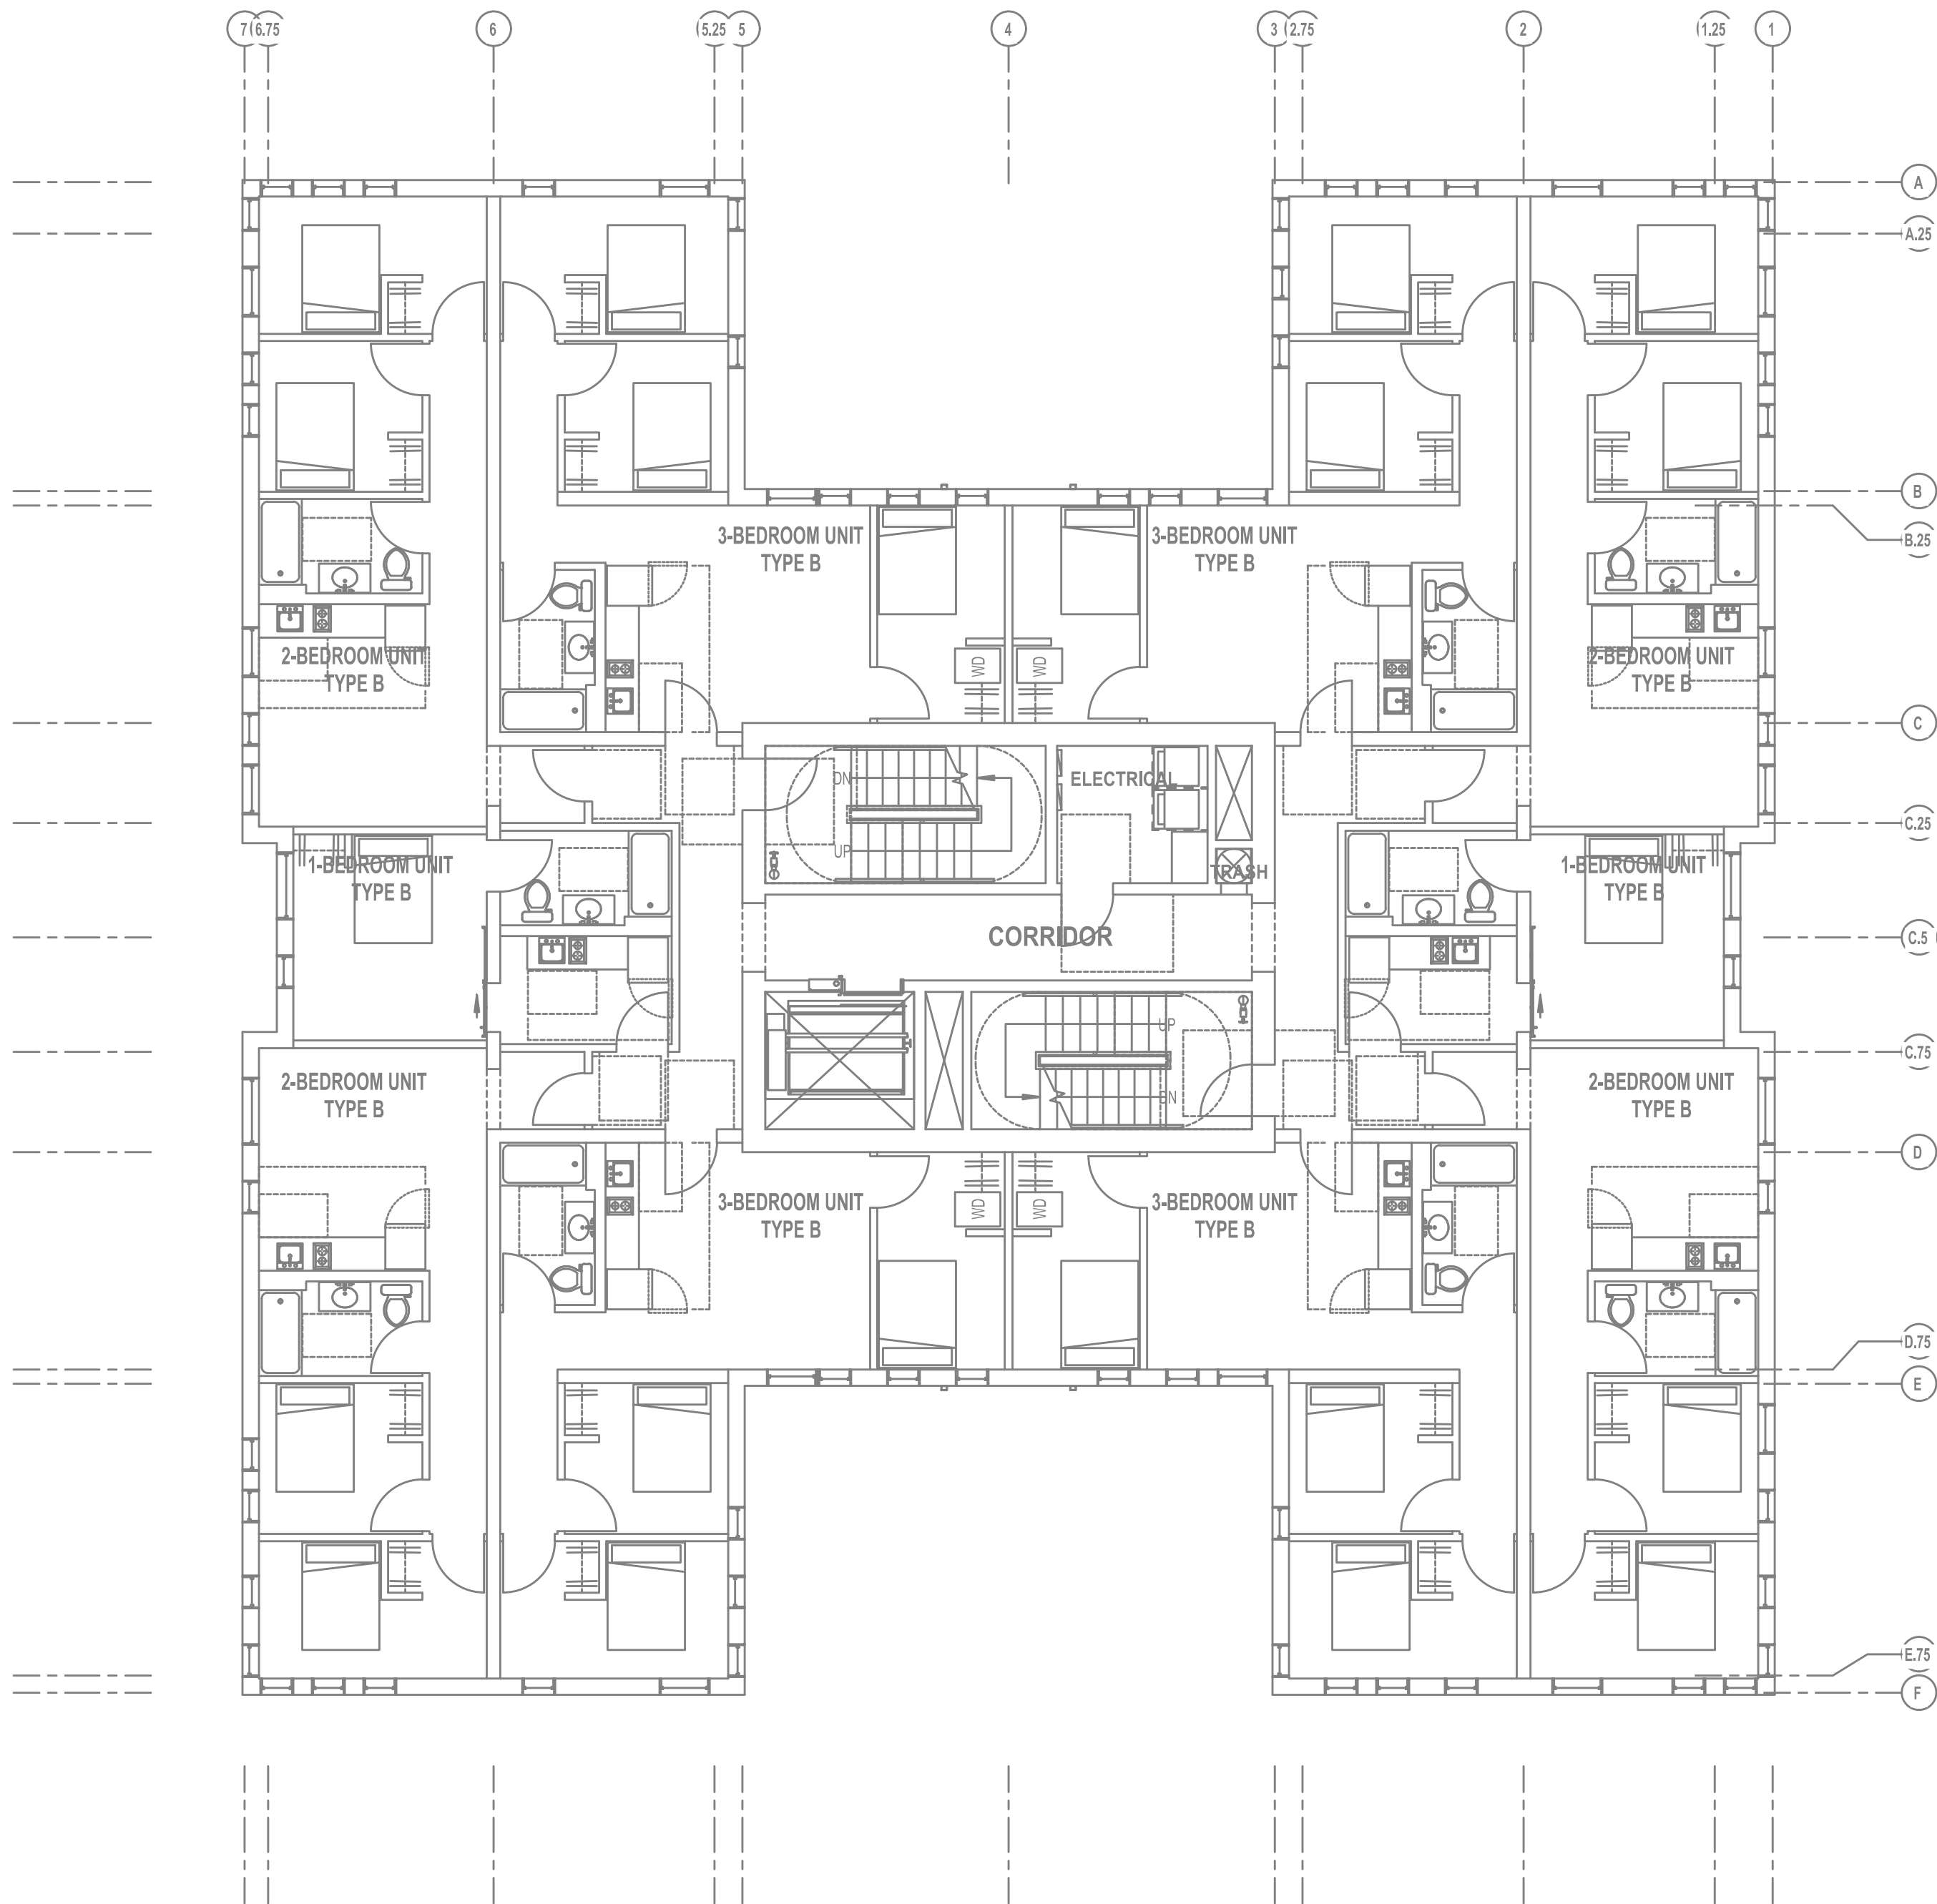

1 EIGHTH FLOOR LIGHTING PLAN
E2.08 SCALE: 1/8" = 1'-0"

PRELIMINARY
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PRELIMINARY
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DESIGN
DEVELOPMENT
SET

Issued:
PRELIMINARY 4.27.2021

Job #: 2020

ORIGINAL SHEET SIZE: 22" x 34"
HALF SIZE: 11" x 17"

ROOF LEVEL
LIGHTING PLAN

Drawing Number


E2.09

GENERAL LIGHTING NOTES:


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- THE ELECTRICAL CONTRACTOR SHALL REFER TO THE ARCHITECTURAL & INTERIOR DESIGN DRAWINGS FOR EXACT LOCATIONS, MOUNTING HEIGHTS AND FINISHES OF DEVICES AND FIXTURES.
- REFER TO ENLARGED TYPICAL UNIT PLANS (E4 SERIES SHEETS) FOR TYPICAL POWER & LIGHTING LAYOUTS FOR THE RESIDENTIAL UNITS.
- REFER TO SHEET E1.21 FOR LIGHT FIXTURE SCHEDULE.
- REFER TO AVAILABLE ARCHITECTURAL AND/OR INTERIOR DESIGN DOCUMENTS & DRAWINGS FOR ADDITIONAL INFORMATION.
- OCCUPANCY SENSORS SHALL BE FIELD ADJUSTED TO ENSURE PROPER COVERAGE AND CONTROL.
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- REFER TO SHEET E1.23 FOR LIGHTING CONTROL DIAGRAMS AND DESIGN INTENT. VERIFY LIGHTING CONTROLLABILITY WITH ARCHITECT AND/OR OWNER'S REPRESENTATIVE TO DETERMINE EXACT NEEDS FOR ALL PUBLIC/COMMON AREAS SUCH AS LOBBIES, OFFICES, LOUNGE AREAS, ETC., PRIOR TO THE START OF ANY WORK.
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KEYED NOTES:

- CONTINUE CIRCUIT UP THROUGH THE STAIRWELL.
- EXTERIOR BUILDING LIGHTS TO BE CONTROLLED VIA INTEGRAL AND/OR REMOTE PHOTOCELL FOR DUSK-TILL-DAWN OPERATION. REFER TO LIGHT FIXTURE SCHEDULE ON SHEET E1.21-E1.22 FOR ADDITIONAL INFORMATION.
- LIGHT FIXTURES IN THIS SPACE CONTROLLED BY CEILING MOUNT OCCUPANCY SENSOR.
- PROVIDE PHOTOCELL FOR DAY-LIGHT REDUCTION OF LIGHT LEVELS.
- CONTRACTOR TO COORDINATE WITH LANDSCAPE LIGHTING INSTALLER AND PROVIDE ROUGH-IN AND POWER CONNECTION(S) AS REQUIRED.
- REFER TO SHEET E1.12 FOR TYPICAL DWELLING UNIT LOAD CENTER SCHEDULE FOR CIRCUITING INFORMATION.
- REFER TO THE E3 SERIES SHEETS FOR TYPICAL DWELLING UNIT POWER DEVICE LAYOUT.

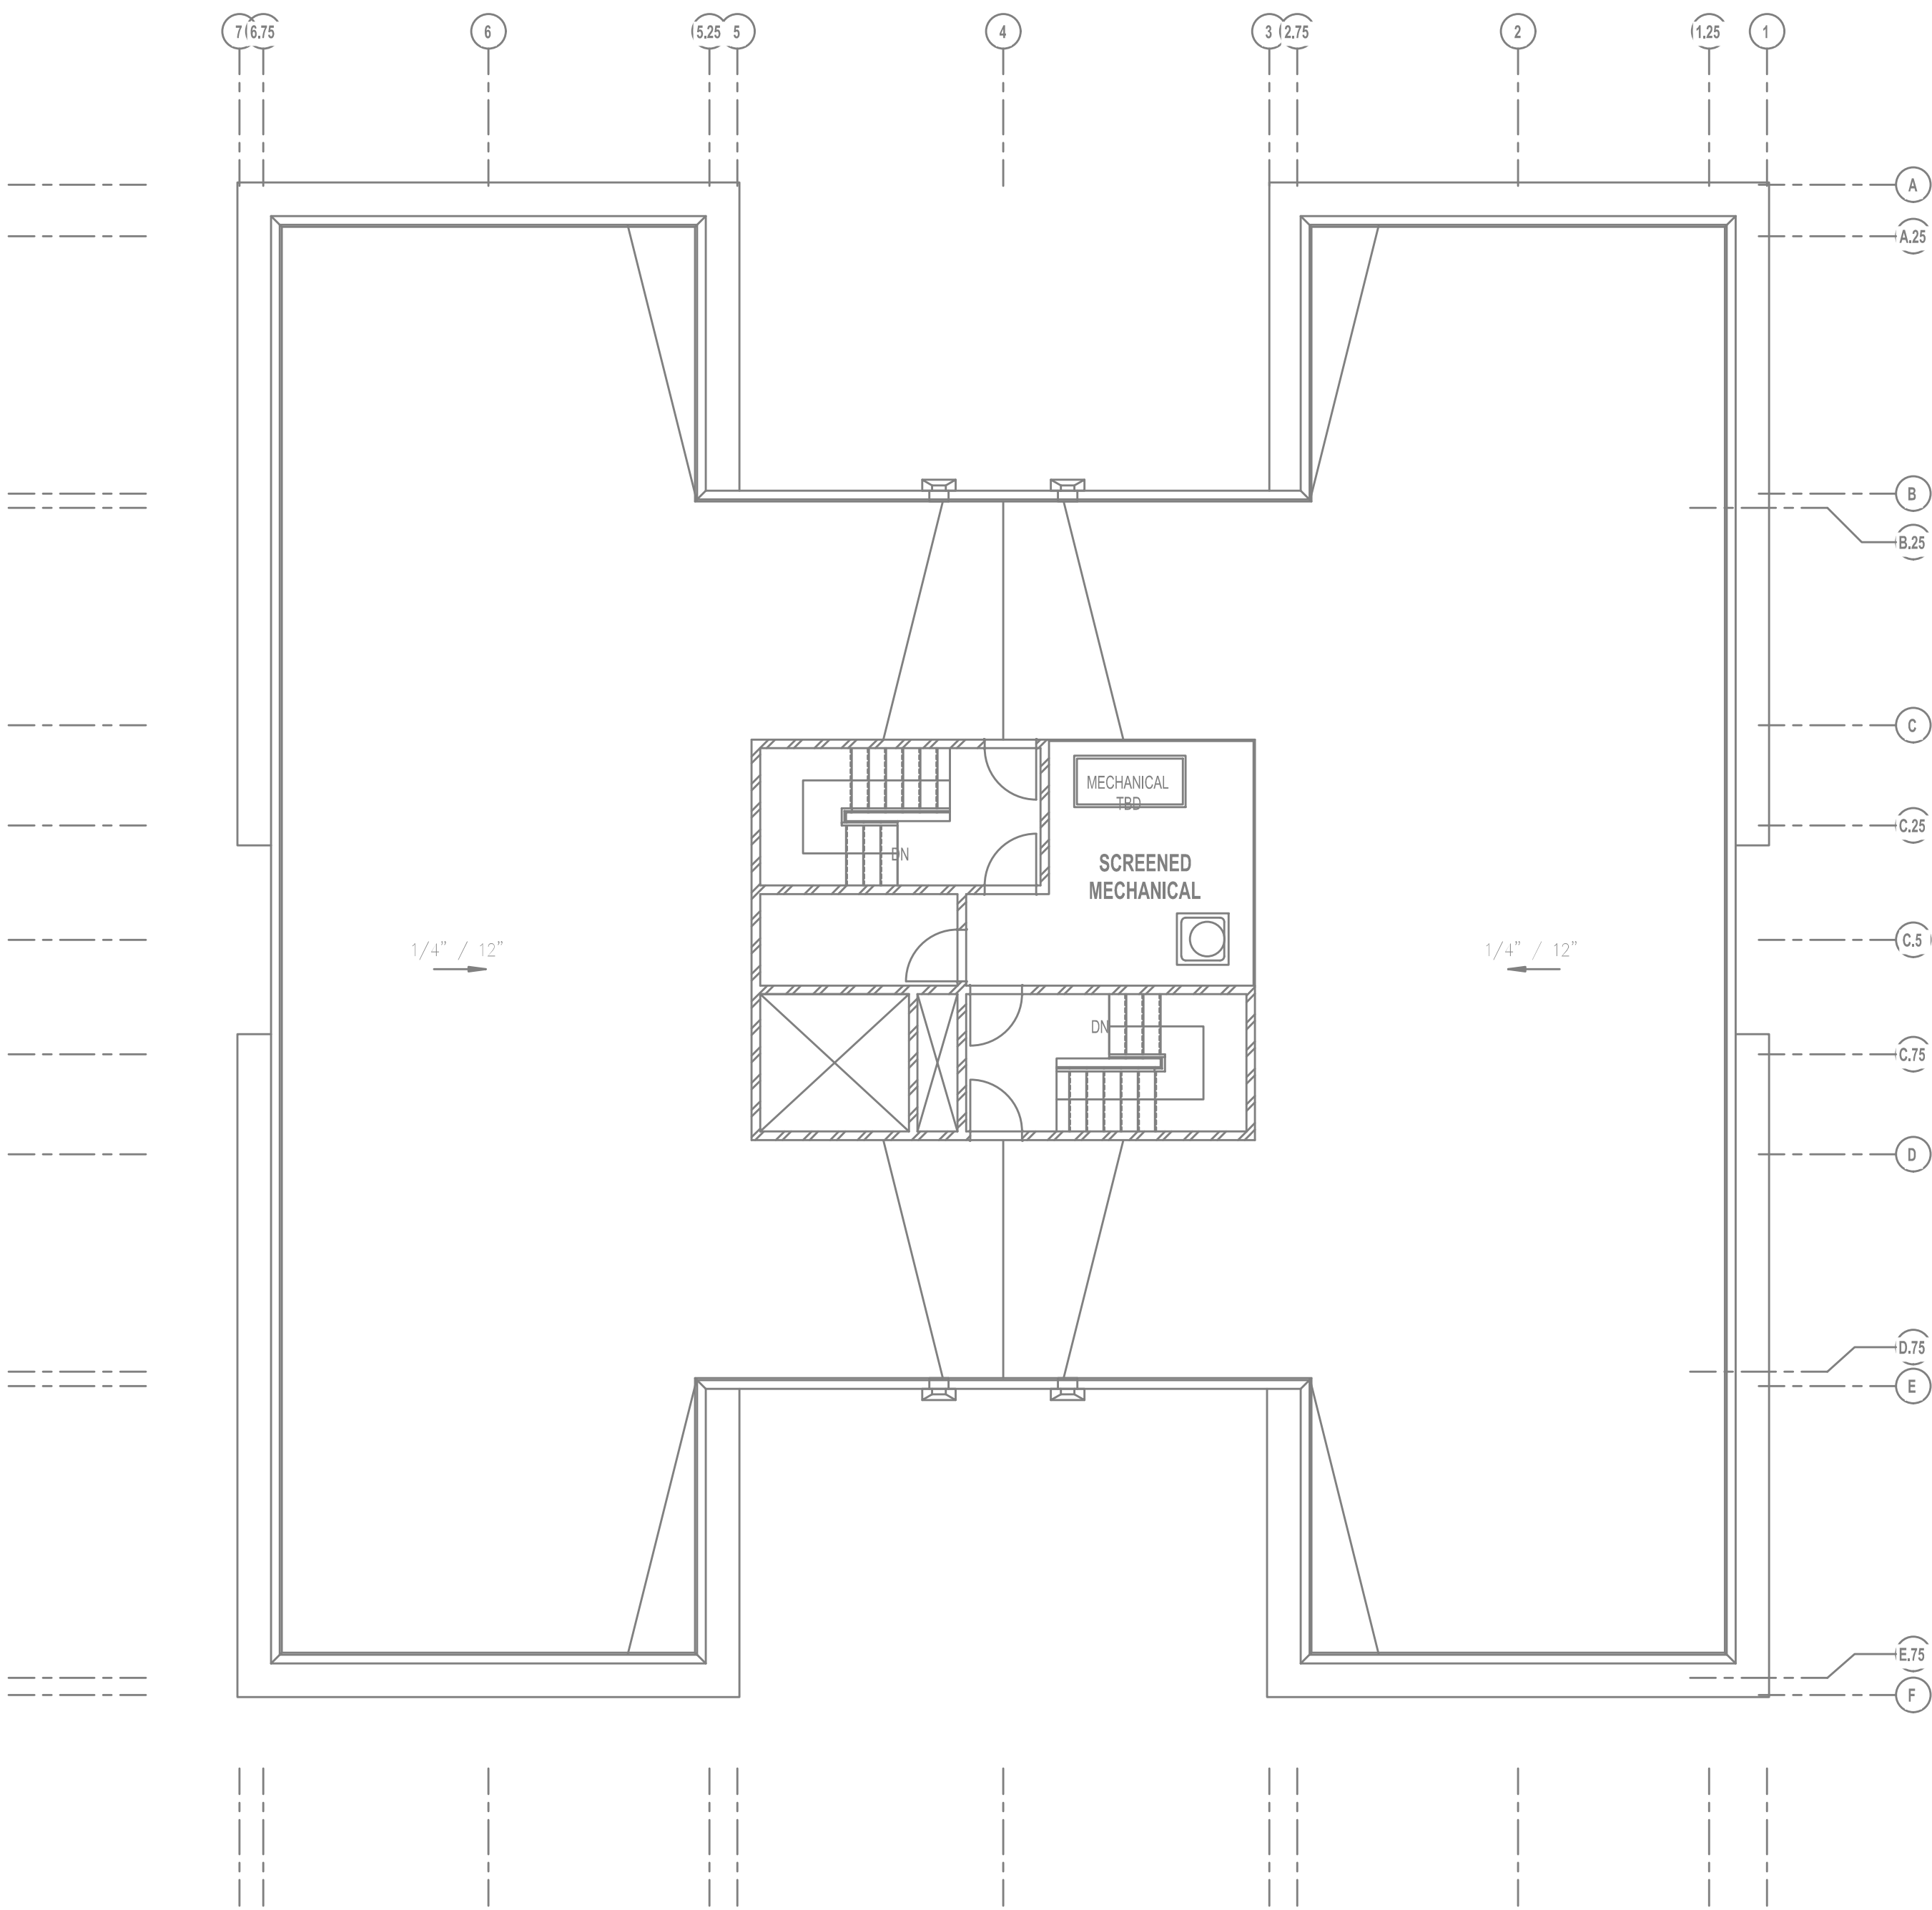

1 ROOF LEVEL LIGHTING PLAN
E2.09 SCALE: 1/8" = 1'-0"

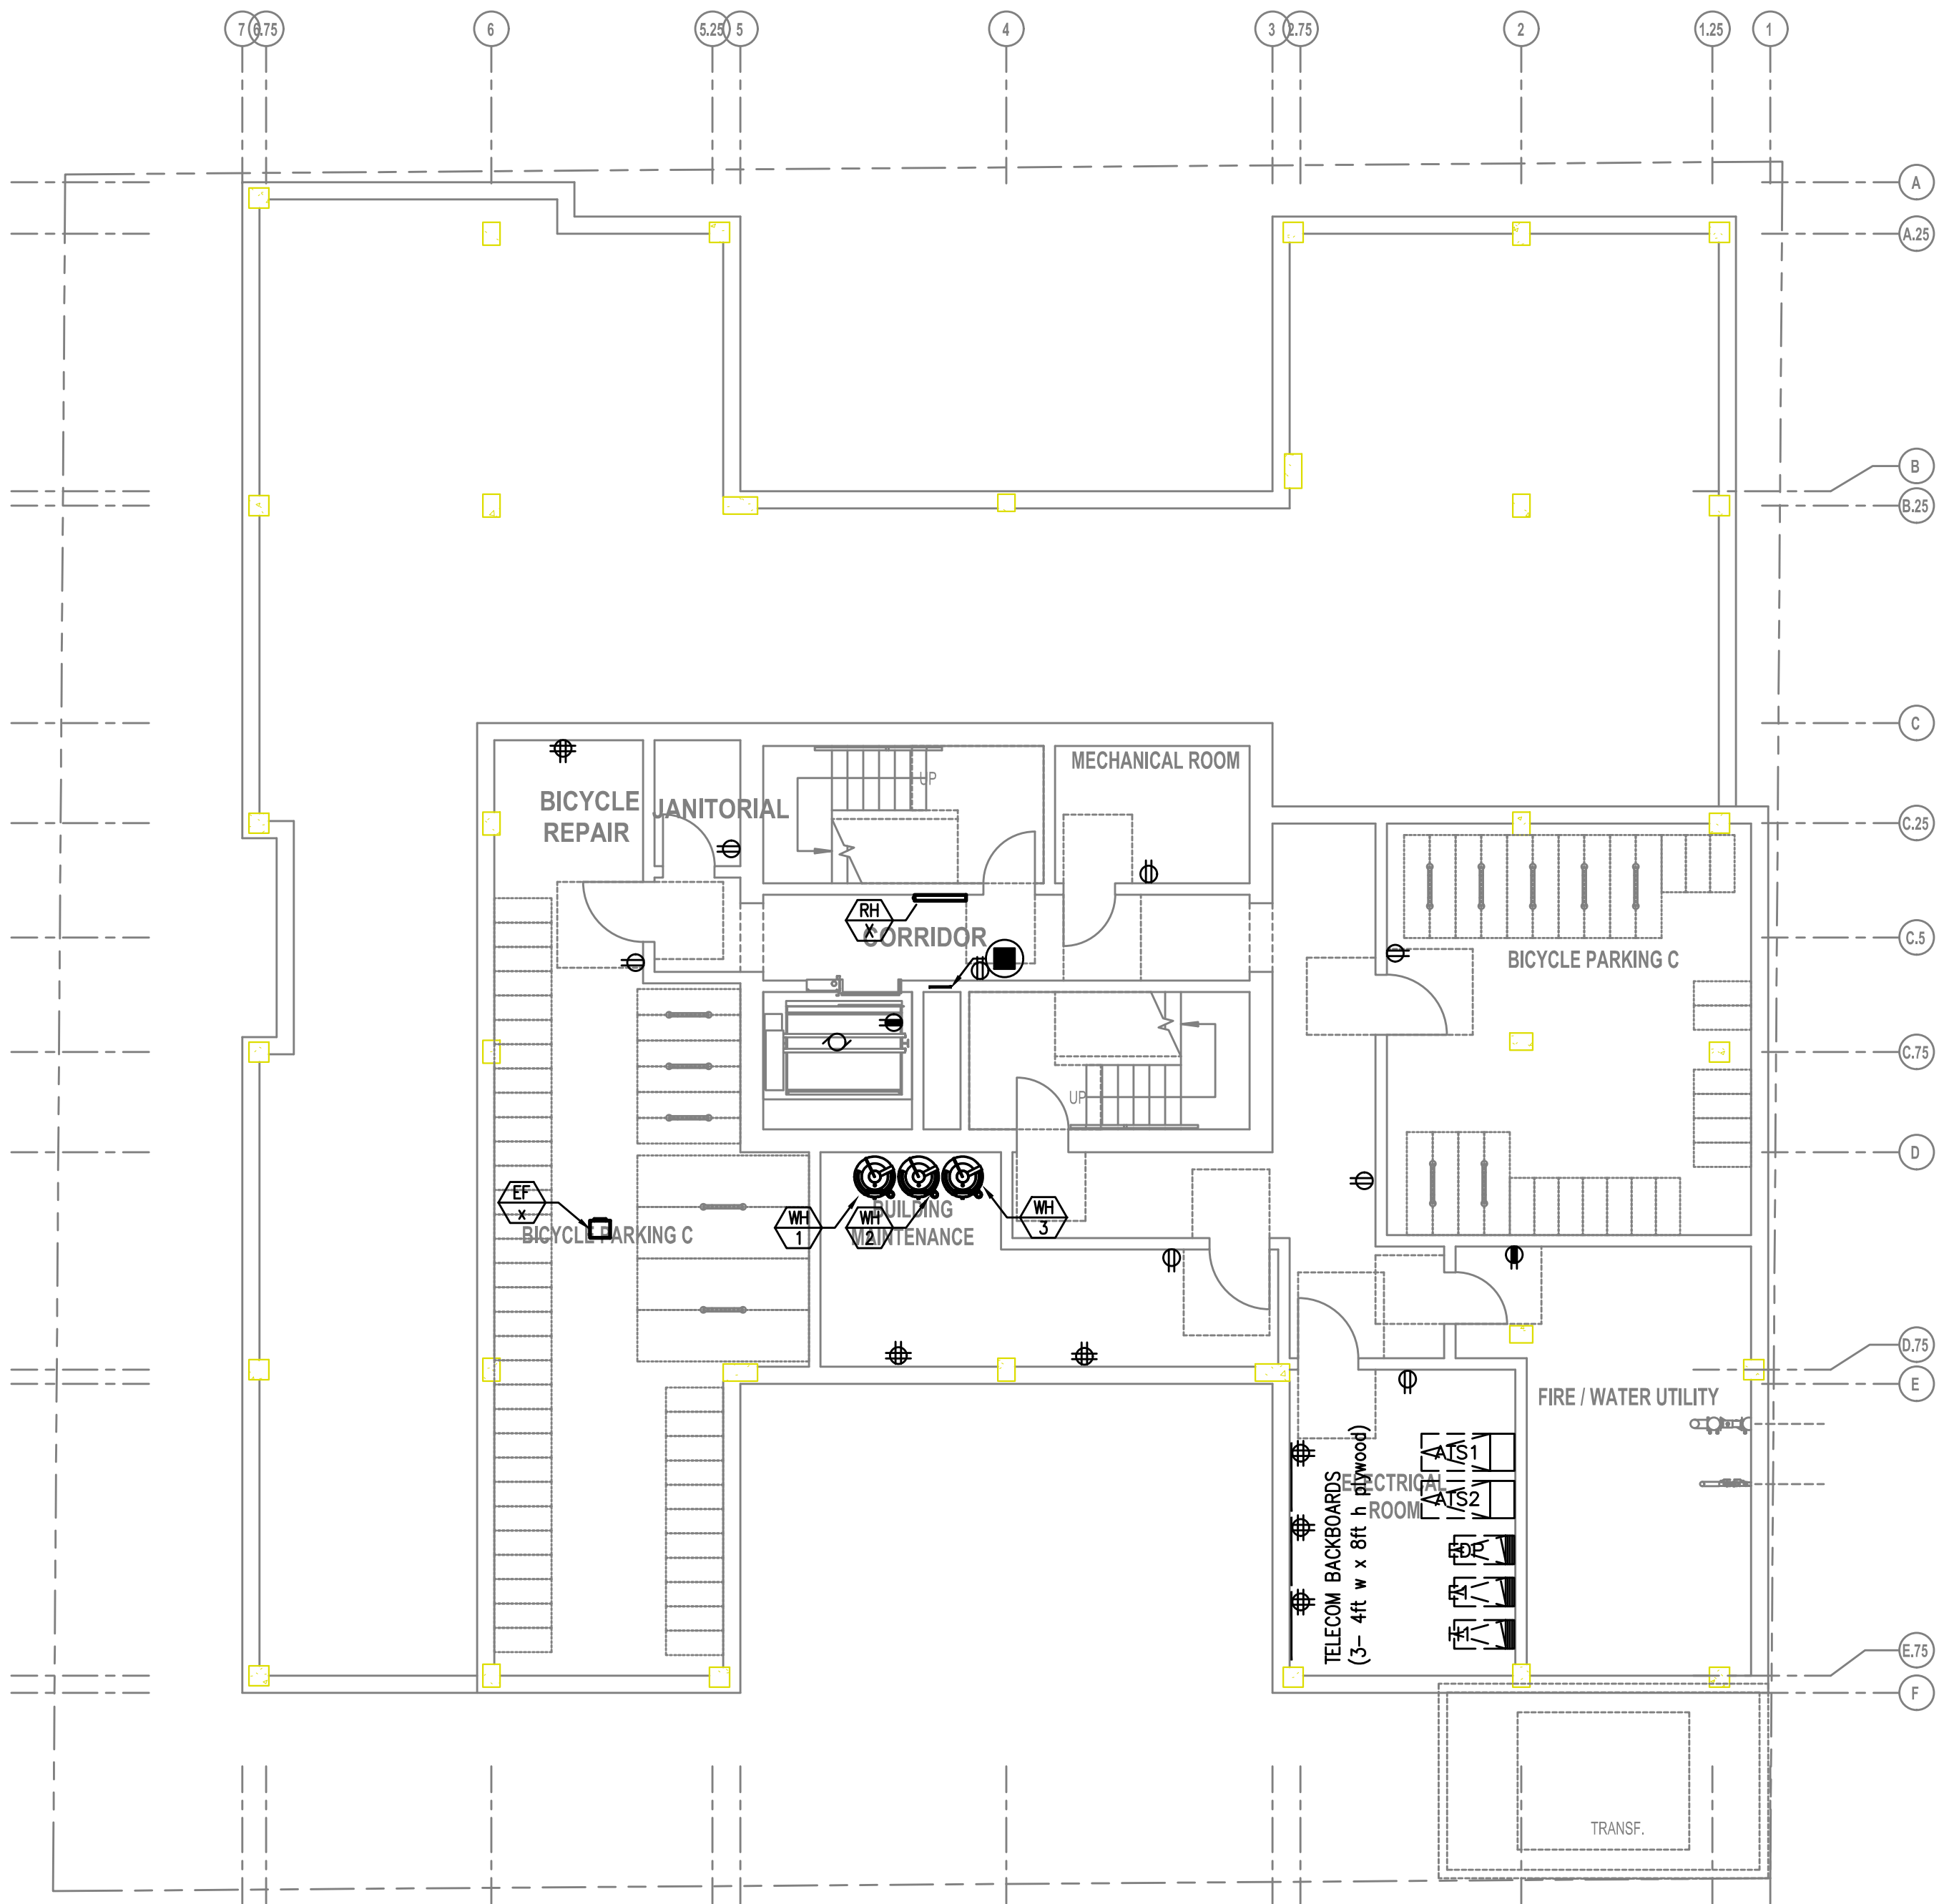

1 BASEMENT LEVEL POWER PLAN
E3.00 SCALE: 1/8" = 1'-0"

GENERAL POWER NOTES:

- A. ELECTRICAL DRAWINGS ARE DIAGRAMMATICAL AND MAY NOT ACCURATELY REFLECT ACTUAL CONSTRUCTION CONDITIONS. THE ELECTRICAL CONTRACTOR SHALL BE RESPONSIBLE FOR COORDINATING THE INSTALLATION OF ALL ELECTRICAL EQUIPMENT, WITH ALL TRADES PRIOR TO AND DURING CONSTRUCTION.
- B. WORK SHALL BE IN ACCORDANCE WITH ALL APPLICABLE LOCAL, STATE AND NATIONAL CODES.
- C. ELECTRICAL CONTRACTOR TO PROVIDE THERMOSTATS NOT SUPPLIED BY MECHANICAL CONTRACTOR, AS REQUIRED. CONSULT MECHANICAL PLANS FOR ADDITIONAL INFORMATION.
- D. ELECTRICAL CONTRACTOR SHALL PROVIDE INSTALLATION AND FINAL CONNECTION OF THERMOSTATS AS REQUIRED. CONSULT MECHANICAL CONTRACTOR FOR EXACT REQUIREMENTS PRIOR TO ROUGH IN.
- E. COORDINATE WITH DIVISION 23 FOR EXACT LOCATION AND POWER REQUIREMENTS OF ALL MECHANICAL EQUIPMENT PRIOR TO ROUGH IN. REFER TO SHEET E1.13 FOR MECHANICAL EQUIPMENT SCHEDULE.
- F. THE ELECTRICAL CONTRACTOR SHALL REFER TO THE ARCHITECTURAL DRAWINGS FOR ALL MOUNTING HEIGHTS AND FINISHES OF DEVICES AND FIXTURES.
- G. ELECTRICAL CONTRACTOR SHALL REFER TO THE 'T' SERIES SHEETS AND PROVIDE ROUGH IN FOR THE LOW VOLTAGE SYSTEMS/FIRE ALARM INSTALLER.
- H. SERVICE ENTRANCE AND METERING EQUIPMENT SHOWN TO APPROXIMATE SCALE, BASED ON SIEMENS PRODUCTS. CONTRACTOR SHALL BE RESPONSIBLE FOR ENSURING THAT INSTALLED EQUIPMENT FITS THE SPACE PROVIDED AND THAT ALL REQUIRED WORKING CLEARANCES ARE PROVIDED.
- J. PROVIDE A KEY BOX AT THE TRANSFORMER ROOM DOOR PER THE UTILITY PROVIDER'S REQUIREMENTS, FOR 24/7 ACCESS.
- L. REFER TO 'E4' SERIES SHEETS FOR TYPICAL DWELLING UNIT POWER PLANS.

KEYED POWER NOTES:

- 1. PROVIDE KEY BOX FOR PGE AT METER ROOM FOR 24/7 ACCESS.
- 2. GENERATOR EMERGENCY DISCONNECT.
- 3. LAUNDRY ROOM GFCI RECEPTACLES FOR WASHING MACHINES TO BE MOUNTED AT 42" A.F.F., OR UNLESS OTHERWISE DIRECTED BY THE ARCHITECT. LAUNDRY ROOM APPLIANCES CIRCUITED TO PANEL 'XX'. REFER TO PANEL SCHEDULE ON SHEET E1.12.
- 4. 40A, DEDICATED 14-40R DRYER RECEPTACLE (TYPICAL). VERIFY EXACT POWER RATING REQUIRED FOR THE COMMERCIAL DRYERS PRIOR TO ORDERING. LAUNDRY ROOM APPLIANCES CIRCUITED TO PANEL 'XX'. REFER TO PANEL SCHEDULE ON SHEET E1.12.
- 5. EXHAUST FAN IN THIS AREA TO BE TIED INTO THE LIGHTING CIRCUIT.
- 6. CONSULT ELEVATOR PROVIDER FOR EXACT POWER REQUIREMENTS AND PROVIDE ALL ELECTRICAL WORK AS DIRECTED. VERIFY EXACT LOCATION FOR ELEVATOR EQUIPMENT WITH ARCHITECT AND COORDINATE WITH ELEVATOR INSTALLER.
- 7. PROVIDE ROUGH IN AND WIRING FOR ACCESS CONTROL. REFER TO 'T' SERIES SHEETS FOR ADDITIONAL INFORMATION.
- 8. LOW VOLTAGE/COMMUNICATIONS SYSTEM DEMARCATION BOARD(S). COORDINATE LOCATIONS AND ELECTRICAL POWER REQUIREMENTS WITH THE TELECOM PLANS ('T' SERIES SHEETS) AND LOW VOLTAGE SYSTEMS INSTALLERS. PROVIDE ROUGH IN AND/OR FINAL ELECTRICAL POWER CONNECTIONS & DEVICES. REFER PANEL 'XX' SCHEDULE ON E1.12 FOR CIRCUITS.
- 9. REFER TO SHEET E1.12 FOR TYPICAL DWELLING UNIT LOAD CENTER SCHEDULE FOR CIRCUITING INFORMATION.
- 10. REFER TO E2 SERIES SHEETS FOR EXHAUST FAN SWITCH LOCATION (WHERE INSTALLED).
- 11. EACH UNIT LOAD CENTER TO BE FED VIA SUB-METERING SYSTEM. REFER TO ONE-LINE DIAGRAM ON SHEET E1.11 FOR CONDUCTOR SIZE AND CABLING.

PRELIMINARY
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CONSTRUCTION

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CONTACT: DENISE TAYLOR
Project Owner:
NATIVE LAND DEVELOPMENT

Project Name:
MINNESOTA
PLACES

1208 N. JESSUP &
5627 N. MINNESOTA
(R226159, R226160)


PRELIMINARY
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DESIGN
DEVELOPMENT
SET

Issued:	
PRELIMINARY	4.27.2021
Job #:	2020
ORIGINAL SHEET SIZE: 22" x 34" HALF SIZE: 11" x 17"	

BASEMENT
LEVEL
POWER PLAN

Drawing Number
E3.00

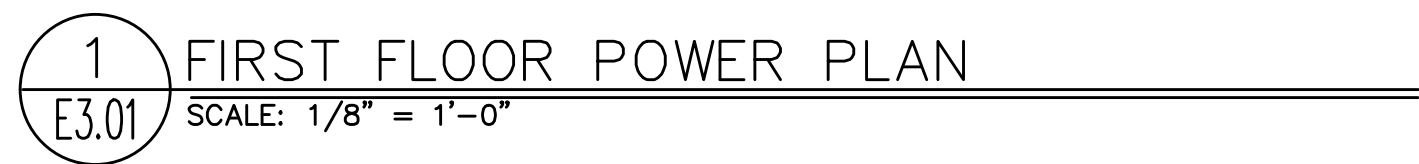

1. PROVIDE KEY BOX FOR PGE AT METER ROOM FOR 24/7 ACCESS.
2. GENERATOR EMERGENCY DISCONNECT.
3. LAUNDRY ROOM GFCI RECEPTACLES FOR WASHING MACHINES TO BE MOUNTED AT 42" A.F.F., OR UNLESS OTHERWISE DIRECTED BY THE ARCHITECT. LAUNDRY ROOM APPLIANCES CIRCUITED TO PANEL 'XX'. REFER TO PANEL SCHEDULE ON SHEET E1.12.
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5. EXHAUST FAN IN THIS AREA TO BE TIED INTO THE LIGHTING CIRCUIT.
6. CONSULT ELEVATOR PROVIDER FOR EXACT POWER REQUIREMENTS AND PROVIDE ALL ELECTRICAL WORK AS DIRECTED. VERIFY EXACT LOCATION FOR ELEVATOR EQUIPMENT WITH ARCHITECT AND COORDINATE WITH ELEVATOR INSTALLER.
7. PROVIDE ROUGH IN AND WIRING FOR ACCESS CONTROL. REFER TO 'T' SERIES SHEETS FOR ADDITIONAL INFORMATION.
8. LOW VOLTAGE/COMMUNICATIONS SYSTEM DEMARCATION BOARD(S). COORDINATE LOCATIONS AND ELECTRICAL POWER REQUIREMENTS WITH THE TELECOM PLANS ('T' SERIES SHEETS) AND LOW VOLTAGE SYSTEMS INSTALLERS. PROVIDE ROUGH IN AND/OR FINAL ELECTRICAL POWER CONNECTIONS & DEVICES. REFER PANEL 'XX' SCHEDULE ON E1.12 FOR CIRCUITS.
9. REFER TO SHEET E1.12 FOR TYPICAL DWELLING UNIT LOAD CENTER SCHEDULE FOR CIRCUITING INFORMATION.
10. REFER TO E2 SERIES SHEETS FOR EXHAUST FAN SWITCH LOCATION (WHERE INSTALLED).
11. EACH UNIT LOAD CENTER TO BE FED VIA SUB-METERING SYSTEM. REFER TO ONE-LINE DIAGRAM ON SHEET E1.11 FOR CONDUCTOR SIZE AND CABLING.



- A. ELECTRICAL DRAWINGS ARE DIAGRAMMATIC AND MAY NOT ACCURATELY REFLECT ACTUAL CONSTRUCTION CONDITIONS. THE ELECTRICAL CONTRACTOR SHALL BE RESPONSIBLE FOR COORDINATING THE INSTALLATION OF ALL ELECTRICAL EQUIPMENT, WITH ALL TRADES PRIOR TO AND DURING CONSTRUCTION.
- B. WORK SHALL BE IN ACCORDANCE WITH ALL APPLICABLE LOCAL, STATE AND NATIONAL CODES.
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- D. ELECTRICAL CONTRACTOR SHALL PROVIDE INSTALLATION AND FINAL CONNECTION OF THERMOSTATS AS REQUIRED. CONSULT MECHANICAL CONTRACTOR FOR EXACT REQUIREMENTS PRIOR TO ROUGH IN.
- E. COORDINATE WITH DIVISION 23 FOR EXACT LOCATION AND POWER REQUIREMENTS OF ALL MECHANICAL EQUIPMENT PRIOR TO ROUGH IN. REFER TO SHEET E1.13 FOR MECHANICAL EQUIPMENT SCHEDULE.
- F. THE ELECTRICAL CONTRACTOR SHALL REFER TO THE ARCHITECTURAL DRAWINGS FOR ALL MOUNTING HEIGHTS AND FINISHES OF DEVICES AND FIXTURES.
- G. ELECTRICAL CONTRACTOR SHALL REFER TO THE 'I' SERIES SHEETS AND PROVIDE ROUGH IN FOR THE LOW VOLTAGE SYSTEMS/FIRE ALARM INSTALLER.
- H. SERVICE ENTRANCE AND METERING EQUIPMENT SHOWN TO APPROXIMATE SCALE, BASED ON SIEMENS PRODUCTS. CONTRACTOR SHALL BE RESPONSIBLE FOR ENSURING THAT INSTALLED EQUIPMENT FITS THE SPACE PROVIDED AND THAT ALL REQUIRED WORKING CLEARANCES ARE PROVIDED.
- J. PROVIDE A KEY BOX AT THE TRANSFORMER ROOM DOOR PER THE UTILITY PROVIDER'S REQUIREMENTS, FOR 24/7 ACCESS.
- L. REFER TO 'E4' SERIES SHEETS FOR TYPICAL DWELLING UNIT POWER PLANS.

1. PROVIDE KEY BOX FOR PGE AT METER ROOM FOR 24/7 ACCESS.
2. GENERATOR EMERGENCY DISCONNECT.
3. LAUNDRY ROOM GFCI RECEPTACLES FOR WASHING MACHINES TO BE MOUNTED AT 42" A.F.F., OR UNLESS OTHERWISE DIRECTED BY THE ARCHITECT. LAUNDRY ROOM APPLIANCES CIRCUITED TO PANEL 'XX'. REFER TO PANEL SCHEDULE ON SHEET E1.12
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5. EXHAUST FAN IN THIS AREA TO BE TIED INTO THE LIGHTING CIRCUIT.
6. CONSULT ELEVATOR PROVIDER FOR EXACT POWER REQUIREMENTS AND PROVIDE ALL ELECTRICAL WORK AS DIRECTED. VERIFY EXACT LOCATION FOR ELEVATOR EQUIPMENT WITH ARCHITECT AND COORDINATE WITH ELEVATOR INSTALLER.
7. PROVIDE ROUGH IN AND WIRING FOR ACCESS CONTROL. REFER TO 'T' SERIES SHEETS FOR ADDITIONAL INFORMATION.
8. LOW VOLTAGE/COMMUNICATIONS SYSTEM DEMARCATION BOARD(S). COORDINATE LOCATIONS AND ELECTRICAL POWER REQUIREMENTS WITH THE TELECOM PLANS ('T' SERIES SHEETS) AND LOW VOLTAGE SYSTEMS INSTALLERS. PROVIDE ROUGH IN AND/OR FINAL ELECTRICAL POWER CONNECTIONS & DEVICES. REFER PANEL 'XX' SCHEDULE ON E1.12 FOR CIRCUITS.
9. REFER TO SHEET E1.12 FOR TYPICAL DWELLING UNIT LOAD CENTER SCHEDULE FOR CIRCUITING INFORMATION.
10. REFER TO E2 SERIES SHEETS FOR EXHAUST FAN SWITCH LOCATION (WHERE INSTALLED).
11. EACH UNIT LOAD CENTER TO BE FED VIA SUB-METERING SYSTEM. REFER TO ONE-LINE DIAGRAM ON SHEET E1.11 FOR CONDUCTOR SIZE AND CABLING.

PRELIMINARY
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MINNESOTA PLACES

1208 N. JESSUP &
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(R226159, R226160)

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DESIGN DEVELOPMENT SET

Issued:

PRELIMINARY 4.27.2021


Job #: 2020

ORIGINAL SHEET SIZE: 22" x 34"
HALF SIZE: 11" x 17"

SECOND FLOOR POWER PLAN

Drawing Number

E3.02

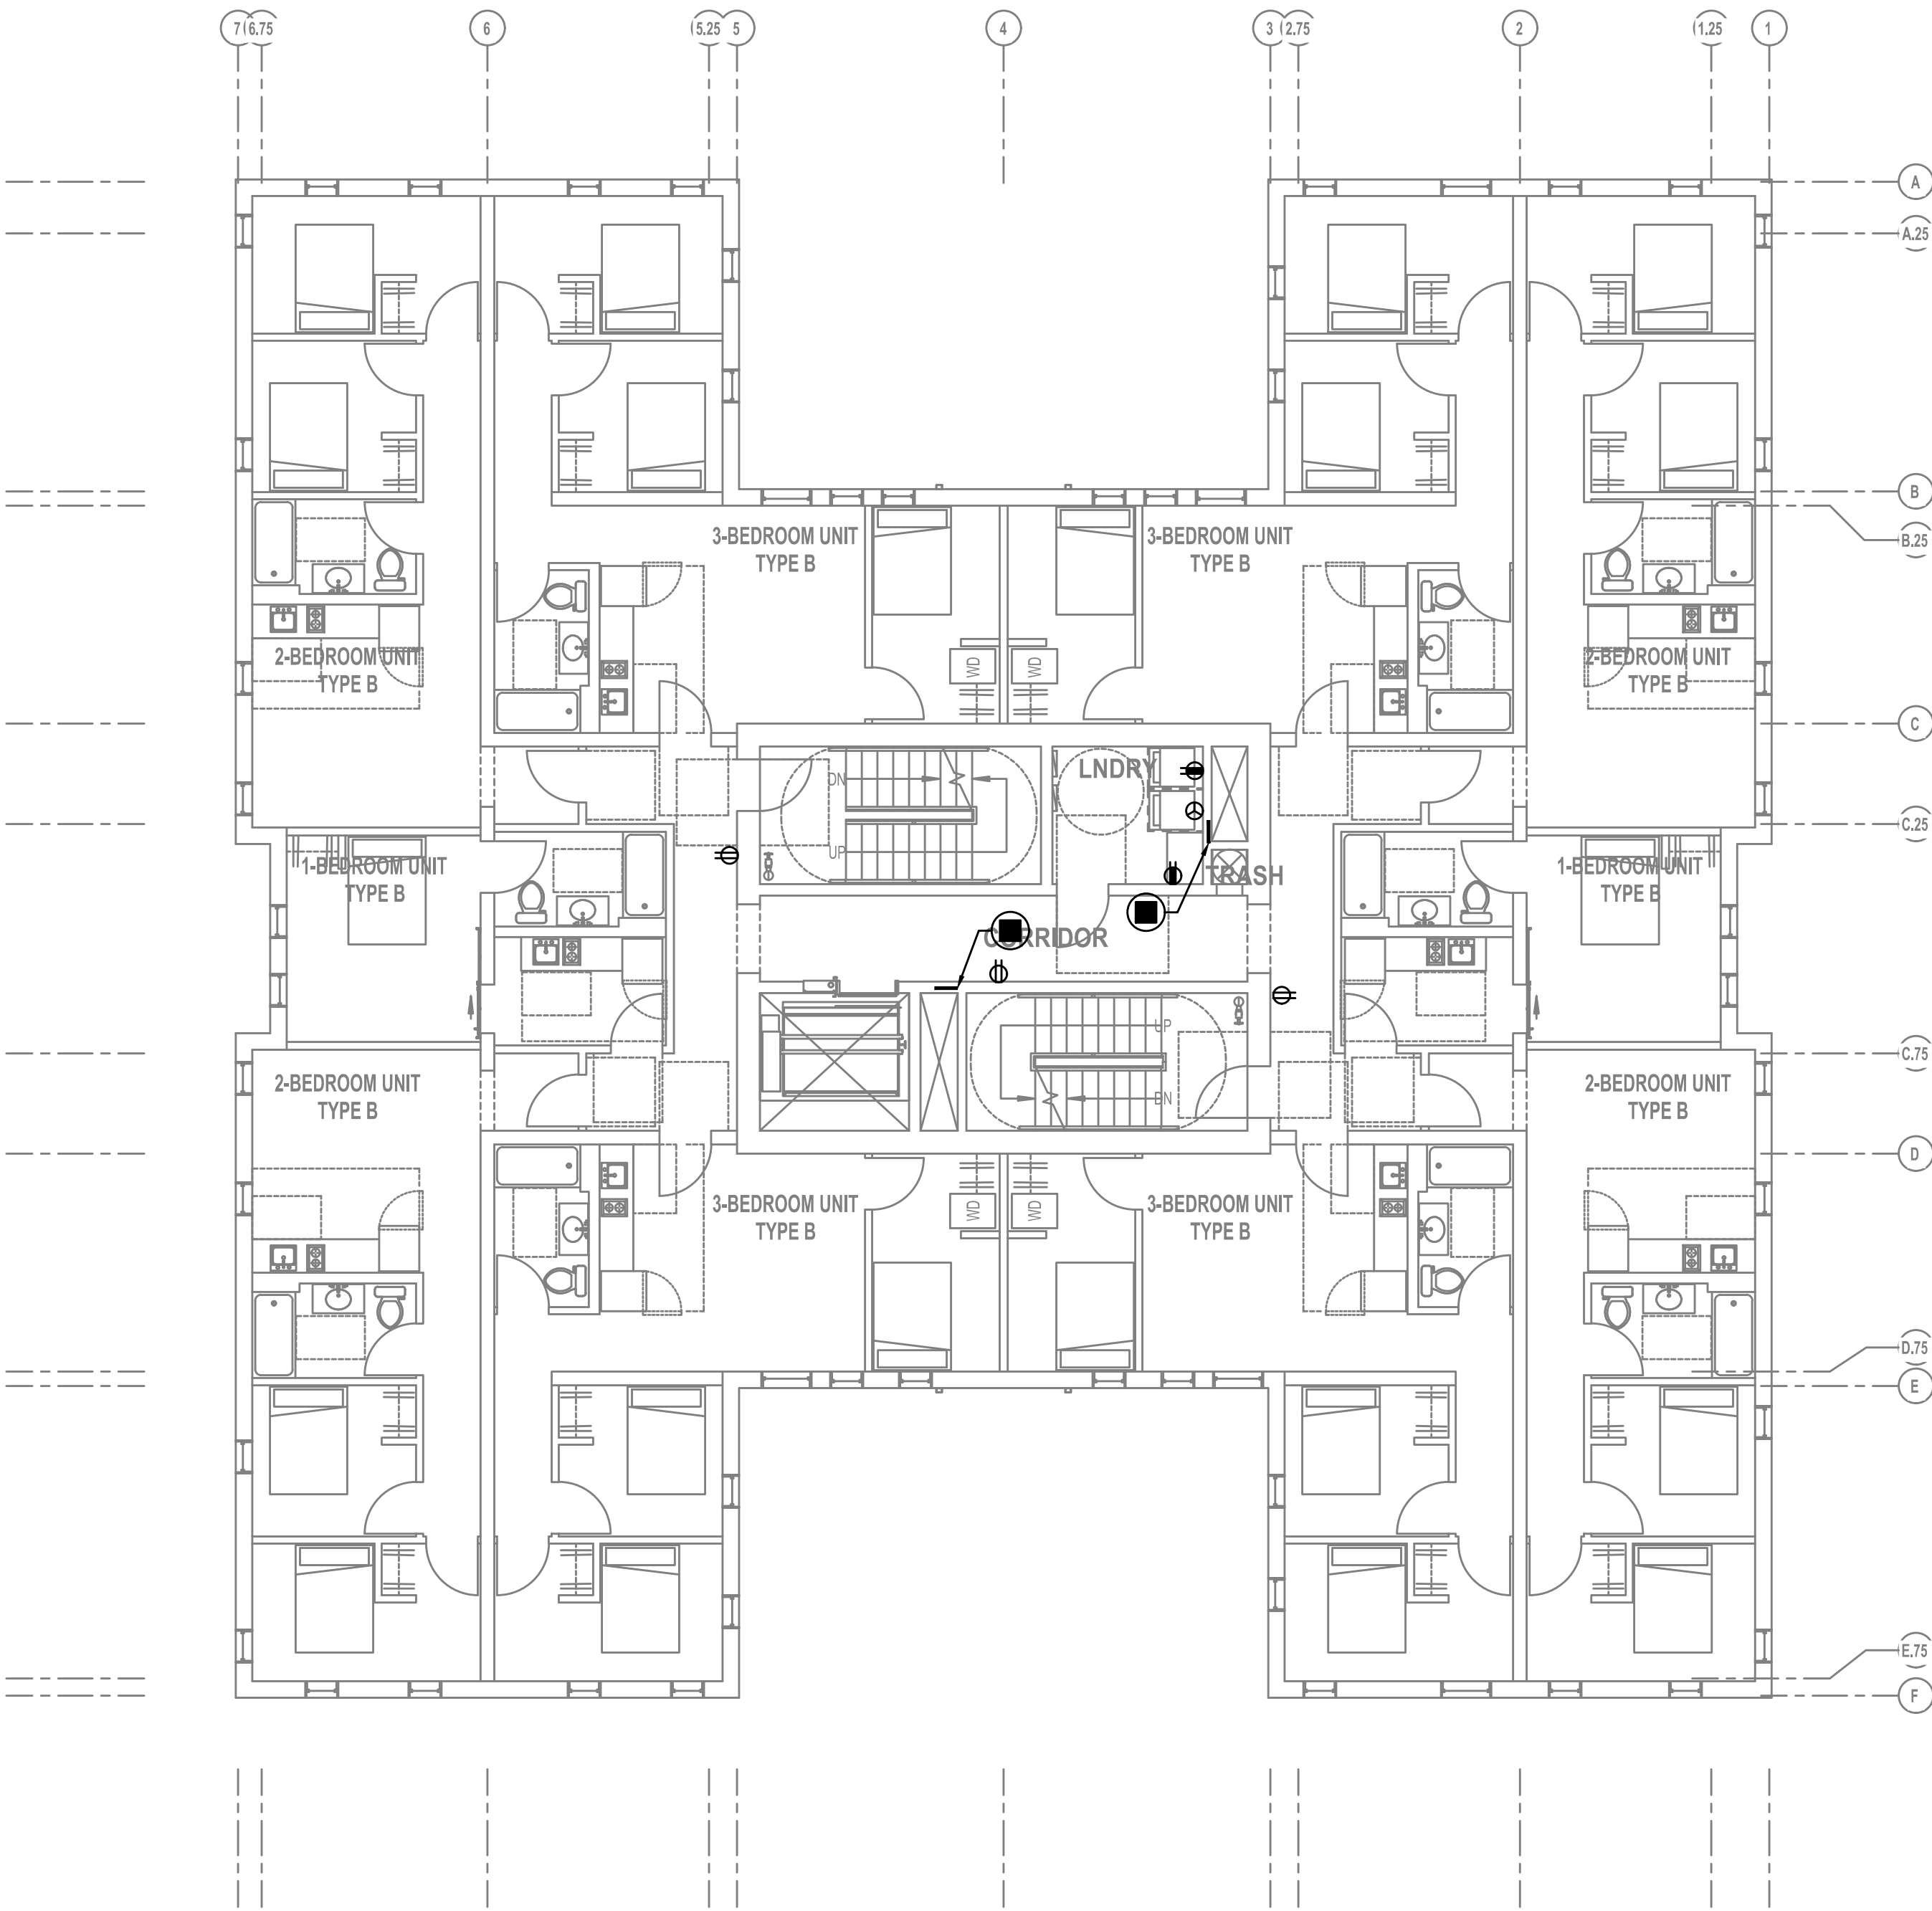

1 THIRD FLOOR POWER PLAN
E3.03 SCALE: 1/8" = 1'-0"

GENERAL POWER NOTES:

- A. ELECTRICAL DRAWINGS ARE DIAGRAMMATICAL AND MAY NOT ACCURATELY REFLECT ACTUAL CONSTRUCTION CONDITIONS. THE ELECTRICAL CONTRACTOR SHALL BE RESPONSIBLE FOR COORDINATING THE INSTALLATION OF ALL ELECTRICAL EQUIPMENT, WITH ALL TRADES PRIOR TO AND DURING CONSTRUCTION.
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- E. COORDINATE WITH DIVISION 23 FOR EXACT LOCATION AND POWER REQUIREMENTS OF ALL MECHANICAL EQUIPMENT PRIOR TO ROUGH IN. REFER TO SHEET E1.13 FOR MECHANICAL EQUIPMENT SCHEDULE.
- F. THE ELECTRICAL CONTRACTOR SHALL REFER TO THE ARCHITECTURAL DRAWINGS FOR ALL MOUNTING HEIGHTS AND FINISHES OF DEVICES AND FIXTURES.
- G. ELECTRICAL CONTRACTOR SHALL REFER TO THE 'T' SERIES SHEETS AND PROVIDE ROUGH IN FOR THE LOW VOLTAGE SYSTEMS/FIRE ALARM INSTALLER.
- H. SERVICE ENTRANCE AND METERING EQUIPMENT SHOWN TO APPROXIMATE SCALE, BASED ON SIEMENS PRODUCTS. CONTRACTOR SHALL BE RESPONSIBLE FOR ENSURING THAT INSTALLED EQUIPMENT FITS THE SPACE PROVIDED AND THAT ALL REQUIRED WORKING CLEARANCES ARE PROVIDED.
- J. PROVIDE A KEY BOX AT THE TRANSFORMER ROOM DOOR PER THE UTILITY PROVIDER'S REQUIREMENTS, FOR 24/7 ACCESS.
- L. REFER TO 'E4' SERIES SHEETS FOR TYPICAL DWELLING UNIT POWER PLANS.

KEYED POWER NOTES:

- 1. PROVIDE KEY BOX FOR PGE AT METER ROOM FOR 24/7 ACCESS.
- 2. GENERATOR EMERGENCY DISCONNECT.
- 3. LAUNDRY ROOM GFCI RECEPTACLES FOR WASHING MACHINES TO BE MOUNTED AT 42" A.F.F., OR UNLESS OTHERWISE DIRECTED BY THE ARCHITECT. LAUNDRY ROOM APPLIANCES CIRCUITED TO PANEL 'XX'. REFER TO PANEL SCHEDULE ON SHEET E1.12.
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- 5. EXHAUST FAN IN THIS AREA TO BE TIED INTO THE LIGHTING CIRCUIT.
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- 7. PROVIDE ROUGH IN AND WIRING FOR ACCESS CONTROL. REFER TO 'T' SERIES SHEETS FOR ADDITIONAL INFORMATION.
- 8. LOW VOLTAGE/COMMUNICATIONS SYSTEM DEMARCATION BOARD(S). COORDINATE LOCATIONS AND ELECTRICAL POWER REQUIREMENTS WITH THE TELECOM PLANS ('T' SERIES SHEETS) AND LOW VOLTAGE SYSTEMS INSTALLERS. PROVIDE ROUGH IN AND/OR FINAL ELECTRICAL POWER CONNECTIONS & DEVICES. REFER PANEL 'XX' SCHEDULE ON E1.12 FOR CIRCUITS.
- 9. REFER TO SHEET E1.12 FOR TYPICAL DWELLING UNIT LOAD CENTER SCHEDULE FOR CIRCUITING INFORMATION.
- 10. REFER TO E2 SERIES SHEETS FOR EXHAUST FAN SWITCH LOCATION (WHERE INSTALLED).
- 11. EACH UNIT LOAD CENTER TO BE FED VIA SUB-METERING SYSTEM. REFER TO ONE-LINE DIAGRAM ON SHEET E1.11 FOR CONDUCTOR SIZE AND CABLING.

PRELIMINARY
NOT FOR
CONSTRUCTION

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Project Owner:
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Project Name:
MINNESOTA
PLACES


1208 N. JESSUP &
5627 N. MINNESOTA
(R226159, R226160)

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DEVELOPMENT
SET

Issued:	
PRELIMINARY	4.27.2021
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ORIGINAL SHEET SIZE: 22" x 34" HALF SIZE: 11" x 17"	

THIRD FLOOR
POWER PLAN

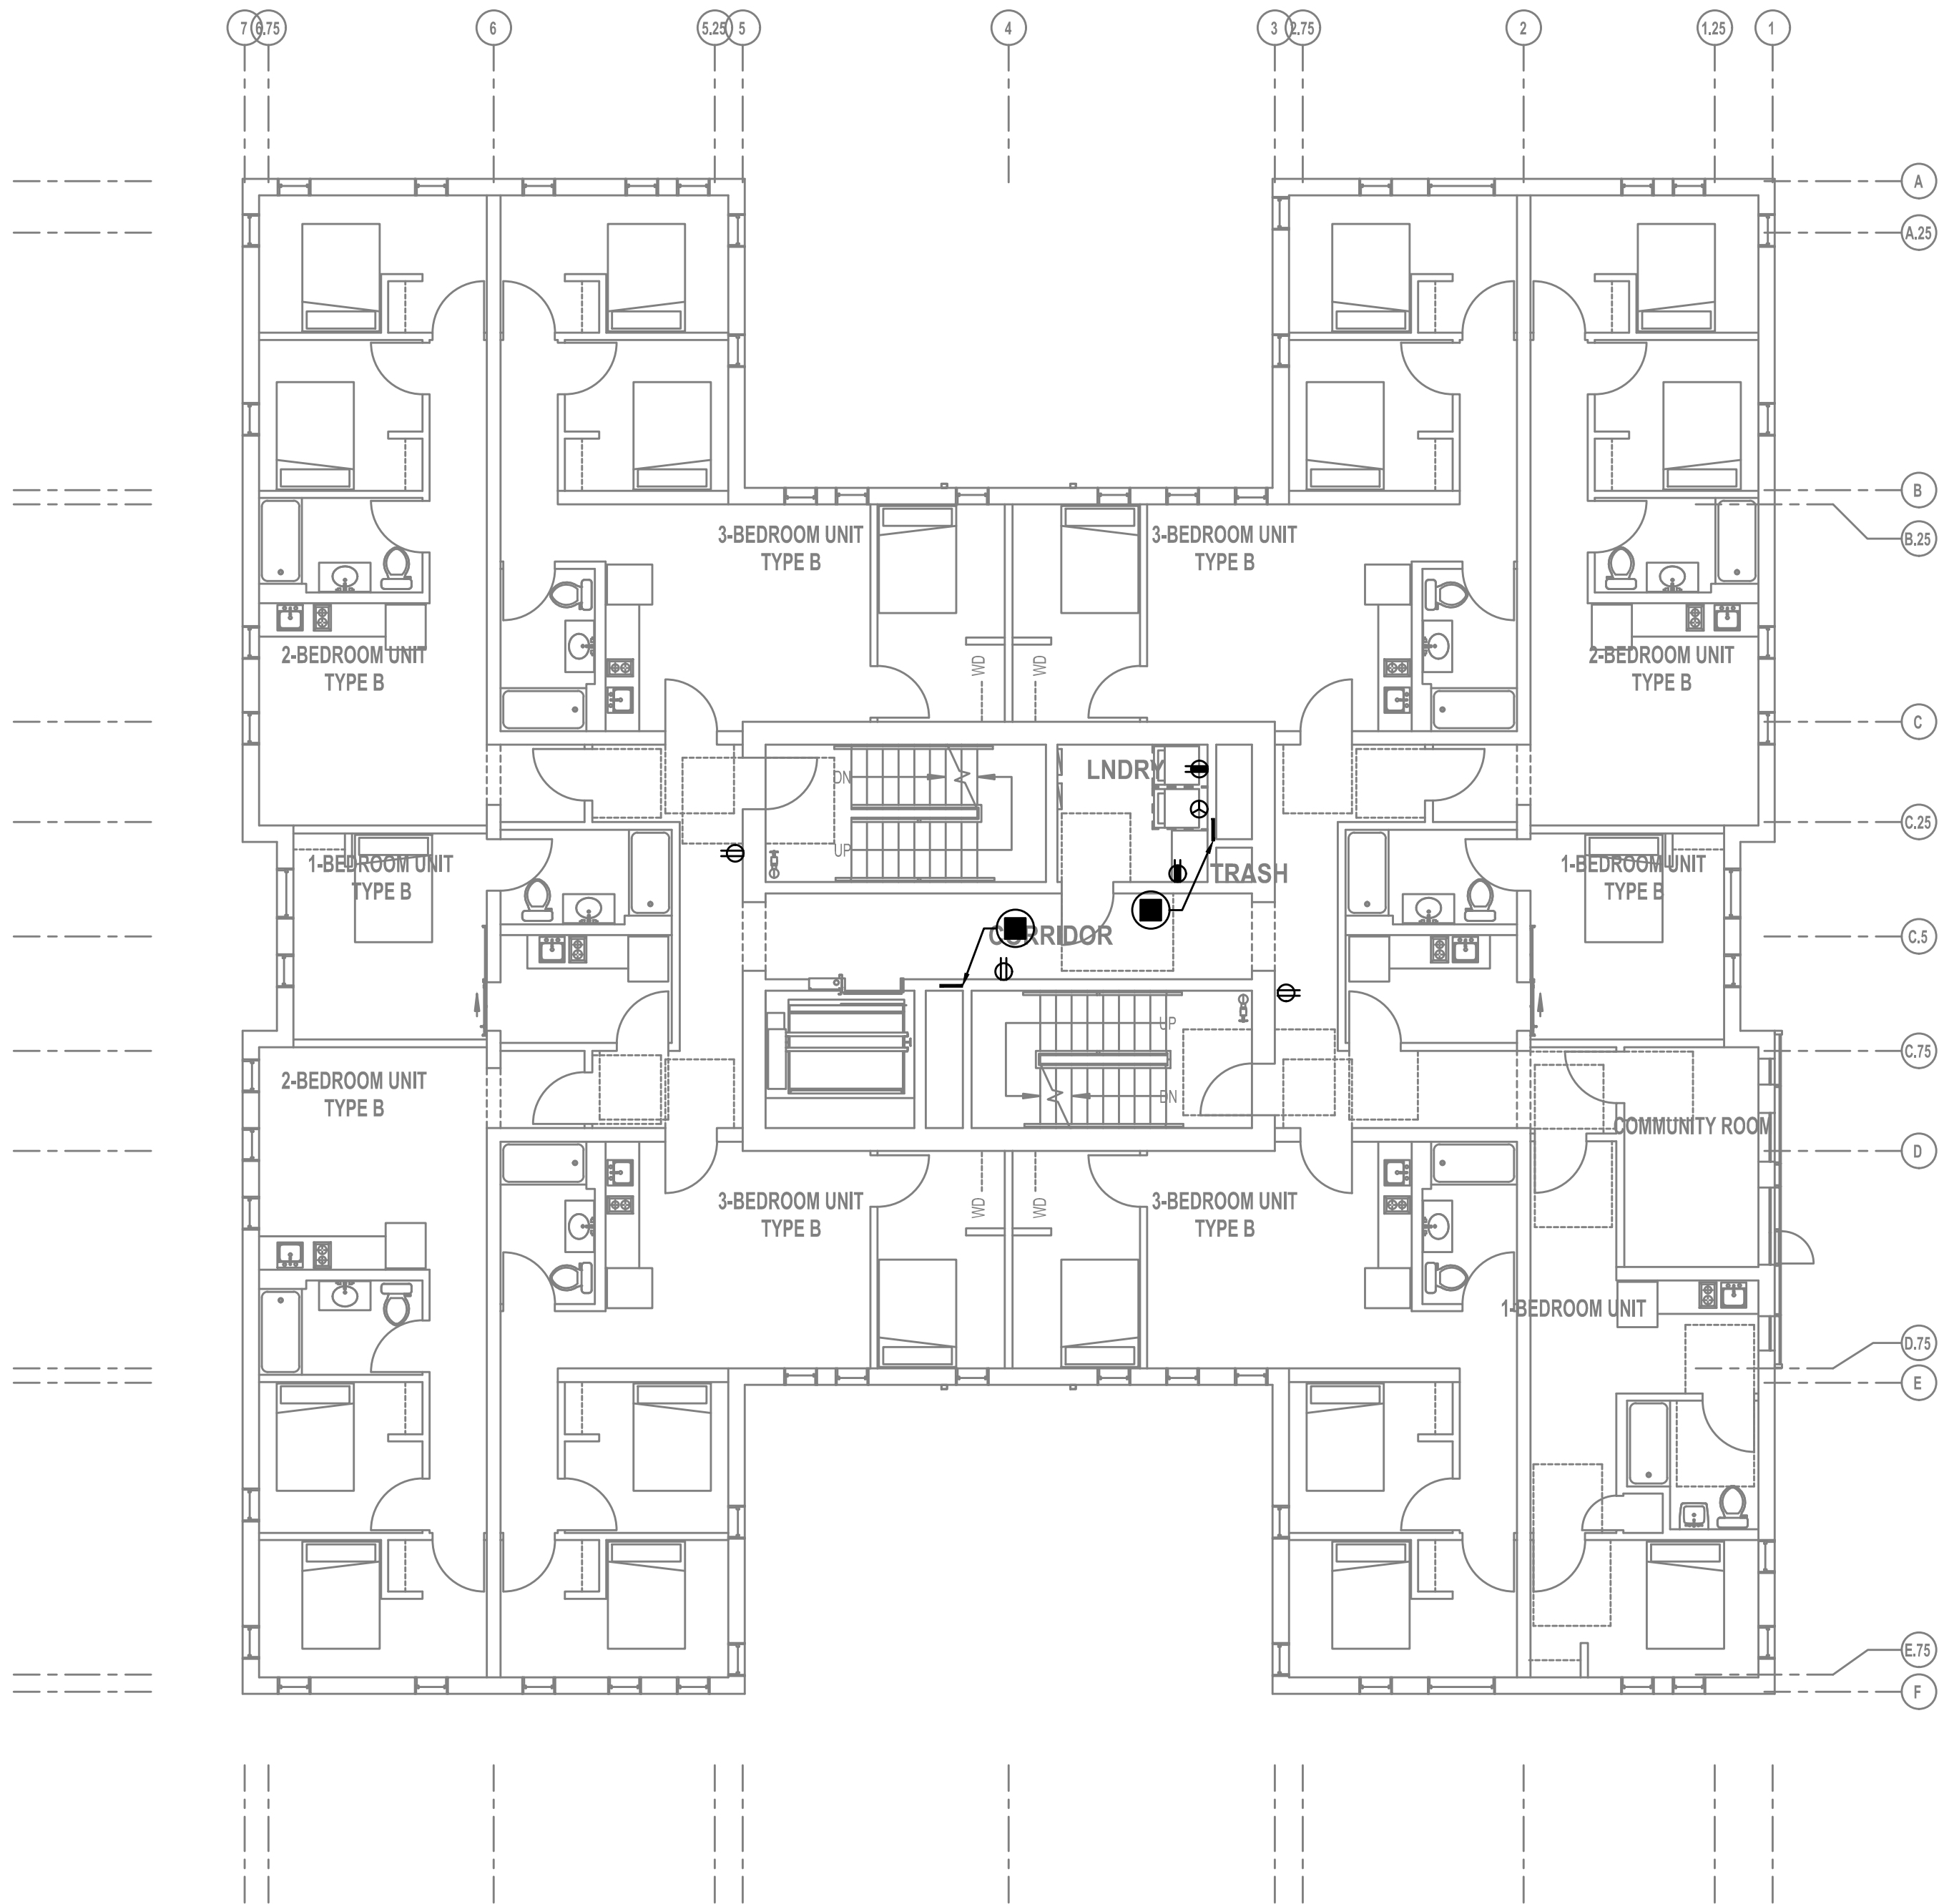

1 FOURTH FLOOR POWER PLAN
E3.04 SCALE: 1/8" = 1'-0"

GENERAL POWER NOTES:

- A. ELECTRICAL DRAWINGS ARE DIAGRAMMATICAL AND MAY NOT ACCURATELY REFLECT ACTUAL CONSTRUCTION CONDITIONS. THE ELECTRICAL CONTRACTOR SHALL BE RESPONSIBLE FOR COORDINATING THE INSTALLATION OF ALL ELECTRICAL EQUIPMENT, WITH ALL TRADES PRIOR TO AND DURING CONSTRUCTION.
- B. WORK SHALL BE IN ACCORDANCE WITH ALL APPLICABLE LOCAL, STATE AND NATIONAL CODES.
- C. ELECTRICAL CONTRACTOR TO PROVIDE THERMOSTATS NOT SUPPLIED BY MECHANICAL CONTRACTOR, AS REQUIRED. CONSULT MECHANICAL PLANS FOR ADDITIONAL INFORMATION.
- D. ELECTRICAL CONTRACTOR SHALL PROVIDE INSTALLATION AND FINAL CONNECTION OF THERMOSTATS AS REQUIRED. CONSULT MECHANICAL CONTRACTOR FOR EXACT REQUIREMENTS PRIOR TO ROUGH IN.
- E. COORDINATE WITH DIVISION 23 FOR EXACT LOCATION AND POWER REQUIREMENTS OF ALL MECHANICAL EQUIPMENT PRIOR TO ROUGH IN. REFER TO SHEET E1.13 FOR MECHANICAL EQUIPMENT SCHEDULE.
- F. THE ELECTRICAL CONTRACTOR SHALL REFER TO THE ARCHITECTURAL DRAWINGS FOR ALL MOUNTING HEIGHTS AND FINISHES OF DEVICES AND FIXTURES.
- G. ELECTRICAL CONTRACTOR SHALL REFER TO THE 'T' SERIES SHEETS AND PROVIDE ROUGH IN FOR THE LOW VOLTAGE SYSTEMS/FIRE ALARM INSTALLER.
- H. SERVICE ENTRANCE AND METERING EQUIPMENT SHOWN TO APPROXIMATE SCALE, BASED ON SIEMENS PRODUCTS. CONTRACTOR SHALL BE RESPONSIBLE FOR ENSURING THAT INSTALLED EQUIPMENT FITS THE SPACE PROVIDED AND THAT ALL REQUIRED WORKING CLEARANCES ARE PROVIDED.
- J. PROVIDE A KEY BOX AT THE TRANSFORMER ROOM DOOR PER THE UTILITY PROVIDER'S REQUIREMENTS, FOR 24/7 ACCESS.
- L. REFER TO 'E4' SERIES SHEETS FOR TYPICAL DWELLING UNIT POWER PLANS.

KEYED POWER NOTES:

- 1. PROVIDE KEY BOX FOR PGE AT METER ROOM FOR 24/7 ACCESS.
- 2. GENERATOR EMERGENCY DISCONNECT.
- 3. LAUNDRY ROOM GFCI RECEPTACLES FOR WASHING MACHINES TO BE MOUNTED AT 42" A.F.F., OR UNLESS OTHERWISE DIRECTED BY THE ARCHITECT. LAUNDRY ROOM APPLIANCES CIRCUITED TO PANEL 'XX'. REFER TO PANEL SCHEDULE ON SHEET E1.12.
- 4. 40A, DEDICATED 14-40R DRYER RECEPTACLE (TYPICAL). VERIFY EXACT POWER RATING REQUIRED FOR THE COMMERCIAL DRYERS PRIOR TO ORDERING. LAUNDRY ROOM APPLIANCES CIRCUITED TO PANEL 'XX'. REFER TO PANEL SCHEDULE ON SHEET E1.12.
- 5. EXHAUST FAN IN THIS AREA TO BE TIED INTO THE LIGHTING CIRCUIT.
- 6. CONSULT ELEVATOR PROVIDER FOR EXACT POWER REQUIREMENTS AND PROVIDE ALL ELECTRICAL WORK AS DIRECTED. VERIFY EXACT LOCATION FOR ELEVATOR EQUIPMENT WITH ARCHITECT AND COORDINATE WITH ELEVATOR INSTALLER.
- 7. PROVIDE ROUGH IN AND WIRING FOR ACCESS CONTROL. REFER TO 'T' SERIES SHEETS FOR ADDITIONAL INFORMATION.
- 8. LOW VOLTAGE/COMMUNICATIONS SYSTEM DEMARCATION BOARD(S). COORDINATE LOCATIONS AND ELECTRICAL POWER REQUIREMENTS WITH THE TELECOM PLANS ('T' SERIES SHEETS) AND LOW VOLTAGE SYSTEMS INSTALLERS. PROVIDE ROUGH IN AND/OR FINAL ELECTRICAL POWER CONNECTIONS & DEVICES. REFER PANEL 'XX' SCHEDULE ON E1.12 FOR CIRCUITS.
- 9. REFER TO SHEET E1.12 FOR TYPICAL DWELLING UNIT LOAD CENTER SCHEDULE FOR CIRCUITING INFORMATION.
- 10. REFER TO E2 SERIES SHEETS FOR EXHAUST FAN SWITCH LOCATION (WHERE INSTALLED).
- 11. EACH UNIT LOAD CENTER TO BE FED VIA SUB-METERING SYSTEM. REFER TO ONE-LINE DIAGRAM ON SHEET E1.11 FOR CONDUCTOR SIZE AND CABLING.

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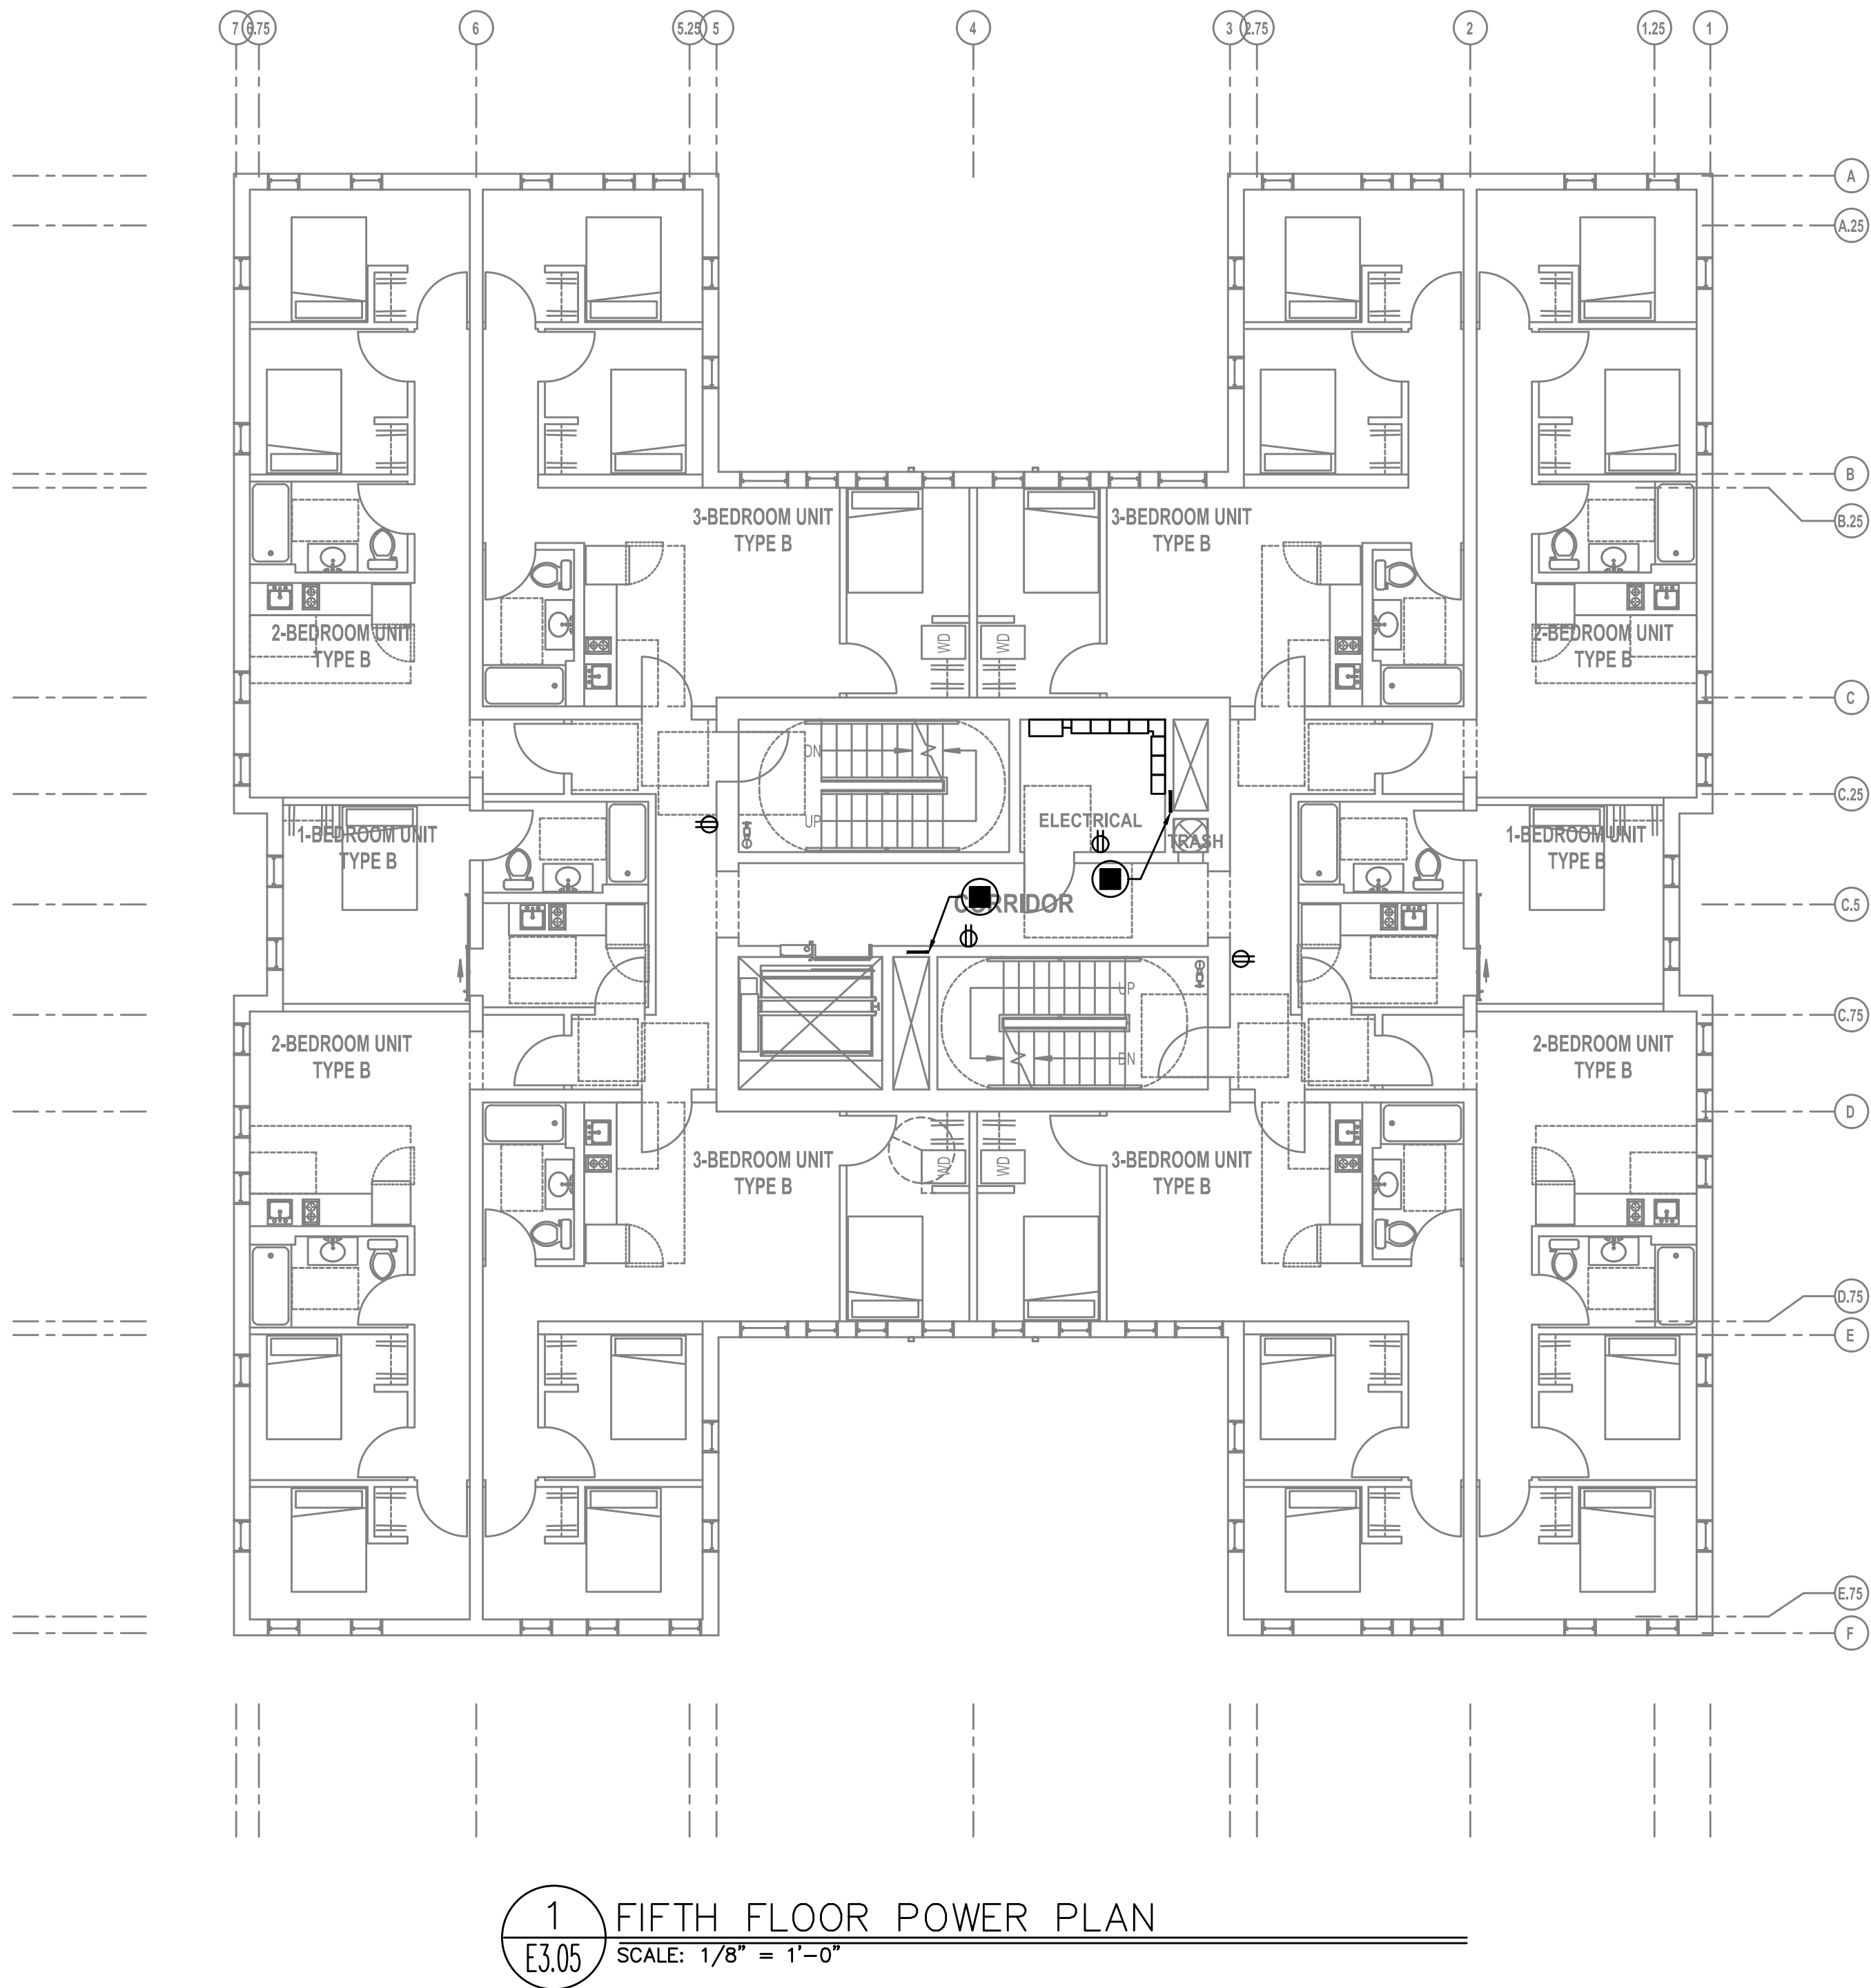
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FOURTH FLOOR
POWER PLAN



GENERAL POWER NOTES:

- A. ELECTRICAL DRAWINGS ARE DIAGRAMMATICAL AND MAY NOT ACCURATELY REFLECT ACTUAL CONSTRUCTION CONDITIONS. THE ELECTRICAL CONTRACTOR SHALL BE RESPONSIBLE FOR COORDINATING THE INSTALLATION OF ALL ELECTRICAL EQUIPMENT, WITH ALL TRADES PRIOR TO AND DURING CONSTRUCTION.
- B. WORK SHALL BE IN ACCORDANCE WITH ALL APPLICABLE LOCAL, STATE AND NATIONAL CODES.
- C. ELECTRICAL CONTRACTOR TO PROVIDE THERMOSTATS NOT SUPPLIED BY MECHANICAL CONTRACTOR, AS REQUIRED. CONSULT MECHANICAL PLANS FOR ADDITIONAL INFORMATION.
- D. ELECTRICAL CONTRACTOR SHALL PROVIDE INSTALLATION AND FINAL CONNECTION OF THERMOSTATS AS REQUIRED. CONSULT MECHANICAL CONTRACTOR FOR EXACT REQUIREMENTS PRIOR TO ROUGH IN.
- E. COORDINATE WITH DIVISION 23 FOR EXACT LOCATION AND POWER REQUIREMENTS OF ALL MECHANICAL EQUIPMENT PRIOR TO ROUGH IN. REFER TO SHEET E1.13 FOR MECHANICAL EQUIPMENT SCHEDULE.
- F. THE ELECTRICAL CONTRACTOR SHALL REFER TO THE ARCHITECTURAL DRAWINGS FOR ALL MOUNTING HEIGHTS AND FINISHES OF DEVICES AND FIXTURES.
- G. ELECTRICAL CONTRACTOR SHALL REFER TO THE 'T' SERIES SHEETS AND PROVIDE ROUGH IN FOR THE LOW VOLTAGE SYSTEMS/FIRE ALARM INSTALLER.
- H. SERVICE ENTRANCE AND METERING EQUIPMENT SHOWN TO APPROXIMATE SCALE, BASED ON SIEMENS PRODUCTS. CONTRACTOR SHALL BE RESPONSIBLE FOR ENSURING THAT INSTALLED EQUIPMENT FITS THE SPACE PROVIDED AND THAT ALL REQUIRED WORKING CLEARANCES ARE PROVIDED.
- J. PROVIDE A KEY BOX AT THE TRANSFORMER ROOM DOOR PER THE UTILITY PROVIDER'S REQUIREMENTS, FOR 24/7 ACCESS.
- L. REFER TO 'E4' SERIES SHEETS FOR TYPICAL DWELLING UNIT POWER PLANS.

KEYED POWER NOTES:

- 1. PROVIDE KEY BOX FOR PGE AT METER ROOM FOR 24/7 ACCESS.
- 2. GENERATOR EMERGENCY DISCONNECT.
- 3. LAUNDRY ROOM GFCI RECEPTACLES FOR WASHING MACHINES TO BE MOUNTED AT 42" A.F.F., OR UNLESS OTHERWISE DIRECTED BY THE ARCHITECT. LAUNDRY ROOM APPLIANCES CIRCUITED TO PANEL 'XX'. REFER TO PANEL SCHEDULE ON SHEET E1.12.
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- 5. EXHAUST FAN IN THIS AREA TO BE TIED INTO THE LIGHTING CIRCUIT.
- 6. CONSULT ELEVATOR PROVIDER FOR EXACT POWER REQUIREMENTS AND PROVIDE ALL ELECTRICAL WORK AS DIRECTED. VERIFY EXACT LOCATION FOR ELEVATOR EQUIPMENT WITH ARCHITECT AND COORDINATE WITH ELEVATOR INSTALLER.
- 7. PROVIDE ROUGH IN AND WIRING FOR ACCESS CONTROL. REFER TO 'T' SERIES SHEETS FOR ADDITIONAL INFORMATION.
- 8. LOW VOLTAGE/COMMUNICATIONS SYSTEM DEMARCATION BOARD(S). COORDINATE LOCATIONS AND ELECTRICAL POWER REQUIREMENTS WITH THE TELECOM PLANS ('T' SERIES SHEETS) AND LOW VOLTAGE SYSTEMS INSTALLERS. PROVIDE ROUGH IN AND/OR FINAL ELECTRICAL POWER CONNECTIONS & DEVICES. REFER PANEL 'XX' SCHEDULE ON E1.12 FOR CIRCUITS.
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- 11. EACH UNIT LOAD CENTER TO BE FED VIA SUB-METERING SYSTEM. REFER TO ONE-LINE DIAGRAM ON SHEET E1.11 FOR CONDUCTOR SIZE AND CABLING.

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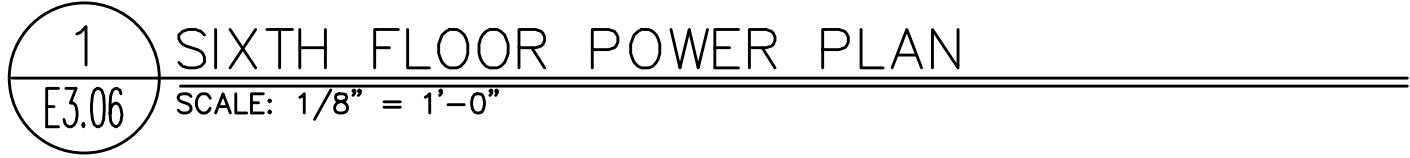
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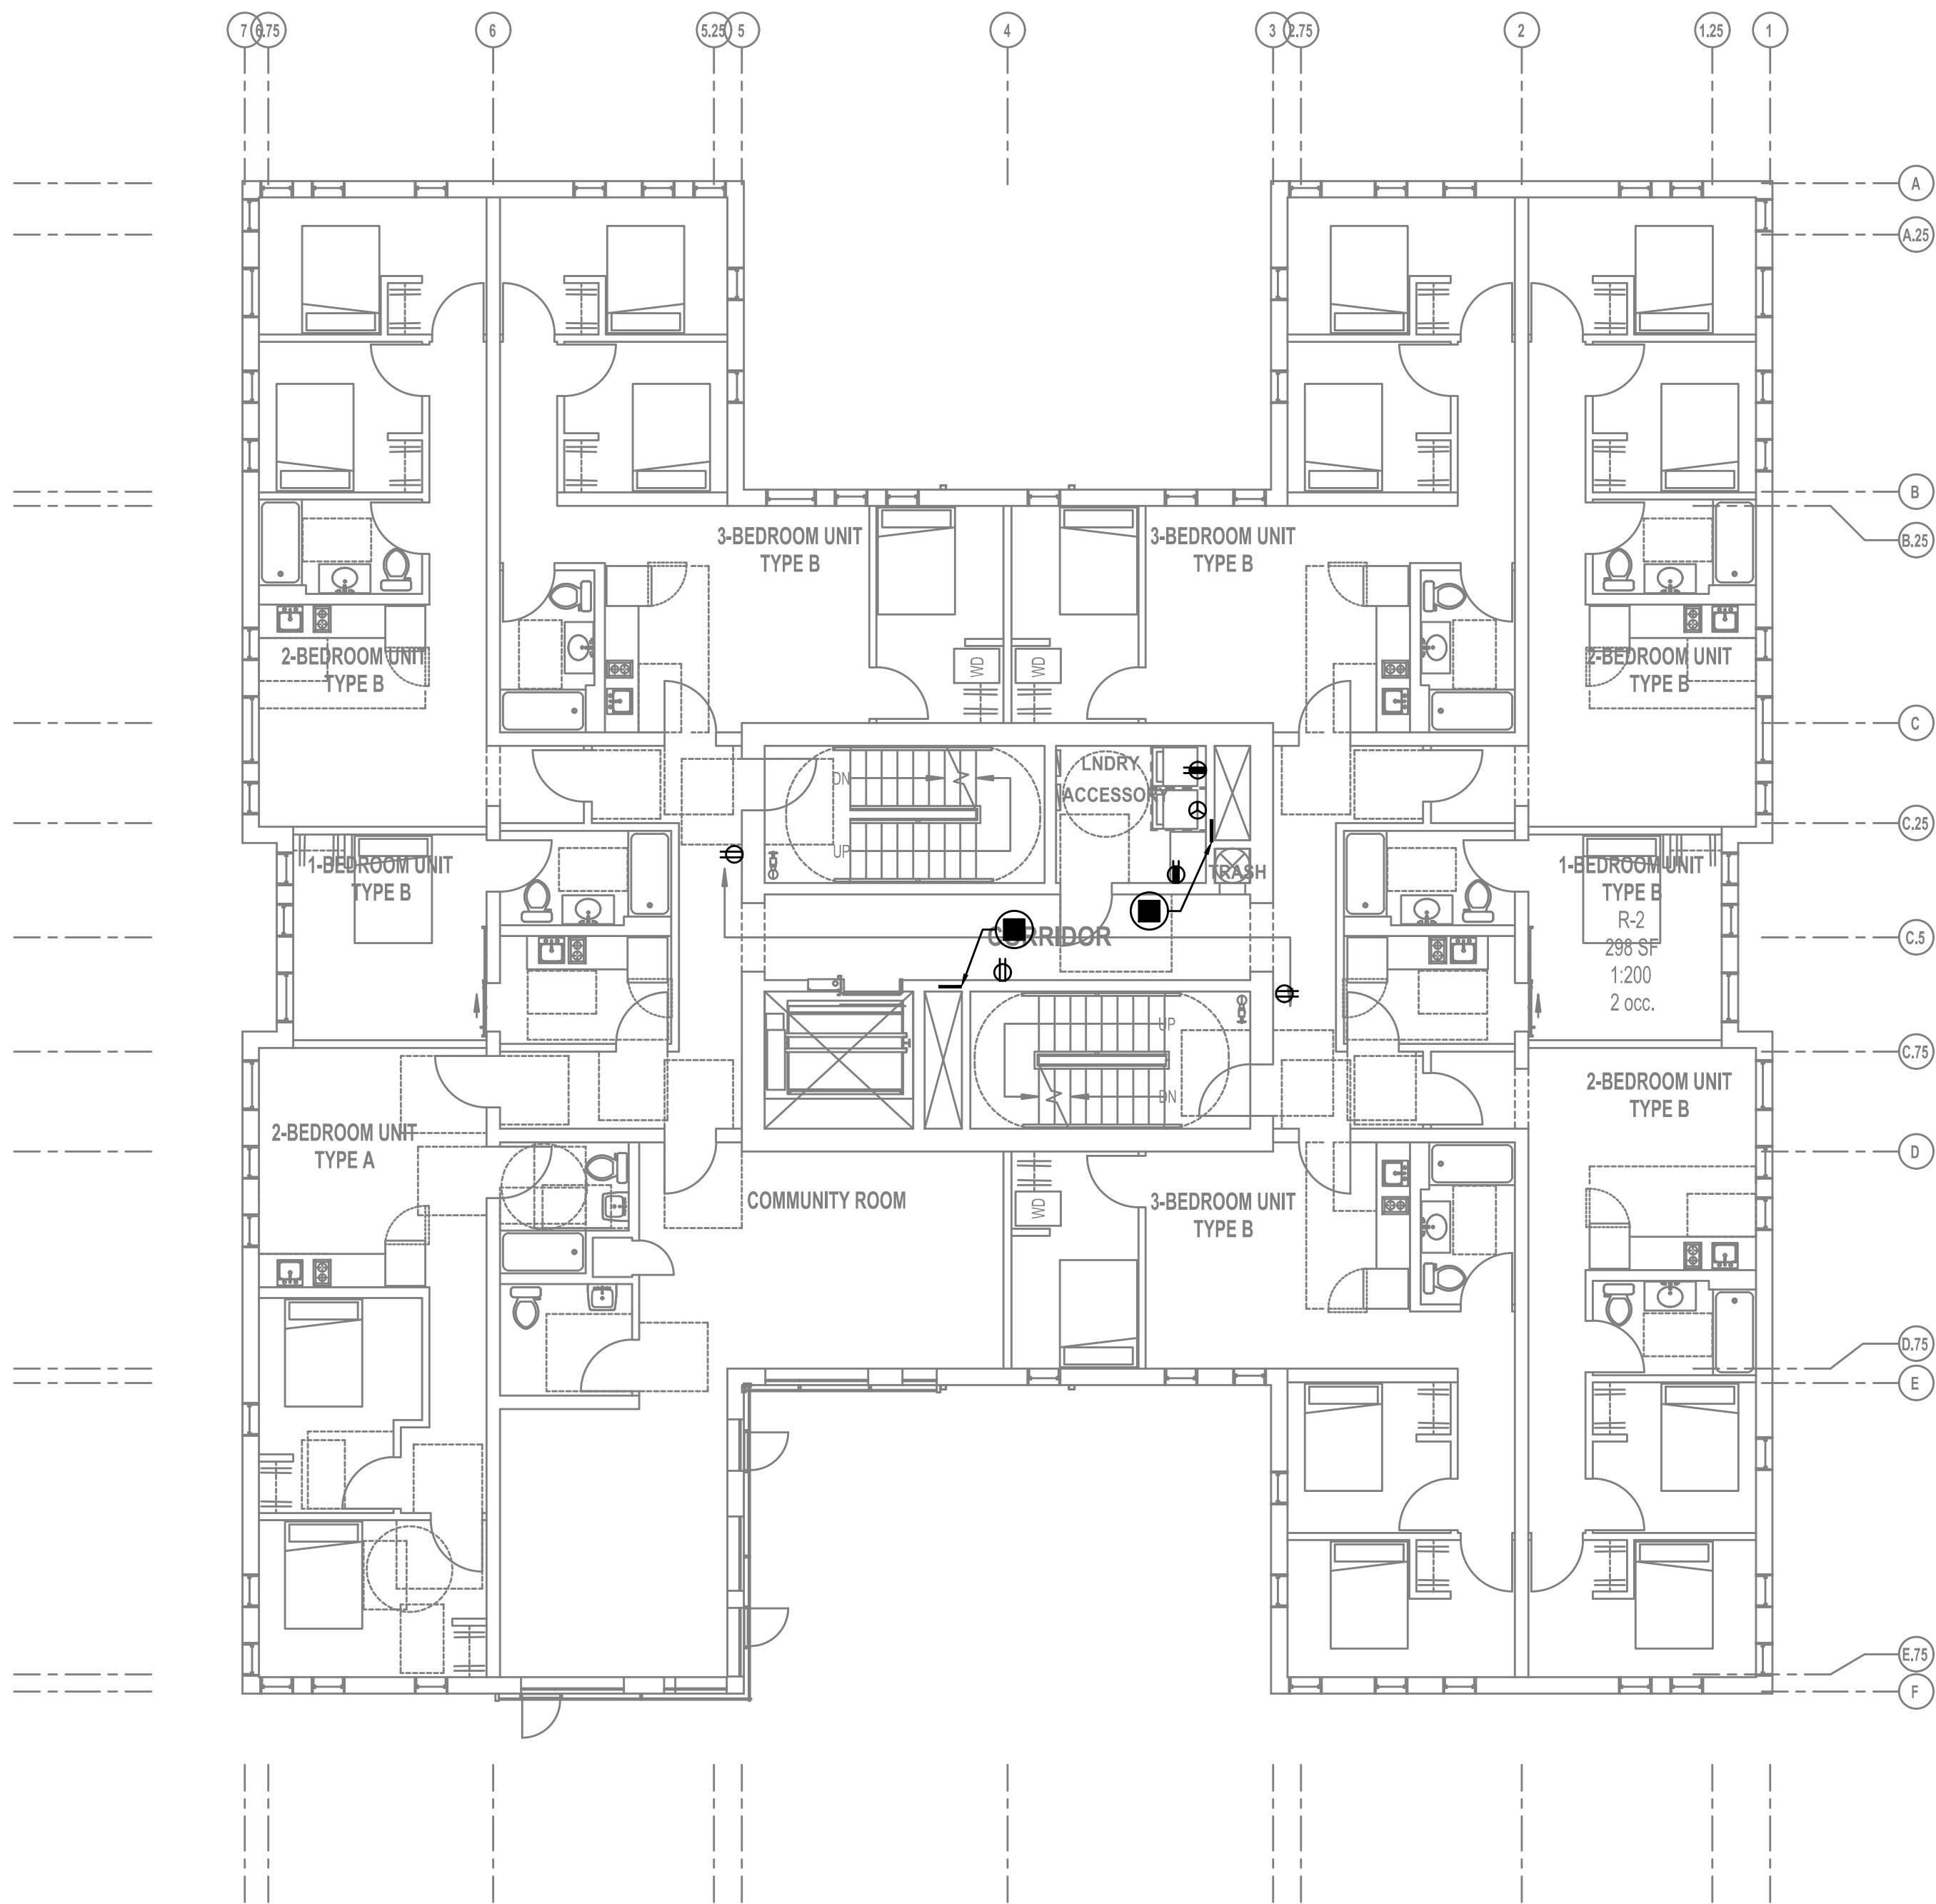
FIFTH FLOOR
POWER PLAN

Drawing Number
E3.05



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- F. THE ELECTRICAL CONTRACTOR SHALL REFER TO THE ARCHITECTURAL DRAWINGS FOR ALL MOUNTING HEIGHTS AND FINISHES OF DEVICES AND FIXTURES.
- G. ELECTRICAL CONTRACTOR SHALL REFER TO THE 'T' SERIES SHEETS AND PROVIDE ROUGH IN FOR THE LOW VOLTAGE SYSTEMS/FIRE ALARM INSTALLER.
- H. SERVICE ENTRANCE AND METERING EQUIPMENT SHOWN TO APPROXIMATE SCALE, BASED ON SIEMENS PRODUCTS. CONTRACTOR SHALL BE RESPONSIBLE FOR ENSURING THAT INSTALLED EQUIPMENT FITS THE SPACE PROVIDED AND THAT ALL REQUIRED WORKING CLEARANCES ARE PROVIDED.
- J. PROVIDE A KEY BOX AT THE TRANSFORMER ROOM DOOR PER THE UTILITY PROVIDER'S REQUIREMENTS, FOR 24/7 ACCESS.
- L. REFER TO 'E4' SERIES SHEETS FOR TYPICAL DWELLING UNIT POWER PLANS.

1. PROVIDE KEY BOX FOR PGE AT METER ROOM FOR 24/7 ACCESS.
2. GENERATOR EMERGENCY DISCONNECT.
3. LAUNDRY ROOM GFCI RECEPTACLES FOR WASHING MACHINES TO BE MOUNTED AT 42" A.F.F., OR UNLESS OTHERWISE DIRECTED BY THE ARCHITECT. LAUNDRY ROOM APPLIANCES CIRCUITED TO PANEL 'XX'. REFER TO PANEL SCHEDULE ON SHEET E1.12.
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9. REFER TO SHEET E1.12 FOR TYPICAL DWELLING UNIT LOAD CENTER SCHEDULE FOR CIRCUITING INFORMATION.
10. REFER TO E2 SERIES SHEETS FOR EXHAUST FAN SWITCH LOCATION (WHERE INSTALLED).
11. EACH UNIT LOAD CENTER TO BE FED VIA SUB-METERING SYSTEM. REFER TO ONE-LINE DIAGRAM ON SHEET E1.11 FOR CONDUCTOR SIZE AND CABLING.



1 SEVENTH FLOOR POWER PLAN
E3.07 SCALE: 1/8" = 1'-0"

GENERAL POWER NOTES:

- A. ELECTRICAL DRAWINGS ARE DIAGRAMMATICAL AND MAY NOT ACCURATELY REFLECT ACTUAL CONSTRUCTION CONDITIONS. THE ELECTRICAL CONTRACTOR SHALL BE RESPONSIBLE FOR COORDINATING THE INSTALLATION OF ALL ELECTRICAL EQUIPMENT, WITH ALL TRADES PRIOR TO AND DURING CONSTRUCTION.
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- E. COORDINATE WITH DIVISION 23 FOR EXACT LOCATION AND POWER REQUIREMENTS OF ALL MECHANICAL EQUIPMENT PRIOR TO ROUGH IN. REFER TO SHEET E1.13 FOR MECHANICAL EQUIPMENT SCHEDULE.
- F. THE ELECTRICAL CONTRACTOR SHALL REFER TO THE ARCHITECTURAL DRAWINGS FOR ALL MOUNTING HEIGHTS AND FINISHES OF DEVICES AND FIXTURES.
- G. ELECTRICAL CONTRACTOR SHALL REFER TO THE 'T' SERIES SHEETS AND PROVIDE ROUGH IN FOR THE LOW VOLTAGE SYSTEMS/FIRE ALARM INSTALLER.
- H. SERVICE ENTRANCE AND METERING EQUIPMENT SHOWN TO APPROXIMATE SCALE, BASED ON SIEMENS PRODUCTS. CONTRACTOR SHALL BE RESPONSIBLE FOR ENSURING THAT INSTALLED EQUIPMENT FITS THE SPACE PROVIDED AND THAT ALL REQUIRED WORKING CLEARANCES ARE PROVIDED.
- J. PROVIDE A KEY BOX AT THE TRANSFORMER ROOM DOOR PER THE UTILITY PROVIDER'S REQUIREMENTS, FOR 24/7 ACCESS.
- L. REFER TO 'E4' SERIES SHEETS FOR TYPICAL DWELLING UNIT POWER PLANS.

KEYED POWER NOTES:

- 1. PROVIDE KEY BOX FOR PGE AT METER ROOM FOR 24/7 ACCESS.
- 2. GENERATOR EMERGENCY DISCONNECT.
- 3. LAUNDRY ROOM GFCI RECEPTACLES FOR WASHING MACHINES TO BE MOUNTED AT 42" A.F.F., OR UNLESS OTHERWISE DIRECTED BY THE ARCHITECT. LAUNDRY ROOM APPLIANCES CIRCUITED TO PANEL 'XX'. REFER TO PANEL SCHEDULE ON SHEET E1.12.
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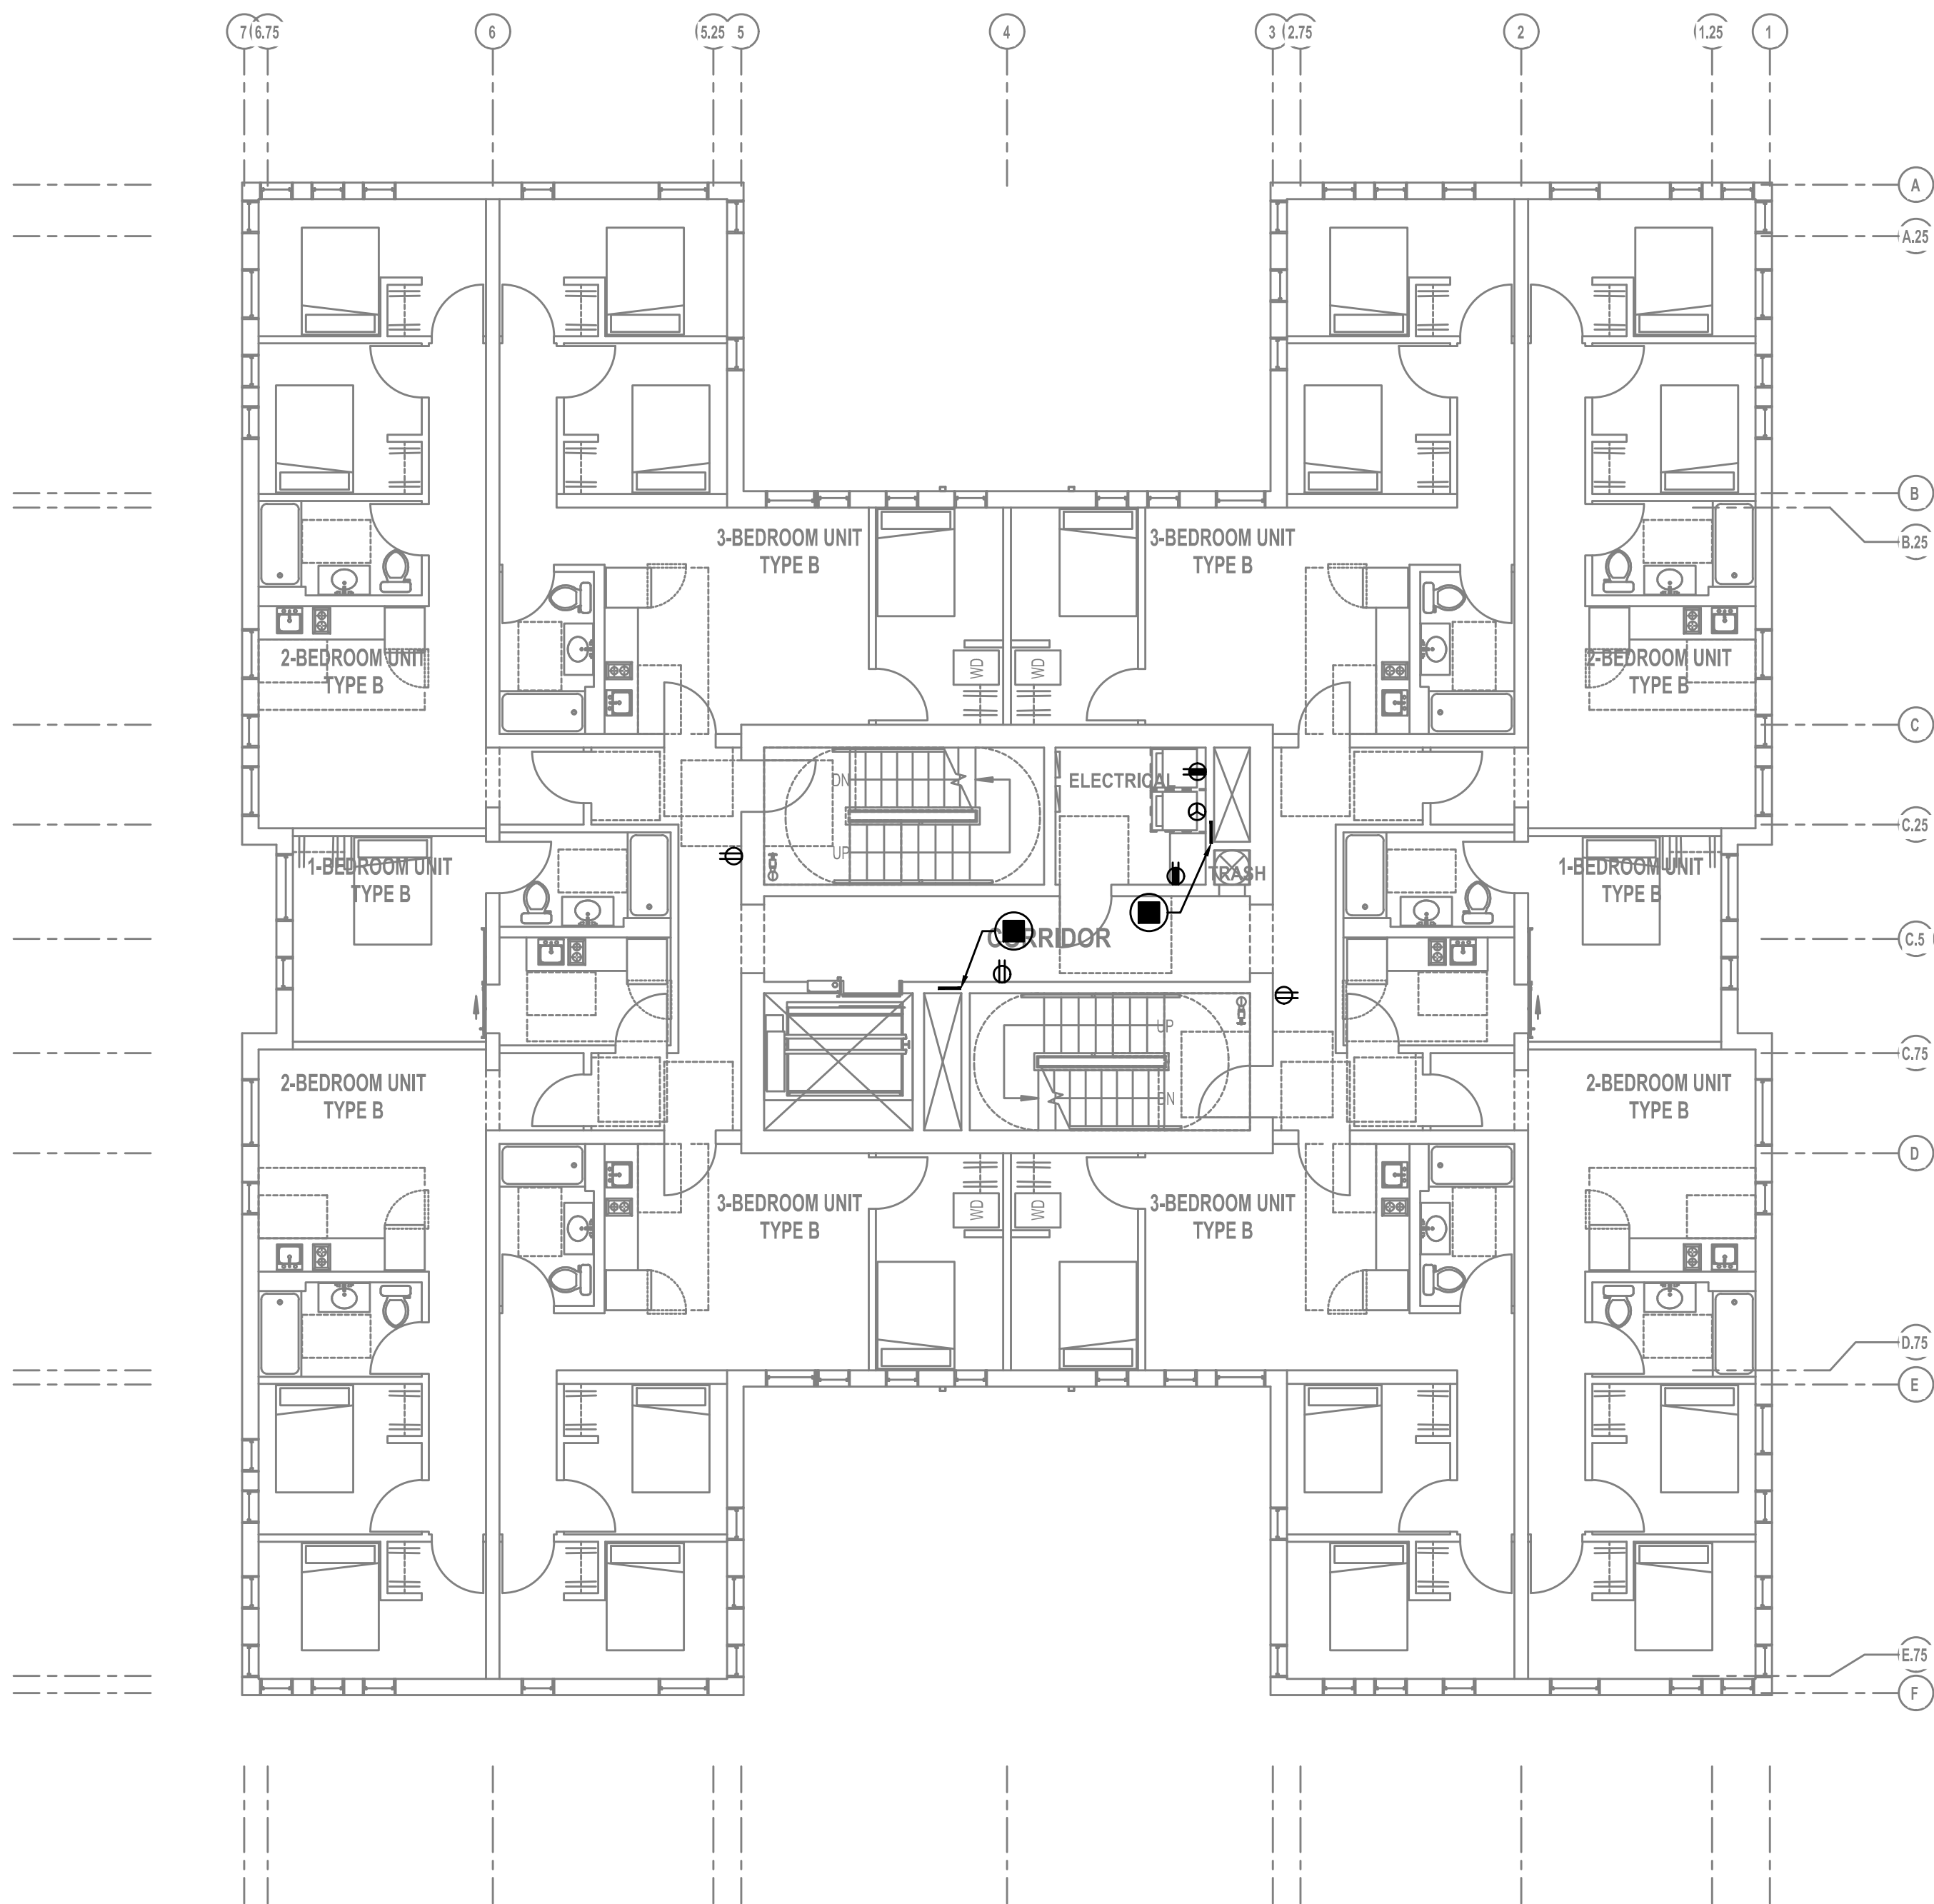
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SEVENTH FLOOR
POWER PLAN



1 EIGHTH FLOOR POWER PLAN
E3.08 SCALE: 1/8" = 1'-0"

GENERAL POWER NOTES:

- A. ELECTRICAL DRAWINGS ARE DIAGRAMMATICAL AND MAY NOT ACCURATELY REFLECT ACTUAL CONSTRUCTION CONDITIONS. THE ELECTRICAL CONTRACTOR SHALL BE RESPONSIBLE FOR COORDINATING THE INSTALLATION OF ALL ELECTRICAL EQUIPMENT, WITH ALL TRADES PRIOR TO AND DURING CONSTRUCTION.
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- F. THE ELECTRICAL CONTRACTOR SHALL REFER TO THE ARCHITECTURAL DRAWINGS FOR ALL MOUNTING HEIGHTS AND FINISHES OF DEVICES AND FIXTURES.
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KEYED POWER NOTES:

- 1. PROVIDE KEY BOX FOR PGE AT METER ROOM FOR 24/7 ACCESS.
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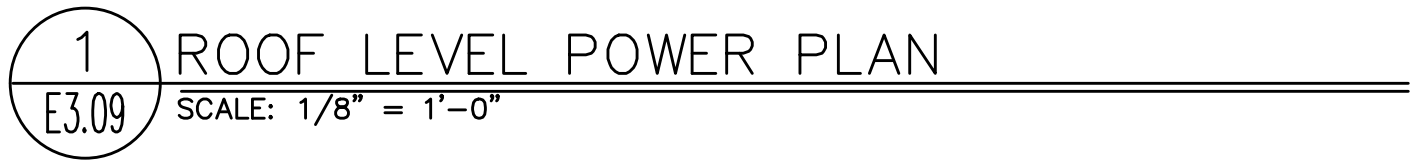
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EIGHTH FLOOR
POWER PLAN

Drawing Number
E3.08



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- G. ELECTRICAL CONTRACTOR SHALL REFER TO THE 'T' SERIES SHEETS AND PROVIDE ROUGH IN FOR THE LOW VOLTAGE SYSTEMS/FIRE ALARM INSTALLER.
- H. SERVICE ENTRANCE AND METERING EQUIPMENT SHOWN TO APPROXIMATE SCALE, BASED ON SIEMENS PRODUCTS. CONTRACTOR SHALL BE RESPONSIBLE FOR ENSURING THAT INSTALLED EQUIPMENT FITS THE SPACE PROVIDED AND THAT ALL REQUIRED WORKING CLEARANCES ARE PROVIDED.
- J. PROVIDE A KEY BOX AT THE TRANSFORMER ROOM DOOR PER THE UTILITY PROVIDER'S REQUIREMENTS, FOR 24/7 ACCESS.
- L. REFER TO 'E4' SERIES SHEETS FOR TYPICAL DWELLING UNIT POWER PLANS.

1. PROVIDE KEY BOX FOR PGE AT METER ROOM FOR 24/7 ACCESS.
2. GENERATOR EMERGENCY DISCONNECT.
3. LAUNDRY ROOM GFCI RECEPTACLES FOR WASHING MACHINES TO BE MOUNTED AT 42" A.F.F., OR UNLESS OTHERWISE DIRECTED BY THE ARCHITECT. LAUNDRY ROOM APPLIANCES CIRCUITED TO PANEL 'XX'. REFER TO PANEL SCHEDULE ON SHEET E1.12.
4. 40A, DEDICATED 14-40R DRYER RECEPTACLE (TYPICAL). VERIFY EXACT POWER RATING REQUIRED FOR THE COMMERCIAL DRYERS PRIOR TO ORDERING. LAUNDRY ROOM APPLIANCES CIRCUITED TO PANEL 'XX'. REFER TO PANEL SCHEDULE ON SHEET E1.12.
5. EXHAUST FAN IN THIS AREA TO BE TIED INTO THE LIGHTING CIRCUIT.
6. CONSULT ELEVATOR PROVIDER FOR EXACT POWER REQUIREMENTS AND PROVIDE ALL ELECTRICAL WORK AS DIRECTED. VERIFY EXACT LOCATION FOR ELEVATOR EQUIPMENT WITH ARCHITECT AND COORDINATE WITH ELEVATOR INSTALLER.
7. PROVIDE ROUGH IN AND WIRING FOR ACCESS CONTROL. REFER TO 'T' SERIES SHEETS FOR ADDITIONAL INFORMATION.
8. LOW VOLTAGE/COMMUNICATIONS SYSTEM DEMARCATION BOARD(S). COORDINATE LOCATIONS AND ELECTRICAL POWER REQUIREMENTS WITH THE TELECOM PLANS ('T' SERIES SHEETS) AND LOW VOLTAGE SYSTEMS INSTALLERS. PROVIDE ROUGH IN AND/OR FINAL ELECTRICAL POWER CONNECTIONS & DEVICES. REFER PANEL 'XX' SCHEDULE ON E1.12 FOR CIRCUITS.
9. REFER TO SHEET E1.12 FOR TYPICAL DWELLING UNIT LOAD CENTER SCHEDULE FOR CIRCUITING INFORMATION.
10. REFER TO E2 SERIES SHEETS FOR EXHAUST FAN SWITCH LOCATION (WHERE INSTALLED).
11. EACH UNIT LOAD CENTER TO BE FED VIA SUB-METERING SYSTEM. REFER TO ONE-LINE DIAGRAM ON SHEET E1.11 FOR CONDUCTOR SIZE AND CABLING.