


ACCESS CONTROL NOTES

- 1. 12"x12"x6" NEMA BOX, HOFFMAN OR APPROVED EQUAL, ON SECURED SIDE OF DOOR. TERMINATE (2) CATEGORY 6 CABLES INSIDE NEMA ENCLOSURE. SCHOOL DISTRICT WILL SUPPLY 'POE' DOOR CONTROLLER.
- 2. DOOR STATUS CONTACT, ONLY NEEDED WHEN STRIKE DOES NOT HAVE INTEGRAL SWITCH.
- 3. DOUBLE GANG BOX WITH SINGLE GANG REDUCER RING IF NEEDED BY SECURITY DEVICE.
 COORDINATE WITH ARCHITECT TO MEET ADA REQUIREMENTS. PROVIDE 24AWG, 12 CONDUCTOR TO DOOR CONTROLLER.
- 4. 'REX' ONLY NEEDED AT LOCATIONS WITH ELECTRIC STRIKE (CONFIRM WITH DOOR HARDWARE). PROVIDE 18AWG, 6 CONDUCTOR TO DOOR CONTROLLER.
- 5. 3" CONDUIT CONCEALED IN WALL WITH 16AWG 6 CONDUCTOR TO CRASH BAR OR ELECTRIC

ACCSS CONTROL DETAIL T2.1 SCALE: NOT TO SCALE

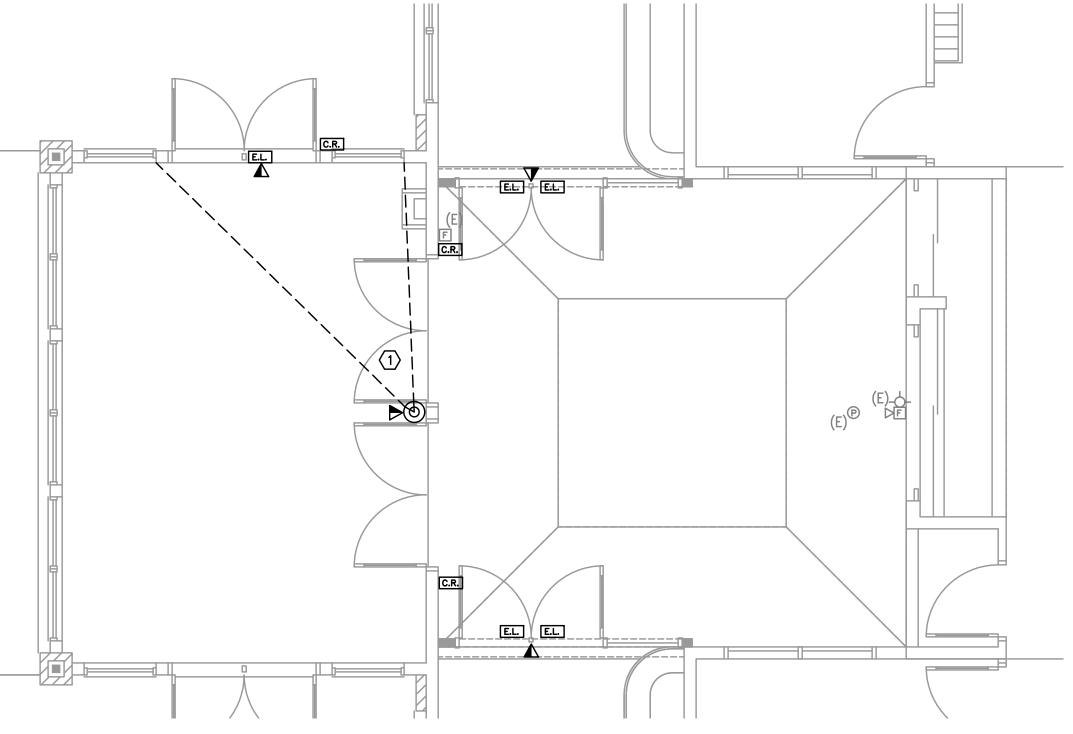


1 ENLARGED FLOOR PLAN — TELCOM T2.1 SCALE: 1/4" = 1'-0"

O NOTES:

- 1. APPROXIMATE VIEW REQUIRED OF CAMERA, VERIFY PROPER FRAMING OF VIEW WITH STAFF AT TIME OF INSTALLATION. PROVIDE (2) CATEGORY 6 CABLES FROM NEAREST MDF/IDF.
- 2. OUTPUT MODULE TO CONNECT FIRE ALARM PANEL TO POWER RELAY TO SHUT DOWN FANS WHEN FIRE ALARM ACTIVATED.



a Pine **Ridg**

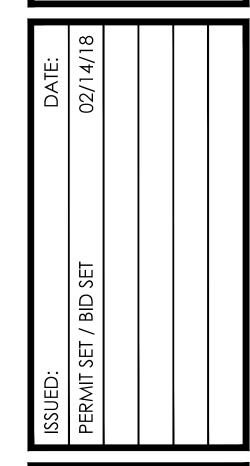

1		
	JOB NUMBER:	1708
	DRAWN BY:	GMA
	CHECKED BY:	RLC
ı		

SHEET TITLE ENLARGED FLOOR PLAN

SHEET NUMBER

Consulting Engineers 2007 S.E. Ash St. Portland, OR 97214 PHN: (503) 234-0548 FAX: (503) 234-0677 INC. WWW.MFIA-ENG.COM

CONTACT: GARY ADOVNIK